Midway City Council 17 January 2023 Regular Meeting

Ameyalli Resort, Phase 1 / Final Approval



CITY COUNCIL MEETING STAFF REPORT

DATE OF MEETING: January 17, 2023

NAME OF PROJECT: Ameyalli Resort Development

NAME OF APPLICANT: Midway Mtn. Spa LLC

AUTHORIZED REPRESENTATIVE: Chuck Heath

AGENDA ITEM: Ameyalli Resort Phase 1 Final

LOCATION OF ITEM: Approximately 800 North 200 East

ZONING DESIGNATION: Recreational and Resort Zone (RZ)

ITEM: 6

Chuck Heath, representative for Midway Mtn Spa LLC, has submitted a final application for Phase 1 of Ameyalli Resort on 28.87-acres. The final plan includes 24 duplex units and 2 family lodges, private road, public and private trails, and other resort related amenity improvements. The property is located at approximately 800 North 200 East and is in the Resort Zone.

BACKGROUND:

Chuck Heath of Midway Mtn Spa LLC is requesting final approval of Phase 1 of the Ameyalli Resort master plan (FKA Mt. Spa). The master plan includes a resort building, hotel rooms, cottage units, duplex units, family lodges, public and private trails, and other resort related amenities. The applicant will be bringing utilities into the property as well as constructing a connector road to Burgi Lane and to 600 North. Phase 1 includes approximately 16 acres. This phase includes 24 duplex units, two family lodges, private and public trails, open space, and other resort related amenity improvements. Phase 1 includes a major infrastructure improvement which is the road from 600 North to Burgi

Lane. The main road connecting Burgi Lane to 600 North will need to be constructed along with phase 1 to comply the access requirements for the phases. The resort core is 28.87-acres in size and is being developed in four phases. All roads in the development will be private roads. There will be 15.95-acres (55.2%) of open space included in the development. There will also be a mix of public and private trails throughout the development.

The applicant has stated that the intent is that all units are rentable, including duplex units and family lodges in phase 1. The City has received a preliminary plat, which is required for final approval, and the proposed plat will be a planned unit development plat with building pads for each of the units. The applicant has stated that, through Ameyalli's Codes, Covenants, and Restrictions (CC&Rs), the units will not be lived in year-round but will be vacation properties that are put into a rental pool when not being used by the owners. Because hotel rooms and nightly rentals are a benefit to the community in various ways (resort tax, transient room tax, patrons for restaurants and commercial businesses), the resort zone limits residential units that allow stays of 30 days or longer to 10% of the gross master plan floor area. The total building square footage of the property is 212,445 square feet which limits the number of duplexes units that could be lived in more than 30 days to about 16 units. The rest of the units in the resort which includes the eight other duplexes, two family lodges, all the cottages, hotels, and presidential suite would need to be rented on a less than 30-day basis.

The Mountain Spa was established in the 1880s and operated as a resort focused on pools, using the geothermal water found on site, and as a gathering area for the community. The resort was active until the 1980s and then shut down. The site has gone into disrepair and the recreational facilities and buildings are now dilapidated.

There has been interest in developing the property since that time. One of the most recent proposals that received approvals from the City was in 2008 when a large resort was proposed on the property. The approved resort included hotels, promenade, bungalows, and the Old Mountain Spa Village. The approval also included a planned unit development (PUD) in the area zoned R-1-22 which was approved for 63 units. Since the approval, the entitlement for the resort has lapsed until in the past few years when a collaboration was formed between Chuck Heath, Summit Land Conservancy, Midway, and Wasatch County. The four entities all worked together and were able place conservation easements on roughly 46 acres (Lot 2 and Lot 4 of the Mountain Spa Rural Preservation Subdivision and an 8.81 parcel in the center of the resort core).

The Mountain Spa property itself is fascinating because of the natural environment features found on the property. The property has geothermal springs and craters filled with warm water. There is a large area of pot rock around the springs and craters which are considered a major geologic feature area by Midway City and protected as part of the sensitive lands code. There are also wetland areas on the property along with agricultural area that includes about 15 acres of irrigated field and a large pasture located on the north end of the property (now preserved with a conservation easement). Because of these features and because of the Mountain Spa's prominent location on the north end of

Midway, the City has planned for trails to cross the property in two locations. There is a large linear park trail that is planned to connect from the Valais Park in the north to the Watts Remund Farms PUD in the south. This trail will connect the north end of the City down to Main Street and will create a trail that will generally not parallel roads and will create a safe environment for pedestrians to travel from one area of the Midway to another. The City has also planned a trail along River Road and has recently installed a temporary trail in the River Road right-of-way. It is anticipated that with this proposal a new trail will be constructed on the Mountain Spa property along the River Road right-of-way that will be farther from the road and will create a safer pedestrian experience for the trail. The City has also secured an easement and funding to connect the River Road trail with the linear park trail on the property that would run east and west across the southern boundary of Lacy Lane Estates.

The property fronts two of the busiest roads in Midway which includes River Road and Burgi Lane. These two roads act as the entry into Midway and by preserving the properties as open space, Midway has ensured a beautiful and natural entry corridor to the City that benefits residents and tourists alike.

The Mountain Spa resort is an important heritage landmark in Midway. The Mountain Spa can be an important economic driver in Midway for both economic activity that has a residual impact on other businesses but also an important tax revenue source for the City which, in turn, helps keep property taxes low which is a benefit to all residents of Midway.

Sensitive land area located on the property will be left undisturbed as required by the land use ordinance. These sensitive lands include 25% and greater slopes, hot pots and pot rock outcroppings. There is also a small section of the 25' wetland buffer from the wetlands located on the property that was part of the rural preservation subdivision that protrudes into this property. That will need to be accounted for and no building will be allowed within that buffer.

LAND USE SUMMARY:

- Resort Zone (RZ)
- Phase 1 approximately 16 acres (28.87 acres total)
- 11.87 acres of open space (15.95 acres of open space in entire master plan)
 - o 8.81 acres are preserved in a conservation easement
- 12 duplexes (24 units), two family lodges, and amenities

- Public trails from 600 North to Burgi Lane, River Road to resort core, and crater loop trail. Trails will be 8' with a paved surface except for the hot pot trail will be a soft surface trail.
- Private roads and storm drain system will be maintained by the property owner
- New improvements will connect to the Midway Sanitation District sewer and to the City's culinary water line.
- Sensitive lands on the property include hot pots, rock outcroppings and 25% and greater slopes.

ANALYSIS:

Open Space – The code requires 55% open space which is being met with 16.06 acres of which 11.87 acres are in phase 1. Only areas that are a minimum of 100' in width qualify as open space, these areas shall not be developed except for uses specifically permitted in the code. The open space areas that will be noted on the plat will include the 100' setback area along the adjoining property boundaries.

Density – The proposed development includes the following types and quantities of density (Items in **bold** are in phase 1):

•	80 Hotel Rooms –	41,270 SF
•	23 Cottages –	40,020 SF
•	One Presidential Suite -	3,210 SF
•	Resort Building/Spa -	48,510 SF
•	24 Duplex Units -	66,393 SF
•	Two Family Lodges -	10,542 SF
•	Farm Kitchen -	2,500 SF

Total: 212,445 SF Total Bedrooms: 237 EA

Building Area – The proposed plan includes a gross building floor area of 212,445 square feet (250,000 square feet is the maximum allowed by the Memorandum of Understanding). The resort zone requires 20% of the gross floor area to be designated as commercial (42,489 square feet). Of that 20%, 25% must be uses such as retail, restaurants, clubs/taverns, or art galleries/showrooms (10,622 square feet).

Access – The development has three access points, two of which will be built to City standards, one from Burgi Lane, one from 600 North via 200 East. The third is an emergency access from Sunflower Lane. The roads will be private except the existing public road of 200 East which extends about 650' north of 600 North.

Traffic Study – The developer has submitted a traffic study which Horrocks Engineers has reviewed. Please see the attached letter from Horrocks for their comments.

Public Participation Meeting – The developers held a public participation meeting on May 4, 2022, as required by the ordinance for master plan applications. This requirement is to give the developers an opportunity to present the development to the surrounding residents of the proposed development.

Sensitive Lands – The property does contain some sloped areas and geologic sensitive lands that cannot be disturbed through the development process. The craters are defined as a "major geologic feature" in the sensitive lands ordinance and cannot be developed or disturbed, although the Crater has been developed in several ways over the past century. The developer is limited in use of the area which basically means that the pot rock cannot be modified in any way. There is also an area of the property that contains "minor geologic features" which is an area that is developable except for pot rock outcroppings over three feet in height. A few trails are planned in the craters area which must be constructed within the guidelines of the sensitive land ordinance.

Public Trails – There is an 8' paved public trail that is planned to connect from the Burgi Hill Park in the north to the Watts Remund Farms PUD in the south. This trail will connect the north end of the City down to Main Street and will create a trail that will generally not parallel roads and will create a safe environment for pedestrians to travel from one area of the Midway to another. The City has also planned an 8' paved public trail along River Road and has recently installed a temporary trail in the River Road right-of-way. It is anticipated that in the future, the City will rebuild the River Road trail in the public trail easement that has been dedicated to the City as part of the Mountain Spa Rural Preservation Subdivision with the funds the developer has already given to the City. The future River Road trail will be constructed in the trail easement along the River Road right-of-way that will be farther from the road and will create a safer pedestrian experience. The City has also secured a public trail easement and funding to connect the River Road trail with the linear park trail on the property that would run east and west on an easement along the Lacy Lane Estates' southern boundary. This trail will be a soft surface trail. A log fence will also be built along the north side of the trail by funds already paid to the City by the developer. There is also a soft-surface public trail that will connect from the linear park trail that will circle the hot pot area in the conservation easement.

Private Trails – There are many 6' private trails in the development. These trails will be used by the guests to travel from lodging areas to amenity areas. The plan specifies that the trails will either be concrete or asphalt which will work better than softsurface trails which would not be as feasible in the varied climate of Midway.

Architecture Theme – Typically, the architectural theming for new structures in the Resort Zone must comply with the Swiss-European guidelines outlined in Section 16.13.37 of the land use code. In Chapter 16.15 (Resort Zone), the building design guideline section (16.15.4 (G) (3)) states that the building design shall reflect "The community's architectural character choices emphasizing Swiss/European Alpine themes (or other themes as approved by the City Council after a recommendation from the Visual Architectural Committee (VAC) and Planning Commission)." The applicant proposed a theme that some may interpret as a departure from the typical Swiss/European Alpine themes. With the approval of the master plan, the developer's proposed theming was approved for the resort. Individual buildings will be presented to the VAC for their review before building permits are submitted.

Setbacks – The proposed development is designed with the setbacks from the Resort Zone code. The code requires 100' setbacks from all boundary lines surrounding the original Mountain Spa property. This includes the areas along the southern boundary, Sunflower Farms, property to the west that fronts Center Street, and along the boundary with the Lacy Lane Estates. The four Mountain Spa Rural Preservation lots that were developed by the applicant and were part of the original Mountain Spa Resort property, all have minimal setbacks because those properties are part of the master proposal and are considered part of the resort property as approved in the previous plan (2008 master plan approval). Internal road setbacks are as approved by the City Council. Most of the units are setback from the private road about 15-20 feet but there are two buildings that have a minimal setback of about 10' from the edge of the private road. The two-family lodges are setback about 12'.

Height of structures – Structures cannot exceed 35' in height measured from natural grade. The code does allow specific architectural elements to reach a maximum height of 52.5'.

Building Area Dimensional Limitations – The code requires that building coverage not exceed 12,000 square feet per acre or greater than 27.5% of an acre. The applicant has submitted a plan that states that the average building coverage 212,445 square feet (4.88 acres) per acre which is 16.9% per acre.

Memorandum of Understanding requirements – Summit Land Conservancy and Chuck Heath entered into a Memorandum of Understanding (MOU) regarding development of the Mountain Spa Property. The MOU dictates previously mentioned items such as building footprint area and height. It also requires the following:

- Restore and maintain the historic "Mountain Spa" pole sign.
- Construct the previously mentioned trails.
- Restore natural hot spring water to at least one of the craters in the protected pot rock area.
- Demolish and clean up the old buildings and derelict swimming pools in and around the protected pot rock area, leaving the two-story historic stone building intact.

• Provide for the preservation of wildlife habitat, particularly the wetland areas on the northwest of the property.

Parking in Phase I-13 parking stalls will be built in front of the family pool area. Each of the duplex units and family lodges will include a 2-car garage. Because of the minimal setbacks for some of the structures, there will not be room to park in the driveway areas in front of the garages for some of the units.

Water Rights – Master plans require that water rights be held in escrow with the City before the master plan agreement can be recorded. The required water rights per phase are then dedicated to the City before the recording of each plat. The Water Advisory Board reviewed the project on May 2, 2022, to preliminarily determine the water required for the proposal. In that meeting, the Water Board recommended that 119.62 acre feet (106.72 culinary and 12.97 outside irrigation) will be required for the entire project which includes culinary connections and outside irrigation. Since that meeting, plans have been revised and updated so the current recommendation is no longer accurate. On October 3, 2022, the Water Board reviewed and made a recommendation that 124.85 acre feet (92.23 culinary and 25.62 outside irrigation) must be held in escrow for the entire master plan. They also recommended to the City Council that 36.5 acre feet are dedicated for Phase 1 (26 culinary connections, water features, and 3.16 acres of irrigated area).

Landscaping Plan – A detailed landscaping plan has been submitted which shows irrigated areas, ground covers, and types and quantities of trees. The code requires 15 trees per acre for non-hard-surface common areas. Based on the plan, 326 trees are required. Phase 1 includes 257 of the required 326 trees. All trees in Phase 1 comply with requirements that evergreens are at least 6' tall and deciduous trees have a caliper of at least 2". One area of attention is in the north end of the resort where the private road makes a 90 degree turn next to Lacy Lane Estates. This area is of concern because of the potential light nuisance that is created by vehicles leaving the resort and heading to Burgi Lane. The lights from the vehicle will shine directly into the back of couple of Lacy Lane homes and will affect several others unless the nuisance is mitigated. The developer, staff and Lacy Lane Estates HOA, and residents of Lacy Lane have held several meetings to work on a landscape plan and stone wall plan that works for all parties. It is unknown if all the residents of Lacy Lane agree on the plan but the feedback that staff has received has all been positive on the proposed plan.

Off-Site Storm Drain Basin – Part of creating a landscaping plan that helps shield residents of Lacy Lane from light and noise nuisances created by Ameyalli, and part of creating the space necessary for the landscaping required rerouting of the proposed public trail. To create the spacing for both, a solution developed that placed Ameyalli's storm water basin in the common area of Lacy Lane. This plan is currently being voted on the HOA and, if approved, and easement will need to be granted by the HOA to Ameyalli for access and maintenance purposes. If the vote fails, then Ameyalli will return to their original plan of an on-site storm drain basin

but the trail and landscaping on Ameyalli will need to be modified from the proposed plans.

Geotechnical Report – The City has received a geotechnical report for the property that was prepared by Earthtec which has been reviewed by Horrocks Engineers. The City has also received a report on ground penetrating radar of the site.

WATER BOARD RECOMMENDATION:

The Water Advisory Board reviewed the project on October 3, 2022, to determine the water required for the proposal. They recommended that 124.85 acre feet (99.23 culinary and 25.62 outside irrigation) will be required for the entire project which includes culinary connections and outside irrigation. They also recommended to the City Council that 36.5 acre feet are dedicated for Phase 1 (26 culinary connections, water features, and 3.16 acres of irrigated area).

PLANNING COMMISSION RECOMMENDATION:

Motion: Commissioner Garland: I make a motion that we recommend approval of the final application for Phase 1 of Ameyalli Resort on 28.87-acres. The final plan includes 24 duplex units and 2 family lodges, private road, public and private trails, and other resort related amenity improvements. The property is located at approximately 800 North 200 East and is in the Resort Zone. We accept the staff report and findings, along with the condition listed in the staff report. With the addition of the trail easement to be included as a condition.

Seconded: Commissioner Simons

Chairman Nicholas: Any discussion on the motion?

Chairman Nicholas: All in favor.

Ayes: Commissioners: Nokes, Osborne, Wardle, Garland and Simons

Nays: None Recused: None Motion: Passed

POSSIBLE FINDINGS:

- The proposal will benefit the City financially by creating a greater tax base.
- The proposal will help the City better comply with State requirements regarding the ability to collect resort tax.
- The public trail system in the development will benefit the entire community by creating public trails across the property.

• Amenities will be created that will be accessible year-round which will invite more tourists to visit the resort in all seasons.

ALTERNATIVE ACTIONS:

- 1. <u>Approval (conditional)</u>. This action can be taken if the City Council finds the proposal complies with code and master plan requirements.
 - a. Accept staff report
 - b. List accepted findings
 - c. Place condition(s) if needed
- 2. <u>Continuance</u>. This action can be taken if the City Council finds that there are unresolved issues.
 - a. Accept staff report
 - b. List accepted findings
 - c. Reasons for continuance
 - i. Unresolved issues that must be addressed
 - d. Date when the item will be heard again
- 3. <u>Denial</u>. This action can be taken if the City Council finds that the request does not comply with code and master plan requirements.
 - a. Accept staff report
 - b. List accepted findings
 - c. Reasons for denial

PROPOSED CONDITION:

1. The off-site storm drain easement ant trail easement must be recorded before the plat is recorded for Phase 1.



September 13, 2022

Michael Henke Midway City Planner 75 North 100 West Midway, Utah 84049 (Sent by Email)

Subject: Ameyalli – Phase 1 Preliminary Review

Dear Michael:

Horrocks Engineers recently reviewed Phase 1 of the Ameyalli Resort for Preliminary approval. The proposed resort is located within the recently plated Mountain Spa Rural Preservation development and is located at approximately 800 North and 200 East. Phase 1 consists of 24 duplex units located within 12 structures and 2 family lodges located within 2 structures. Phase 1 has a total of 108 bedrooms. The proposed resort is located within 28.87 acres. The following issues should be addressed with Preliminary approval.

General Comments

- To allow Phase 1 to operate as a self-sustaining phase, the road must be constructed from 600 North to Burgi Lane.
- Snow removal and trash collection should be addressed.

Water

- Phase 1 will be served from the Gerber / Mahogany pressure zone.
- To provide the adequate fire flow, the proposed 8" water line will connect to the existing 10" Gerber zone water line within Burgi Lane, the existing 10" water line in Sunflower Lane, and the proposed upsized 8" water line in 200 East.
- The proposed 8" water lines within the development will provide fire flows of approximately 2,000 gpm. To provide these fire flows all water lines should be installed with phase one.

Roads

- Roads within the proposed Phase 1 will connect to both Burgi Lane and 200 East at 600 North, with a third emergency access connecting to Sunflower Lane. Each road will be built to Rural City Street standard. The proposed cross-section is 22' of asphalt with two 2' concrete ribbon curbs, for a total width of 26'
- The roads within the resort will be private roads with a public easement.
- Each of the improvements within 200 East, road, water, irrigation, and any private improvements will be installed and paid for by the Ameyalli Resort.
- The existing power line along 200 East should be buried as part of the Ameyalli Phase 1 improvements.
- A traffic study has been submitted and reviewed and accepted.

Pressure Irrigation

• The resort will be serviced by Midway Irrigation. To date a design for the booster pump has not been provided to the developer.

• Prior to Phase 1 receiving Final approval the design for the irrigation pumping system should be submitted to and accepted by the Developer. This should be both the pump design and the pump and pipeline location.

Trails

• An 8' paved public trail running north to south from Burgi Lane through the development and connecting to 600 North is shown on the proposed plans. This trail will provide connectivity from existing trails on Burgi Lane, and 600 North to the Valais Park. The trail will be a valuable link to the Midway City trails system. The trail is shown to be completed as part of Phase 1.

Storm Drain

• The storm drain system will be a private. The system will collect and retain all storm water onsite through catch basins and retention basins. The storm drain system will be a private system maintained by the owner.

Sewer

• All units within this development will be serviced by Midway Sanitary District.

Please feel free to call our office with any questions.

Sincerely,

HORROCKS ENGINEERS

Wesley Johnson, P.E. Midway City Engineer

cc: Berg Engineering (Sent by Email)

Midway City Corporation

Mayor: Celeste T. Johnson
City Council Members
Lisa Christen • Jeffery Drury
J.C. Simonsen • Steve Dougherty
Kevin Payne



75 North 100 West P.O. Box 277 Midway, Utah 84049 Phone: 435-654-3223 Fax: 435-654-4120

midwaycityut.org


Ameyalli Master Plan Approval


July 6, 2022


Michael Henke Midway City Planning Director,


I have reviewed the master plan proposal for Ameyalli for compliance with the 2018 International Fire Code (2018 IFC). The only concern I have with the current plan proposal, the main road going between Burgi Lane and 200 East be fully connected and be asphalted, or concrete prior to allowing combustible construction activities. I have no other fire code concerns currently. Once more detailed plans are available, I will review this development for 2018 IFC code compliance verify proper hydrant location & distances from structures, road widths, etc.

Tex R. Couch CBO/MCP
Midway City Building Official/Fire Marshal
75 West 100 North
Midway, Utah 84049
tcouch@midwaycityut.org
(435)654-3223 Ext. 107

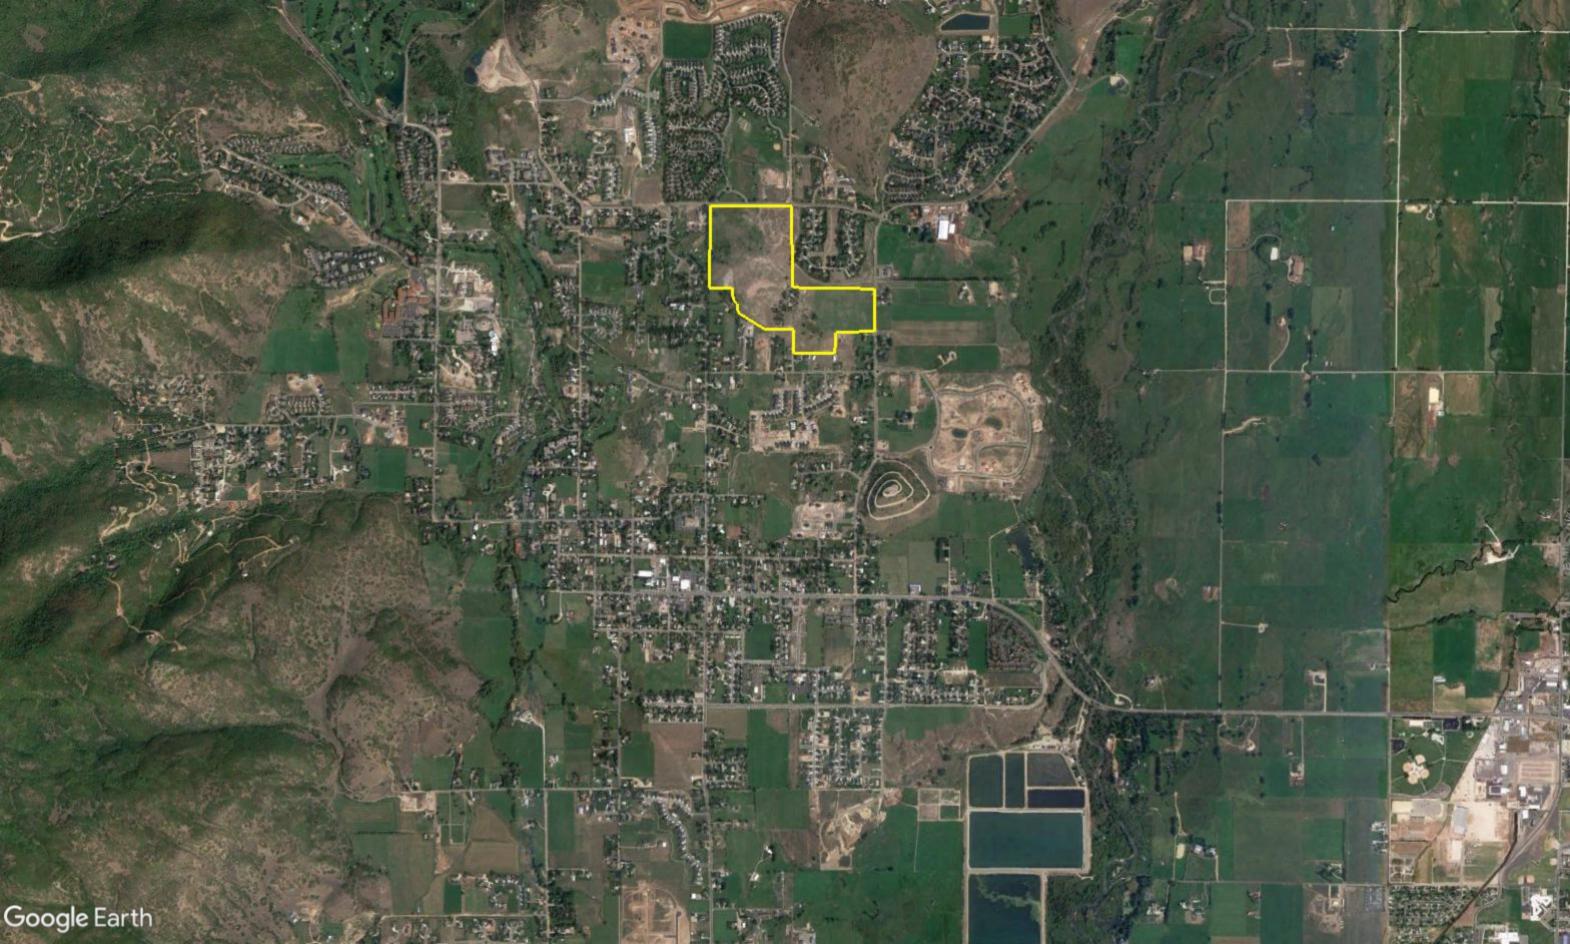

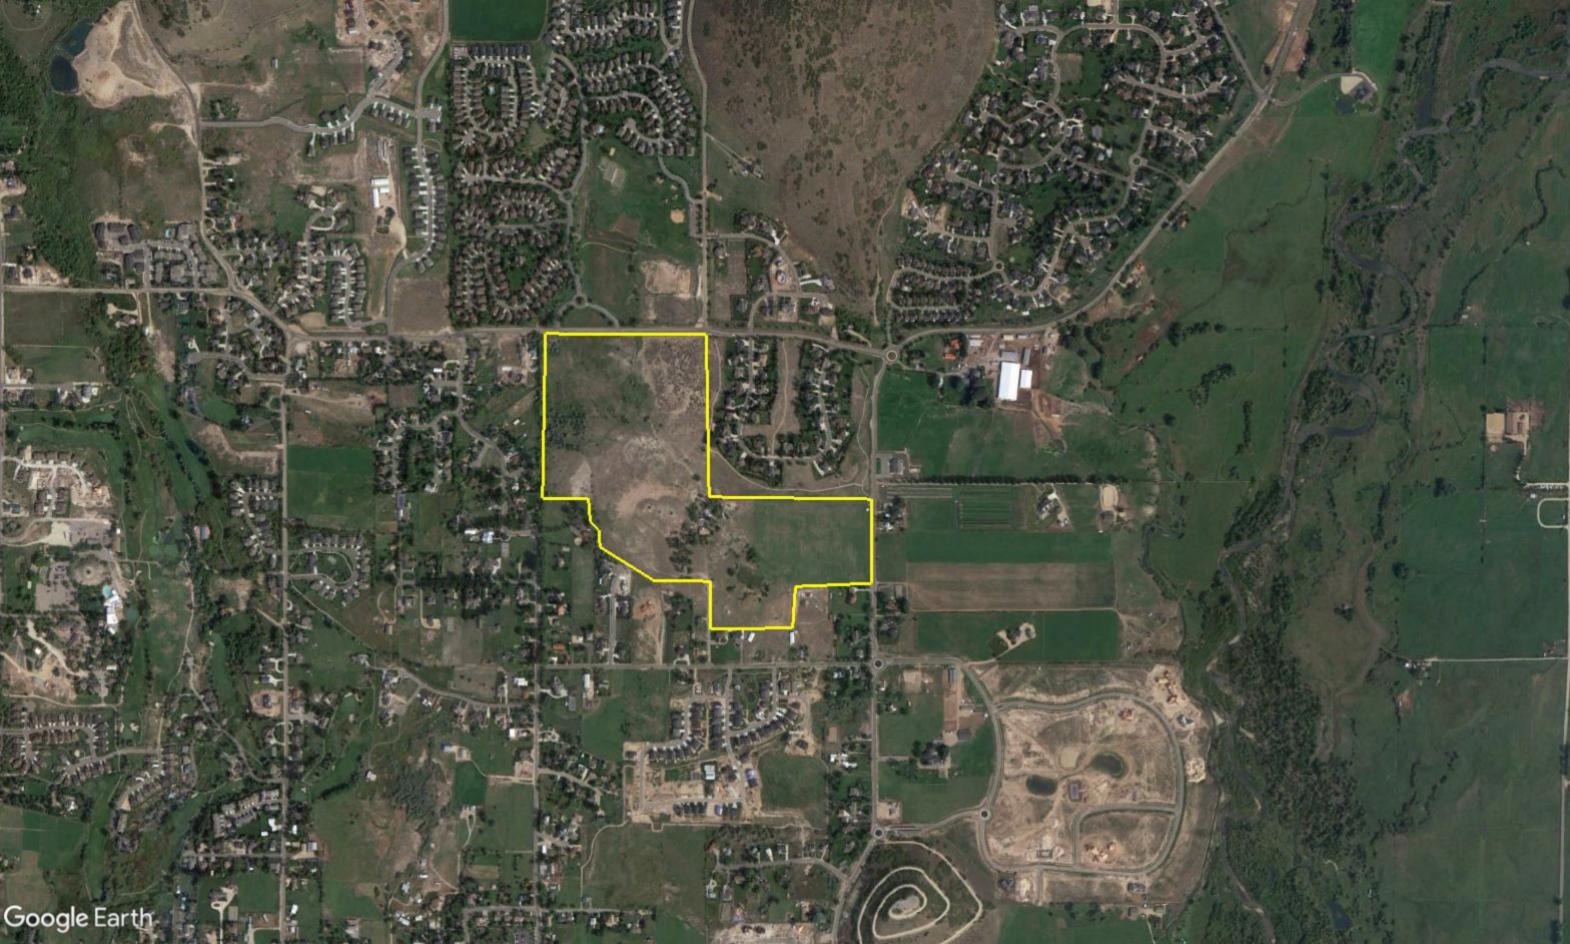

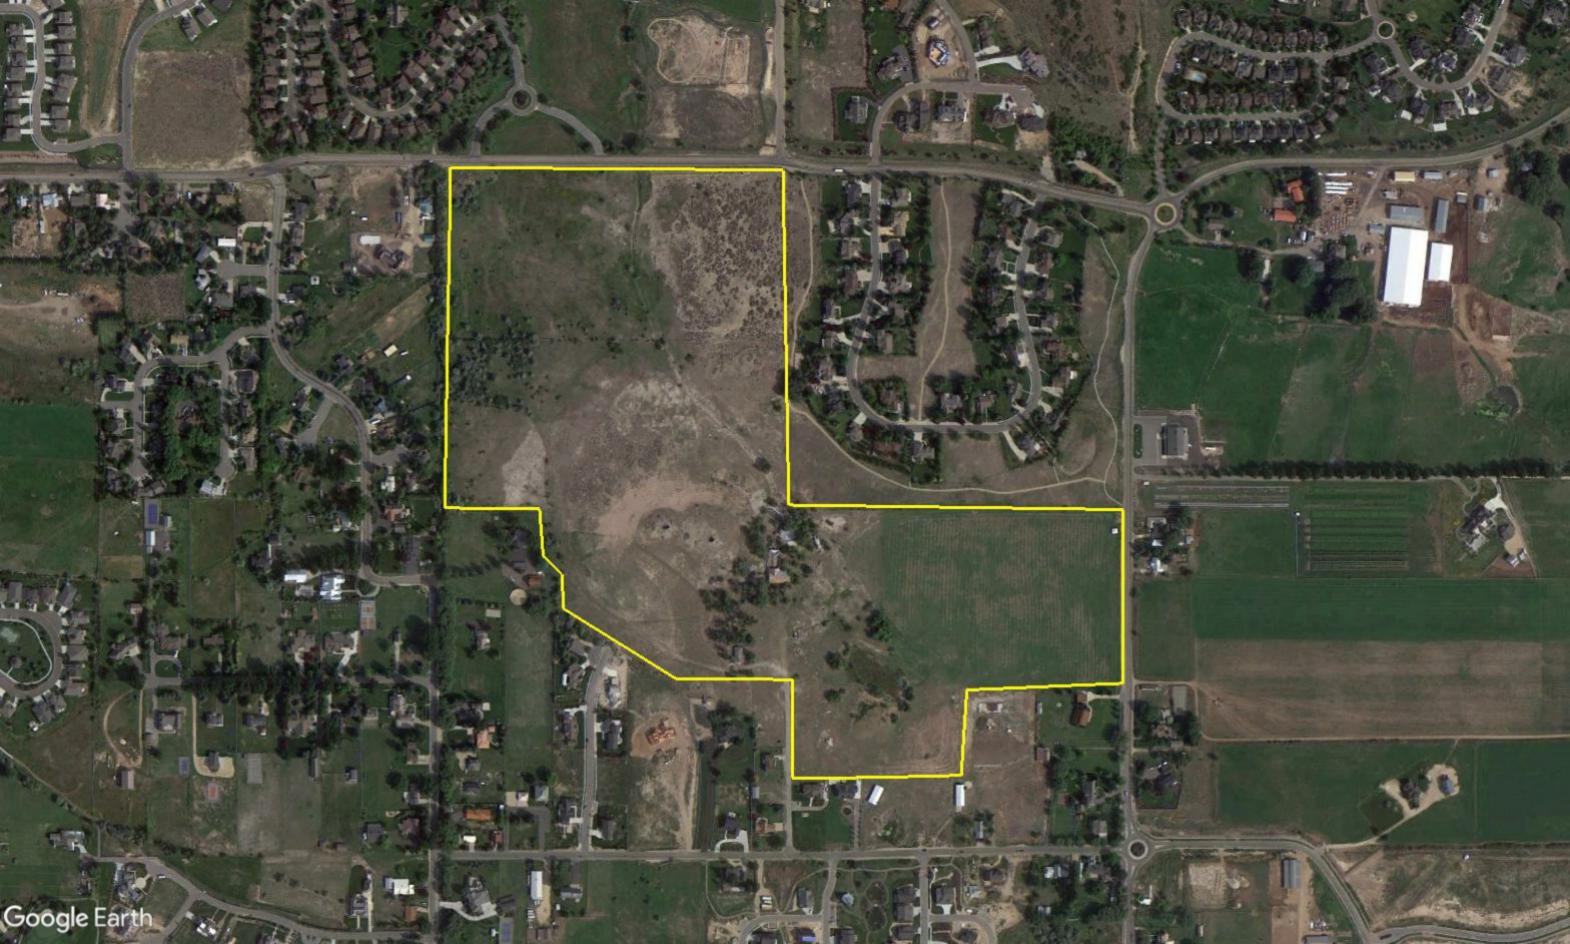

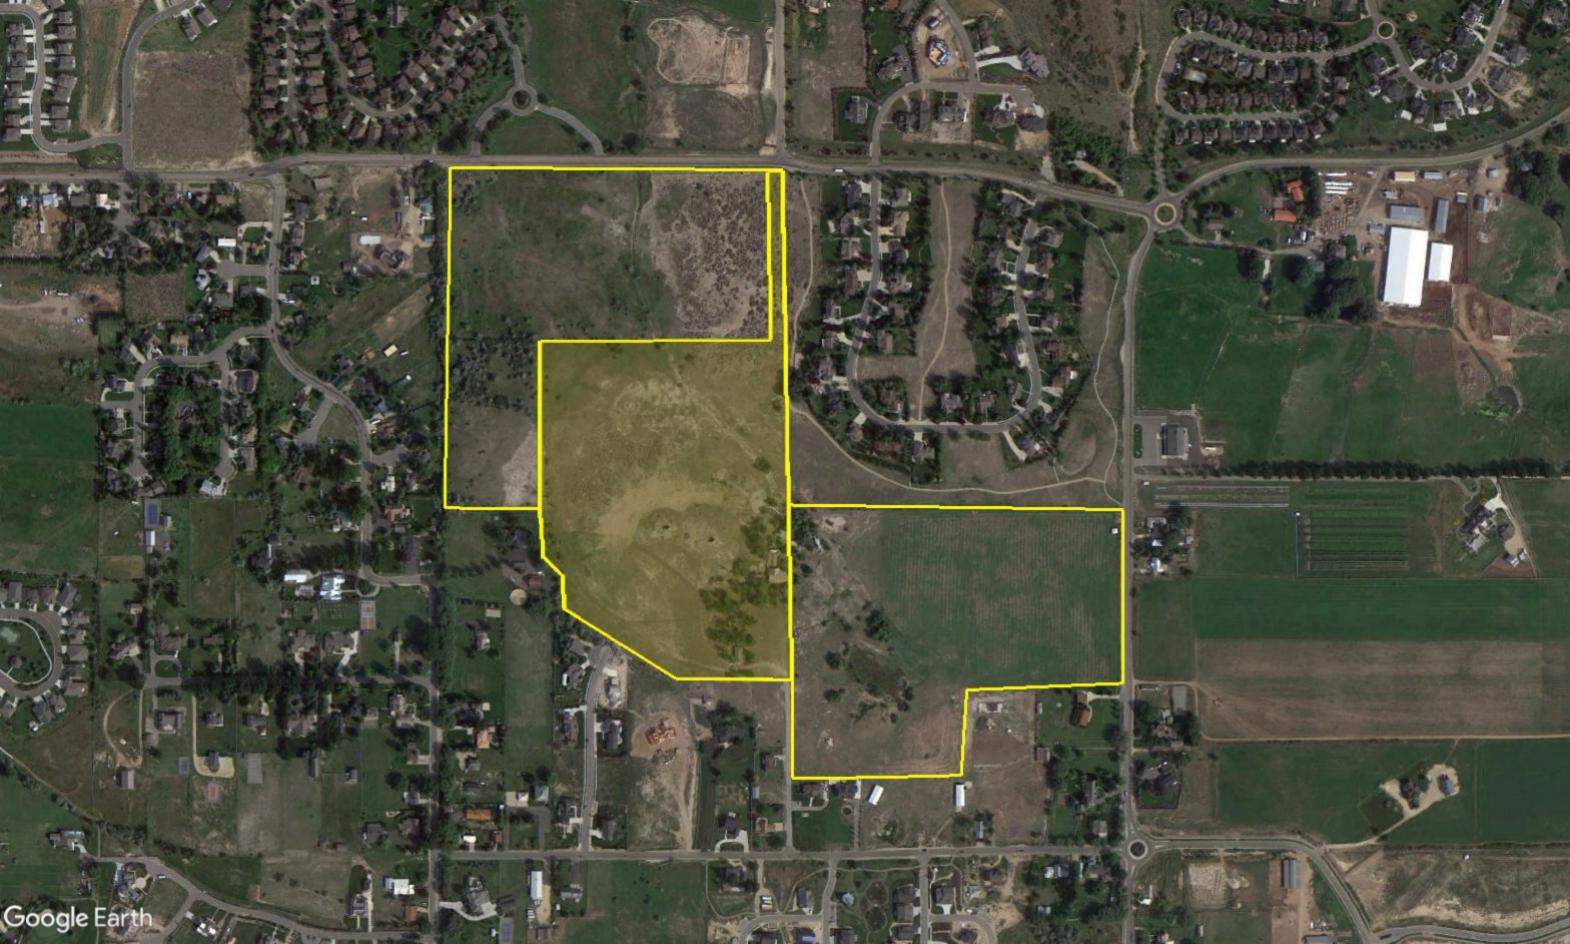

Ameyalli Vision Statement

Ameyalli's main goal is to bring Mountain Spaa and Luke's Hot Pots back to life. Historically, this land was a stronghold for both visitors and residents, but it has since been reduced to rubble. With the creation of Ameyalli, this sanctuary will be illuminated in a fresh, but connective and reminiscent way.

Another intention is that we hope to bridge the site's distinctive history and beauty simultaneously. We have taken inspiration from famous Swiss Architects like Peter Zumthor for our design, and it is important that we incorporate Midway's Swiss design while respecting the site's noteworthy topography. Our buildings will amalgamate the natural Hot Pot stone layering the area, thus having a very natural and refreshing look. Moreover, the earth-like tones and grass roofs make the development nearly disguised from the road or aerial views to enhance the site's individual landscape, instead of covering it. The 45-acres of land donated to the Summit Land Conservancy also creates a charming buffer between resident and resort property.

We hope to do justice to the site's history by paying our utmost respect to those who have used the site; from residents in recent years to Indigenous Peoples using the waters as a sacred meeting point—we want to remind everyone of its important history. We will be restoring the old Mountain Spaa sign and hopefully restoring one of the original stone buildings. We also plan to educate visitors on the site's history by posting stories, information, and experiences on our website, menus, and brochures.

A significant benefit is that Ameyalli Resort will bring in visitors from across the globe. With five-star spa amenities, mountain views, healing hot spring minerals, and an exceptional location, Ameyalli will create a world-class destination for the city of Midway. The development will have 131 units that visitors can have the opportunity to rent, ranging from large family lodges to hotel rooms perfect for couples.

Along with bringing in new tourism, Ameyalli will also be an oasis for residents of Midway. Anyone will be able to come in for the day to enjoy a spa treatment, swim in the mineral water, hike through the trail system, or have dinner at the restaurant overlooking the Wasatch Mountain Range. We've had communications with some residents of Midway, and many individuals spent their childhood at Mountain Spaa. We would love to bring this space back for them and their families to enjoy as well.

We have put extensive research into what will make this project a reality. We've divided our financials into three phases and have already raised the money needed to start developing. We raised our money through private equity to keep control and flexibility, and we have estimated the project to cost around \$89 million and take five years' time. We have additionally divided up the building into four phases: 1) Family Duplexes 2) Spa/Core Building 3) Hotel Rooms and 4) Cottages.

Our dream is for Ameyalli to become a staple of Midway. We are excited to work with Midway's city, residents, and businesses to create the best project possible. We want to bring this site back to life after being abandoned for so long. This site is very special to us, and we can't wait to open it back up to the public.

AMEYALLI RESORT DEVELOPMENT

Proposed Plan Conditions
Preliminary Resort Plan October 4, 2022

LIGHT MITIGATION STRATEGIES

All future site lighting will comply with Midway Municipal code 5.02.080 outdoor lighting and glare to help mitigate the potential impact on the surrounding residents. Please refer to page 7 of the submitted Preliminary City Application Package.

LIGHT NUISANCE STRATEGIES

On Saturday, September 17, 2022, at 9:00 am, Chuck Heath met with Bill McDonald, Lacy Lane Estates Homeowners Association President, Vice President Doug Gray, and Secretary Gary Otteson. The objective of the meeting was to collaborate on strategies to help reduce the light nuisance from cars leaving the resort and shining on homes on Lacy Lane Estates. One highly favored approach would be for the developer to build a 40' x 5' HT stone wall with evergreens behind it. Furthermore, other evergreens would be planted on HOA's property, thus helping reduce the light nuisance.

AMEYALLI RESORT

PHASE 1 FINAL APPLICATION

DUTCH CANYON **BURGI HILL** RANCHES P.U.D VALAIS **BURGI HILL** DUTCH FIELDS P.U.D. AMEYALLI_ RESORT CARI LANE **BURGI LANE** 600 NORTH 200 NORTH MAIN ST.

VICINITY MAP

SHEET INDEX

CIVIL ENGINEERING

- **EXISTING CONDITIONS**
- MASTER PLAN
- UTILITY MASTER PLAN
- STORM DRAIN MASTER PLAN
- PHASE 1 PLAN
- PHASE 1 PLAT
- 200 EAST\WELLNESS DRIVE PLAN AND PROFILE 0+00 10+00
- WELLNESS DRIVE PLAN AND PROFILE STA 10+00 20+00
- WELLNESS DRIVE PLAN AND PROFILE STA 20+00 30+00
- AMEYALLI DRIVE PLAN AND PROFILE STA 0+00 10+00
- AMEYALLI DRIVE PLAN AND PROFILE STA 10+00 12+00
- ROAD CONSTRUCTION DETAILS
- PHASE 1 UTILITY PLAN
- SUNFLOWER LANE SEWER PLAN AND PROFILE
- 15. WELLNESS DRIVE SEWER PLAN AND PROFILE STA 9+81 20+00
- 16. WELLNESS DRIVE SEWER PLAN AND PROFILE STA 20+00 30+50
- AMEYALLI DRIVE\OFFSITE SEWER PLAN AND PROFILE STA 7+00 10+00
- SEWER CONSTRUCTION DETAILS
- WELLNESS DRIVE STORM DRAIN PLAN AND PROFILE STA 8+00 10+00
- WELLNESS DRIVE STORM DRAIN PLAN AND PROFILE STA 13+00 15+00
- WELLNESS DRIVE STORM DRAIN PLAN AND PROFILE 20+00 30+50
- AMEYALLI DRIVE STORM DRAIN PLAN AND PROFILE 4+00 12+00
- 23. STORM DRAIN CONSTRUCTION DETAILS PHASE 1 WATER PLAN
- PHASE 1 PRESSURIZED IRRIGATION PLAN
- 26. WATER AND PRESSURIZED IRRIGATION CONSTRUCTION DETAILS
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- L02. TREE PLANTING PLAN 1 of 2
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- L06. SHRUB PLANTING PLAN 3 of 3
- L07. ROOF PLANTING PLAN DUPLEX A & B
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- L14. GRADING PLAN SHEET 4 of 4

THIS DOCUMENT IS INCOMPLETE AND IS RELEASED TEMPORARILY FOR INTERIM REVIEW ONLY. IT IS NOT INTENDED FOR CONSTRUCTION, BIDDING, OR PERMIT PURPOSES.

ARCHITECTURE

A3. FAMILY REUNION LODGE

A1. DUPLEX A

A2. DUPLEX B

PAUL D. BERG P.E. SERIAL NO. <u>295595</u> DATE: <u>14 NOV 2022</u>


CHUCK HEATH AMEYALLI PHASE 1


COVER




DRAWN BY: DEJ REV:

DESIGN BY: PDB DATE: 14 NOV 2022

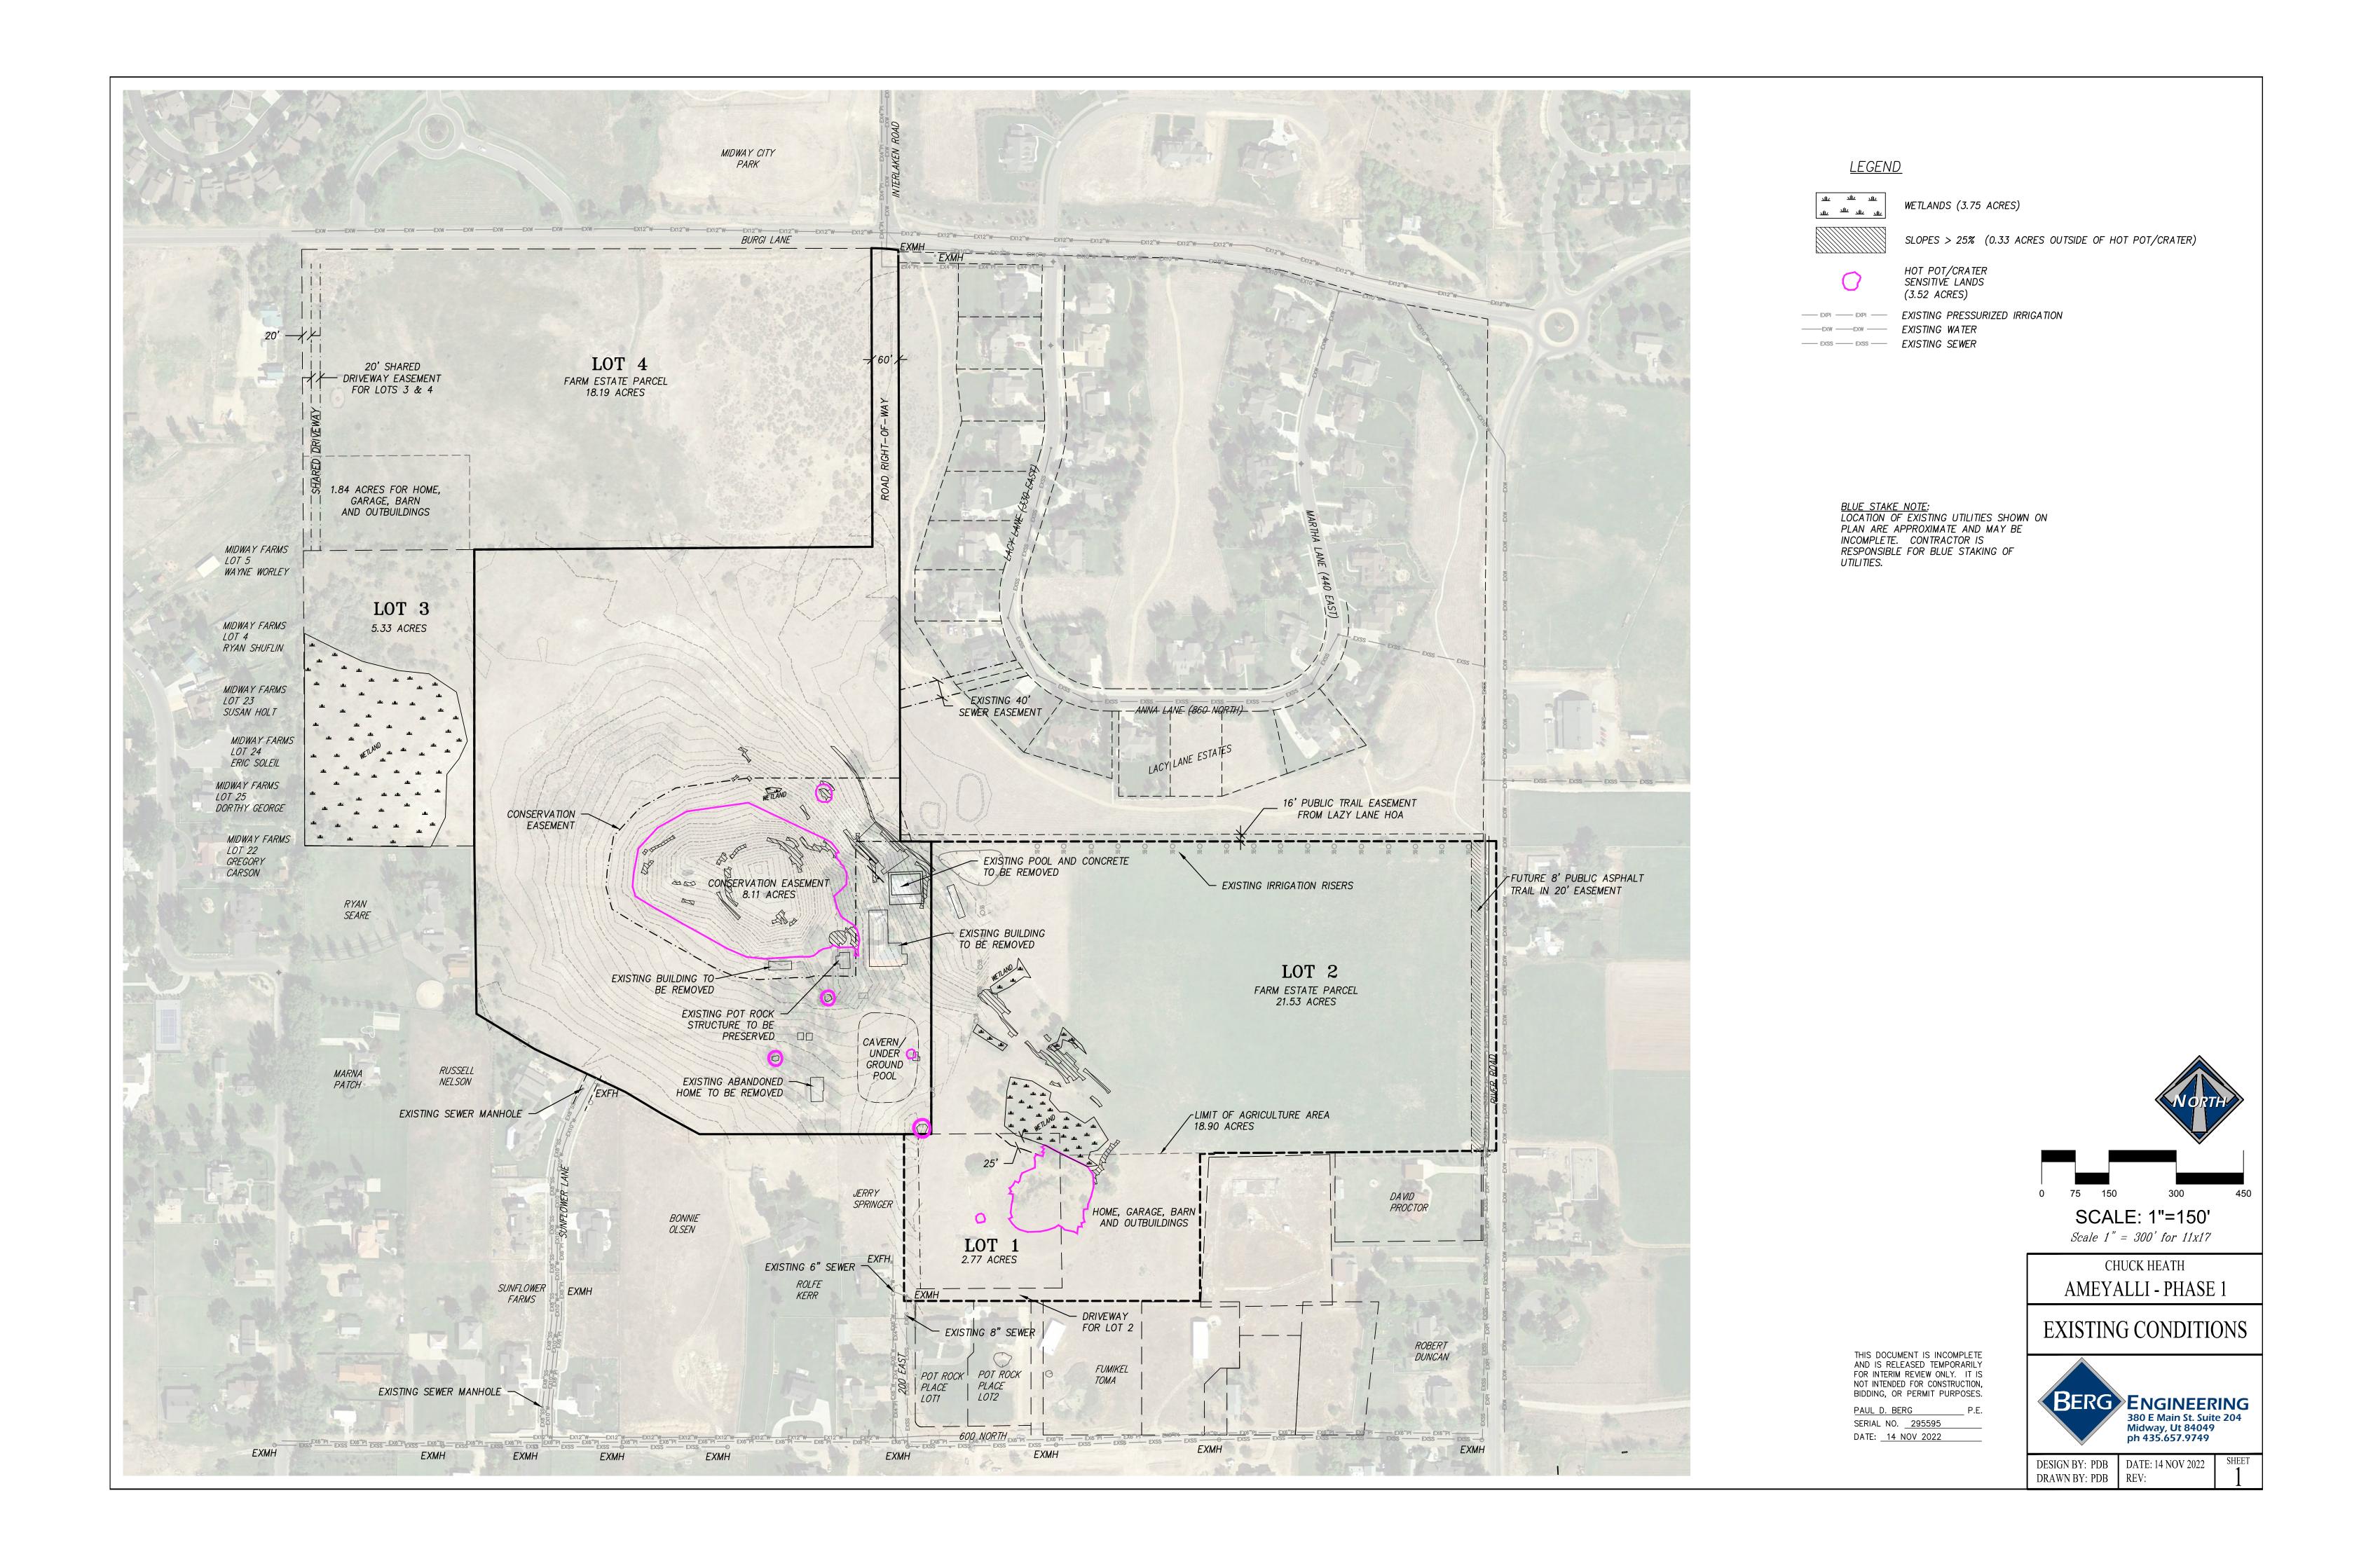

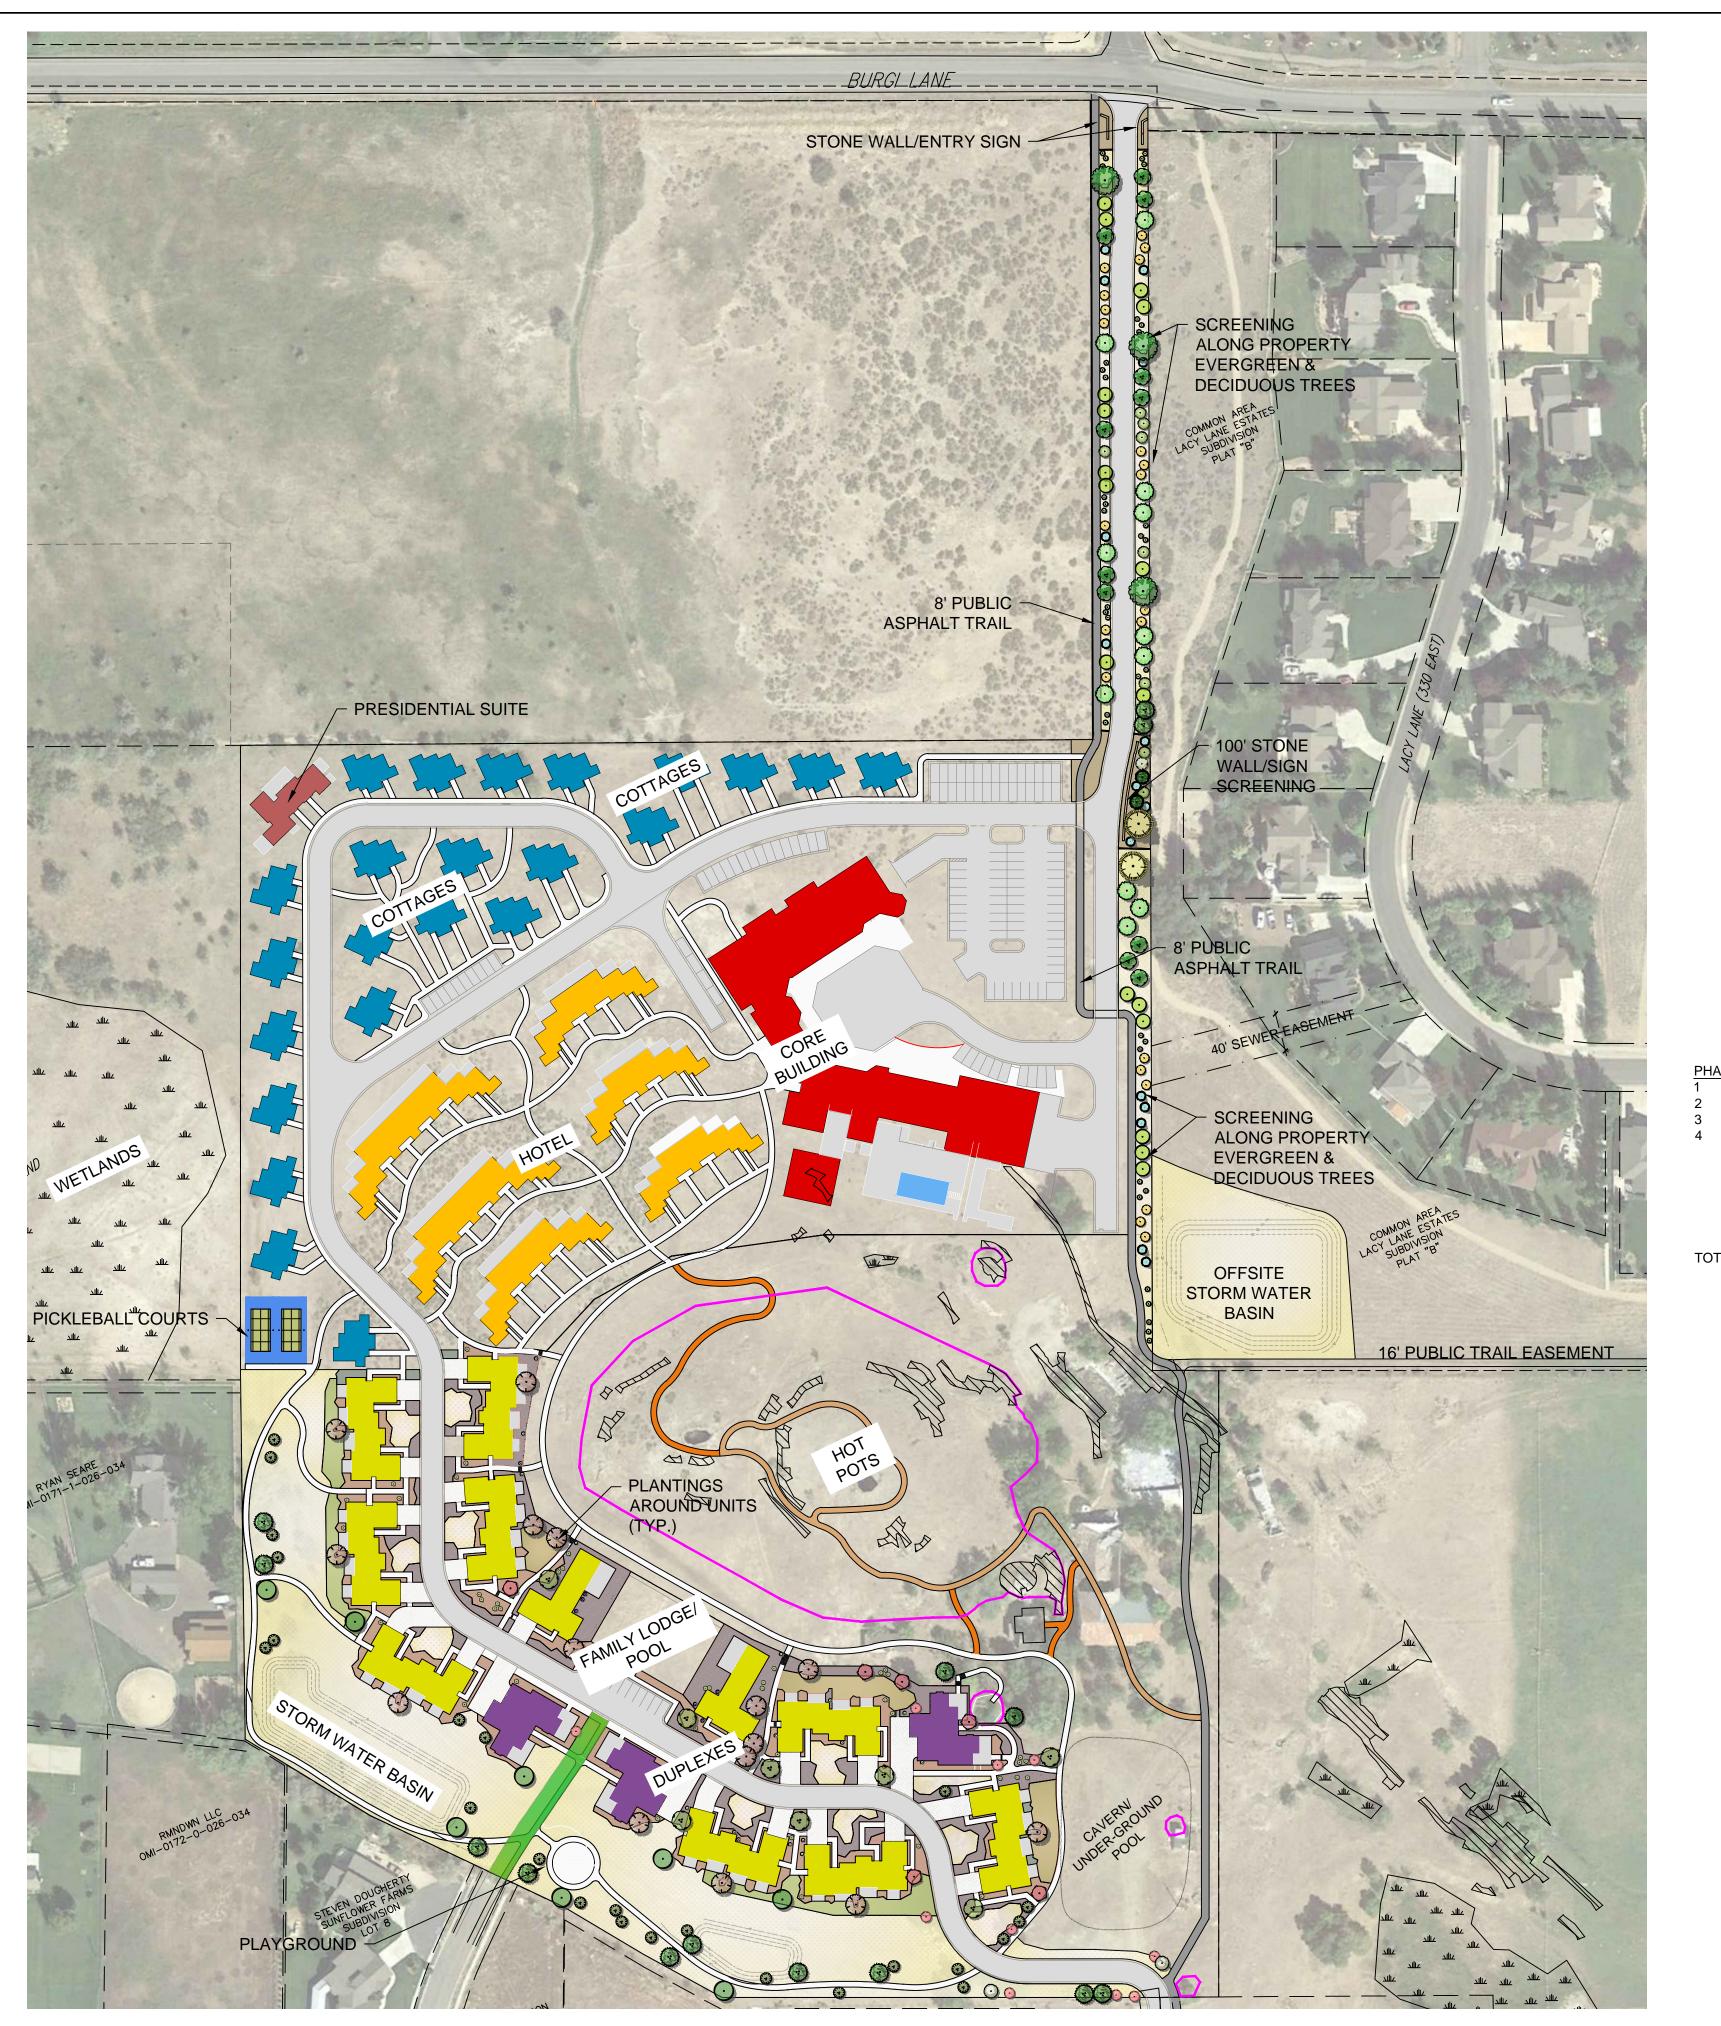

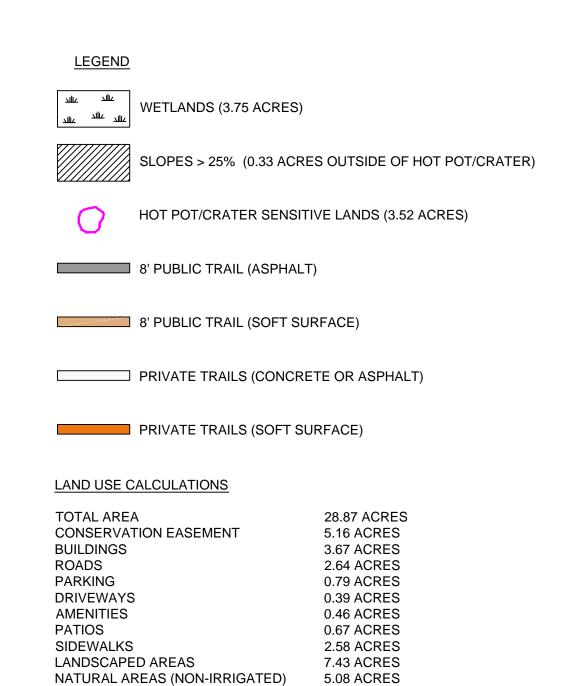

GRASS/NATIVE MULCH 33,673 SF 23,874 SF 54,652 SF

248,252 SF

5.70 AC

NATIVE/UNDISTURBED 9,072 SF 36,721 SF 14,356 SF 113,034 SF 468,730 SF 2.59 AC 10.76 AC


TREES IN NATURAL AREA
400 SF (10 SF PER TREE, 40 TREES)

TOTAL IRRIGATED (GRASS, MULCH AND TREES)
126,423 SF 400 SF (10 SF PER TREE, 40 TREES) 30 SF (10 SF PER TREE, 3 TREES) N/A 670 SF

57,577 SF (1.32 AC) 91,373 SF (2.10 AC) 86,483 SF (1.99 AC)

TOTAL IRRIGATED AREA FOR PHASE 1 REMAINS THE SAME. AREAS WITHIN GRASS, MULCH AND TREES IN NATURAL AREA HAS BEEN ADJUSTED.

0.02 AC

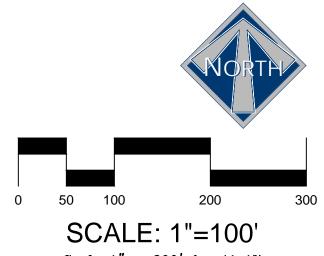

Scale 1" = 200' for 11x17


CHUCK HEATH AMEYALLI PHASE 1

MASTER PLAN

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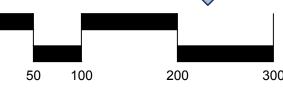


DESIGN BY: PDB DATE: 18 NOV 2022 DRAWN BY: DAW REV:

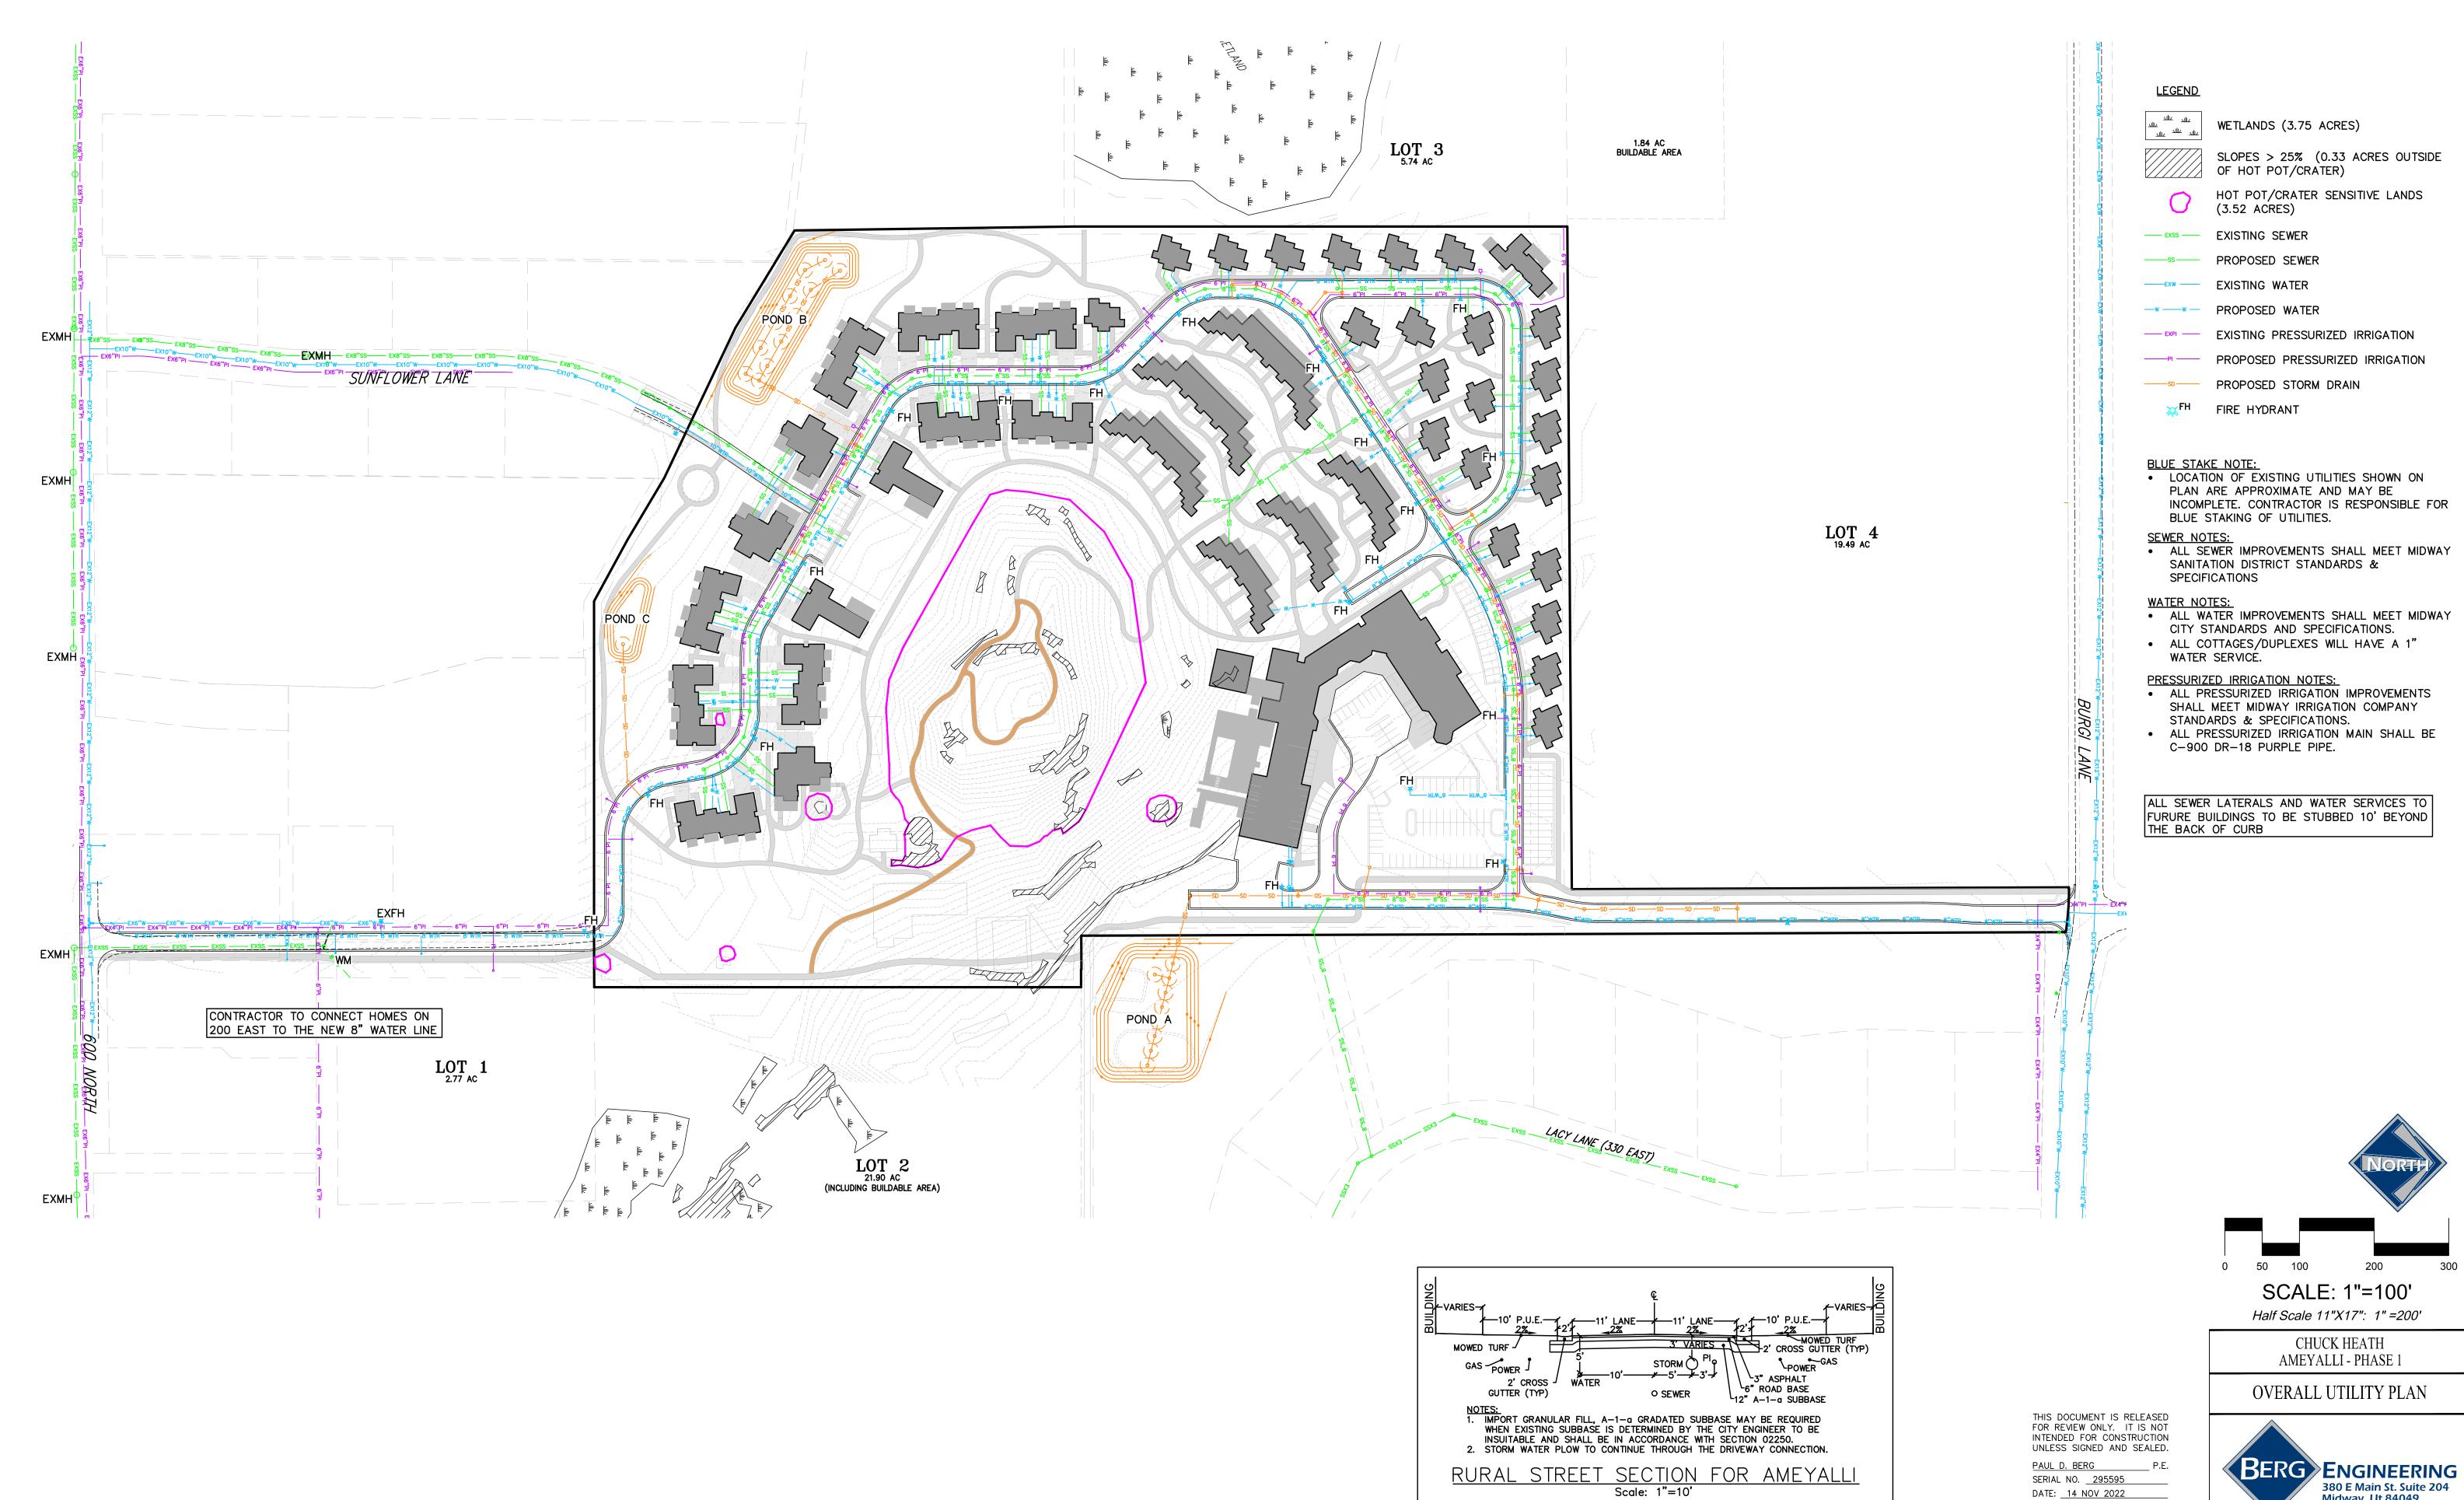

INCOMPLETE. CONTRACTOR IS RESPONSIBLE FOR








DESIGN BY: PDB DATE: 14 NOV 2022

DRAWN BY: DEJ REV:

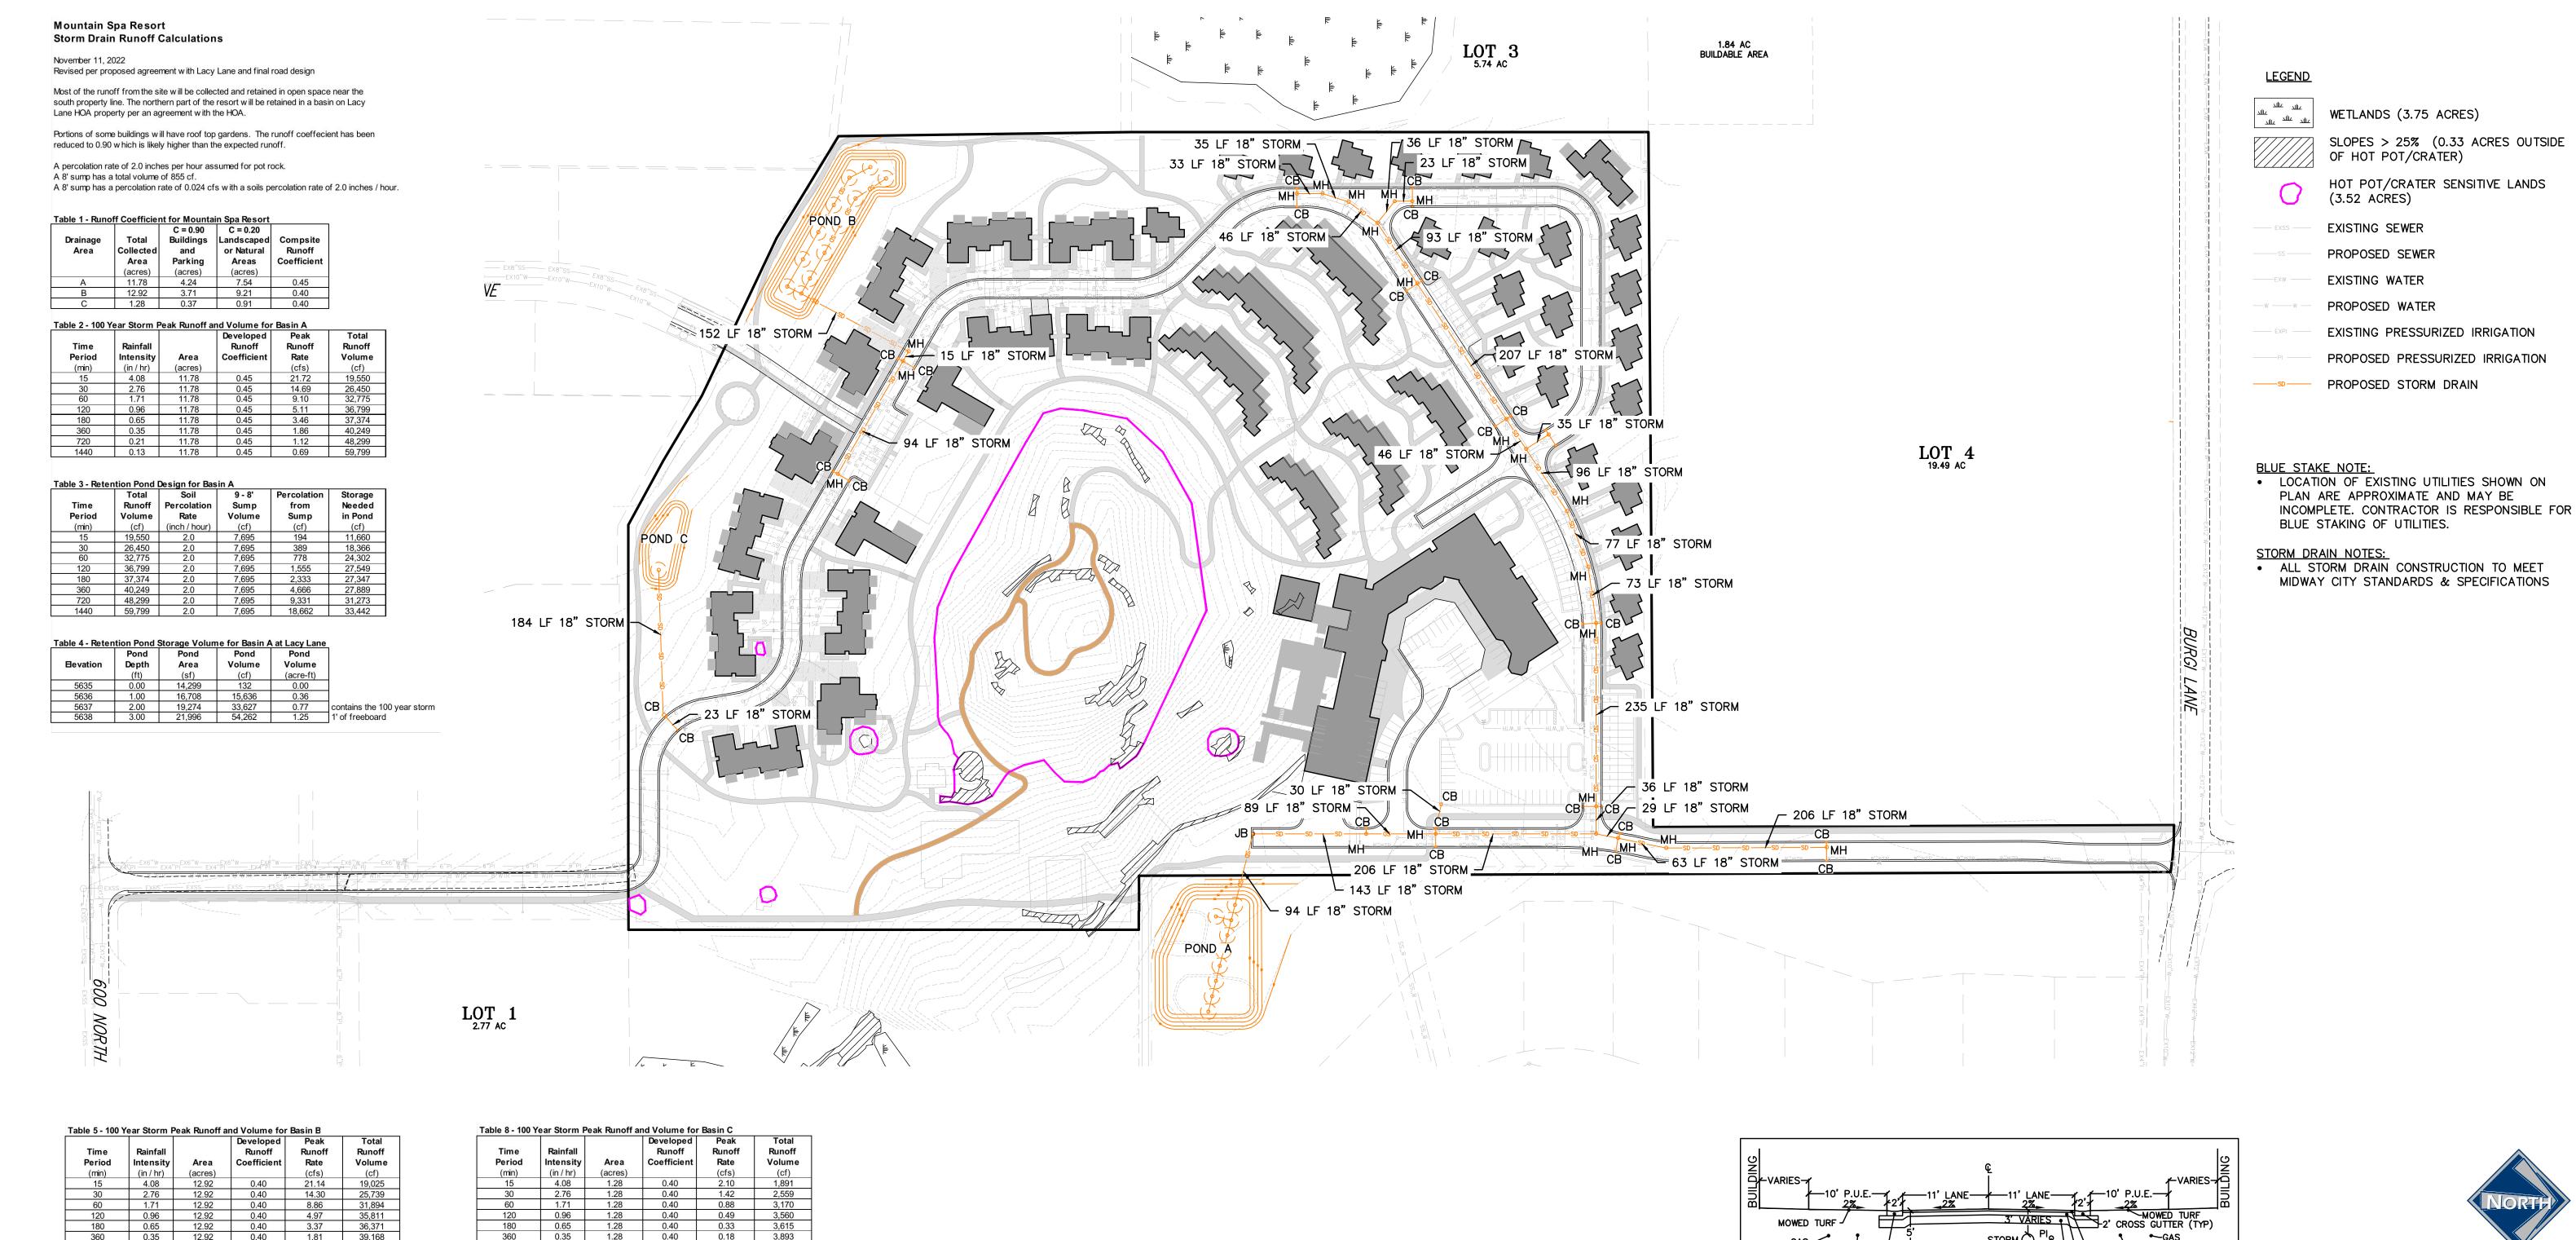



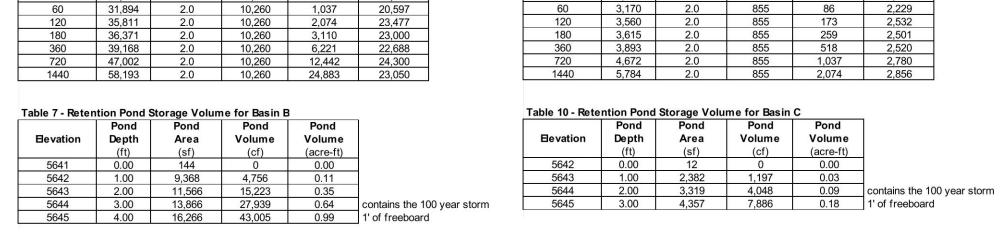


Table 6 - Retention Pond Design for Basin B at SW Corner
Total Soil 12 - 8' Pere

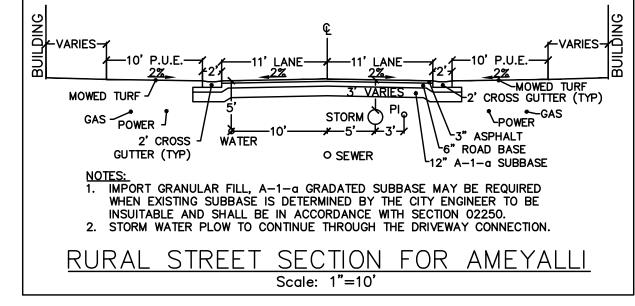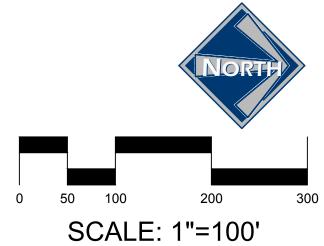

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Half Scale 11"X17": 1" =200'


CHUCK HEATH AMEYALLI - PHASE 1

STORM DRAIN MASTER PLAN



DRAWN BY: DEJ REV:

DESIGN BY: PDB DATE: 14 NOV 2022

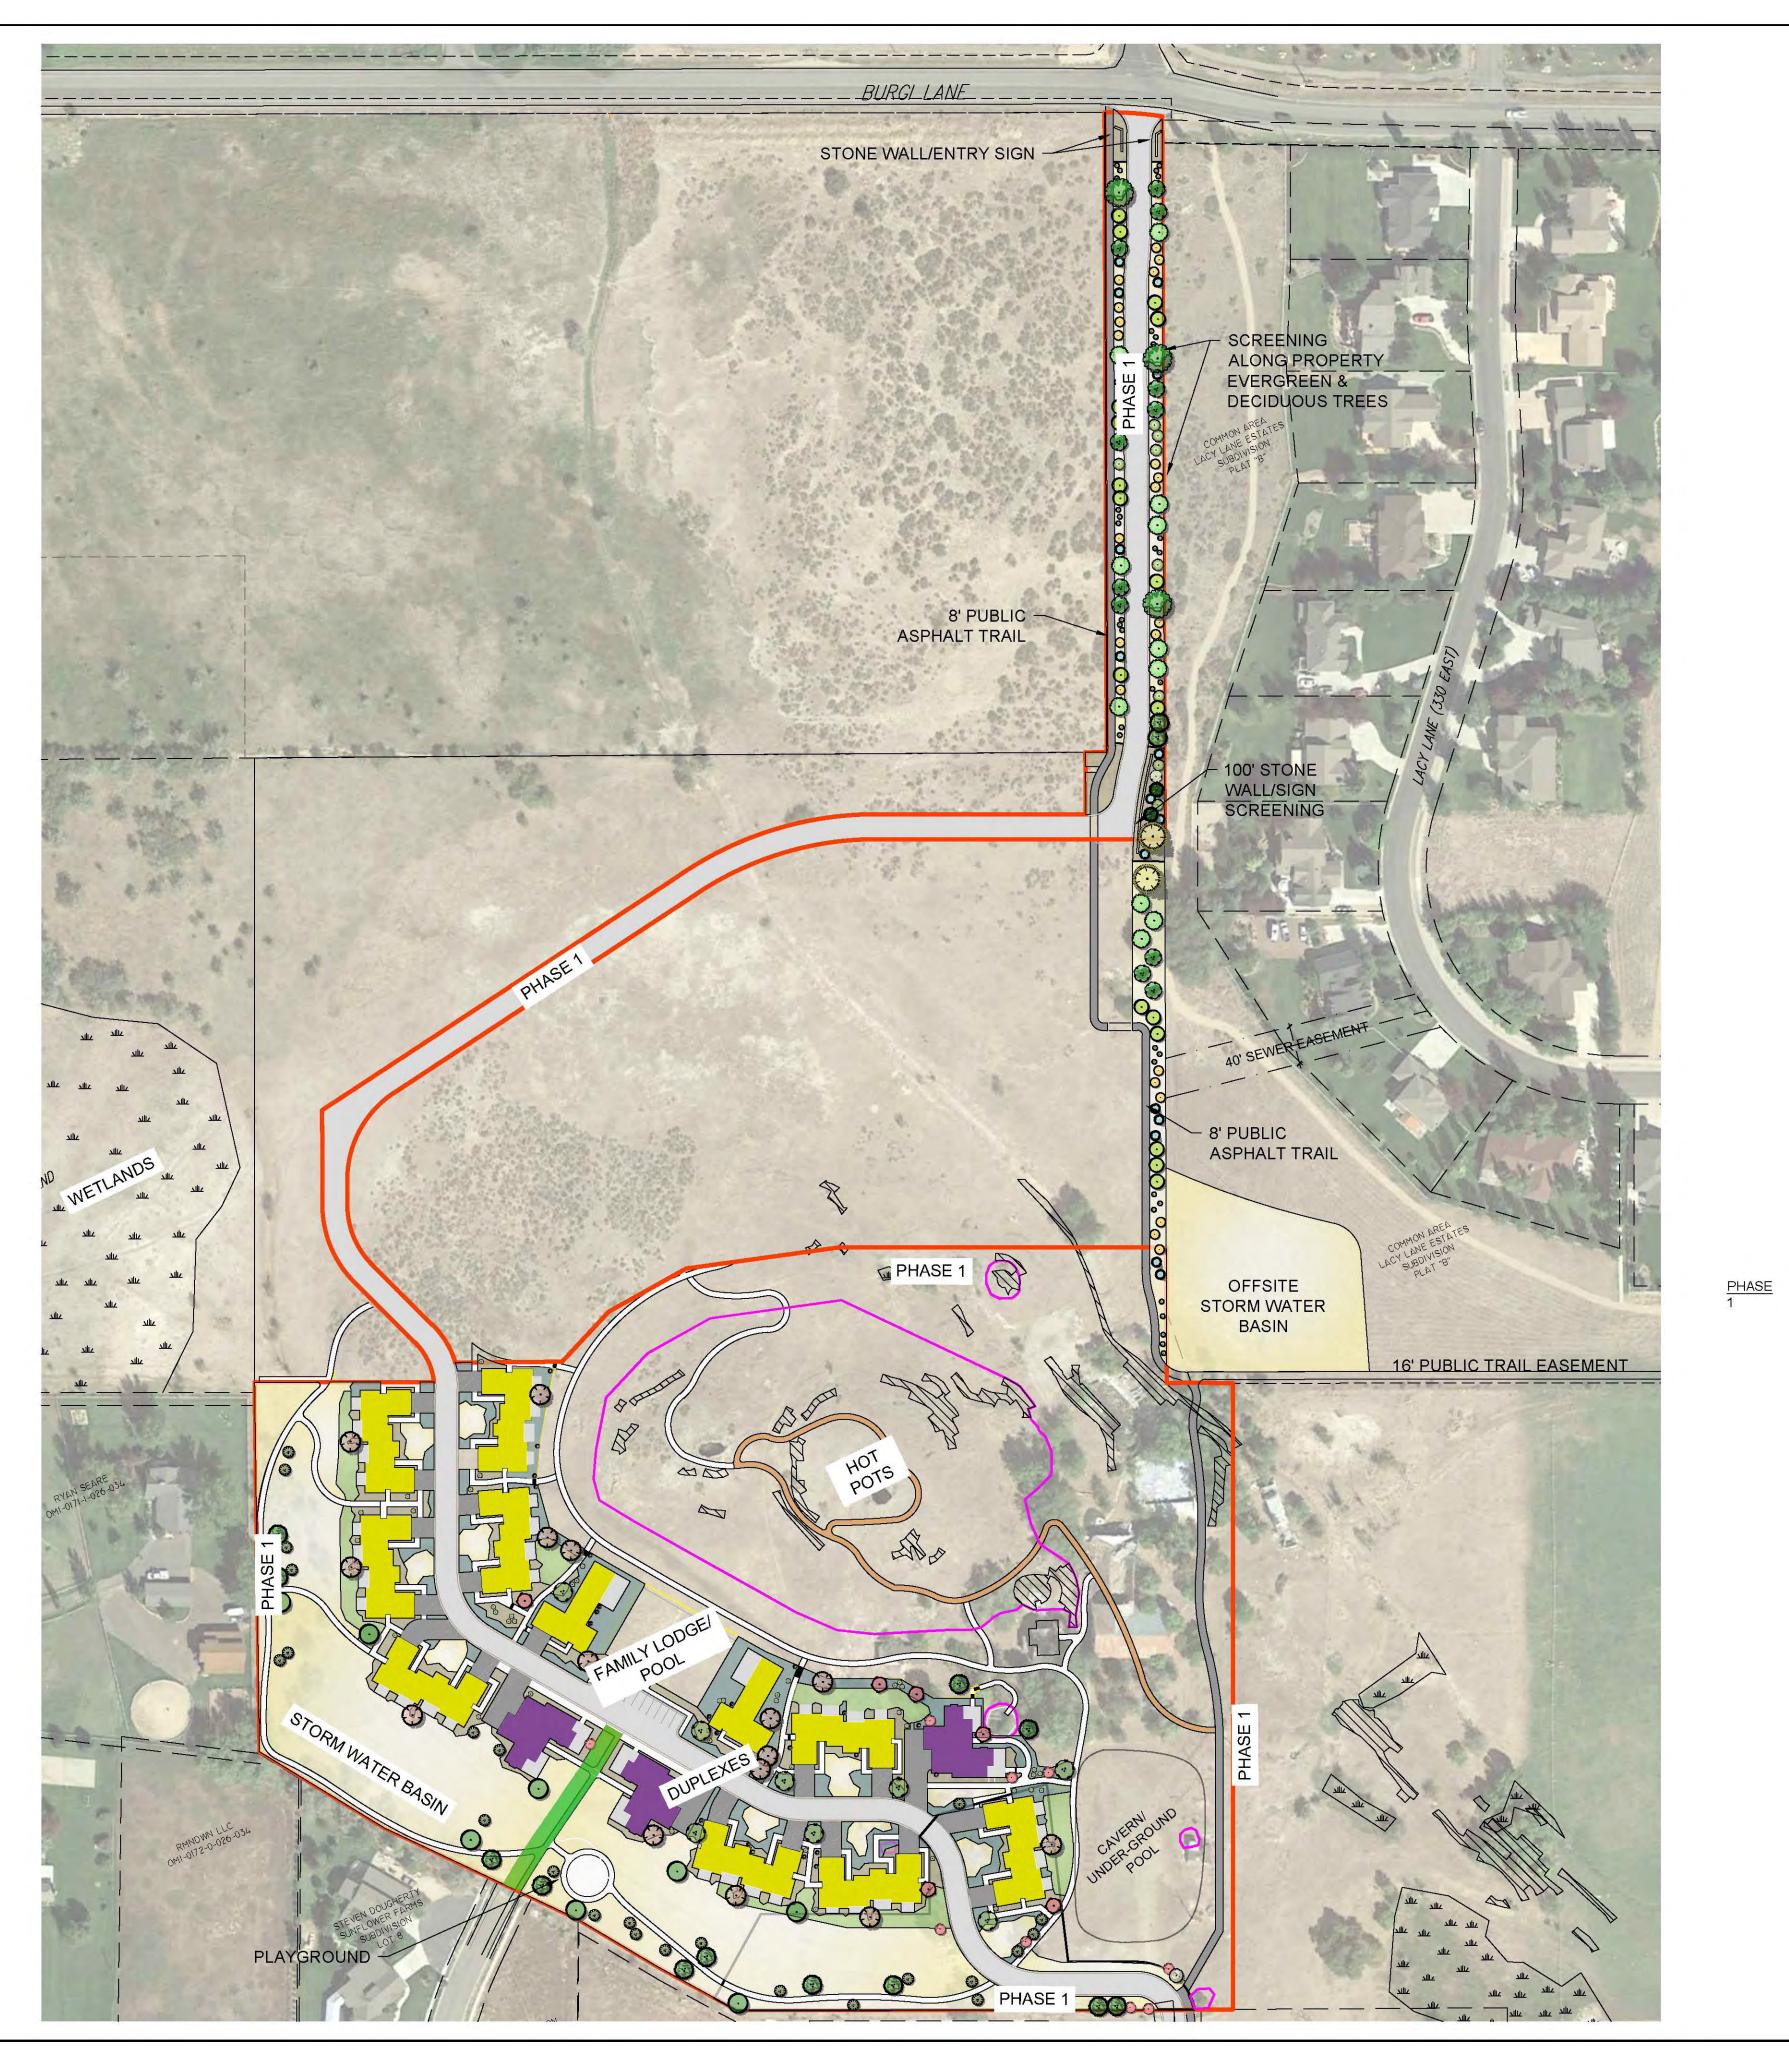

<u>LEGEND</u> علاد علاد الله WETLANDS (3.75 ACRES) SLOPES > 25% (0.33 ACRES OUTSIDE OF HOT POT/CRATER) HOT POT/CRATER SENSITIVE LANDS (3.52 ACRES) 8' PUBLIC TRAIL (ASPHALT) 8' PUBLIC TRAIL (SOFT SURFACE) PRIVATE TRAILS

GRASS/NATIVE MULCH
(IRRIGATED)
73,063 SF (IRRIGATED)
52,960 SF

NATIVE/UNDISTURBED


TREES IN NATURAL AREA 400 SF (10 SF PER TREE, 40 TREES)

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SERIAL NO. 295595 DATE: __14 NOV 2022

PAUL D. BERG

TOTAL IRRIGATED (GRASS, MULCH AND TREES) 126,423 SF

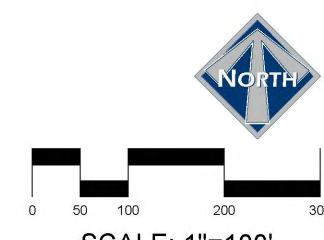


SCALE: 1"=100' Scale 1" = 200' for 11x17


CHUCK HEATH AMEYALLI PHASE 1


PHASE 1 SITE PLAN


BERG ENGINEERING
380 E Main St. Suite 204
Midway, Ut 84049
ph 435.657.9749


DESIGN BY: PDB DATE: 14 NOV 2022 SHEET DRAWN BY: DAW REV: 5

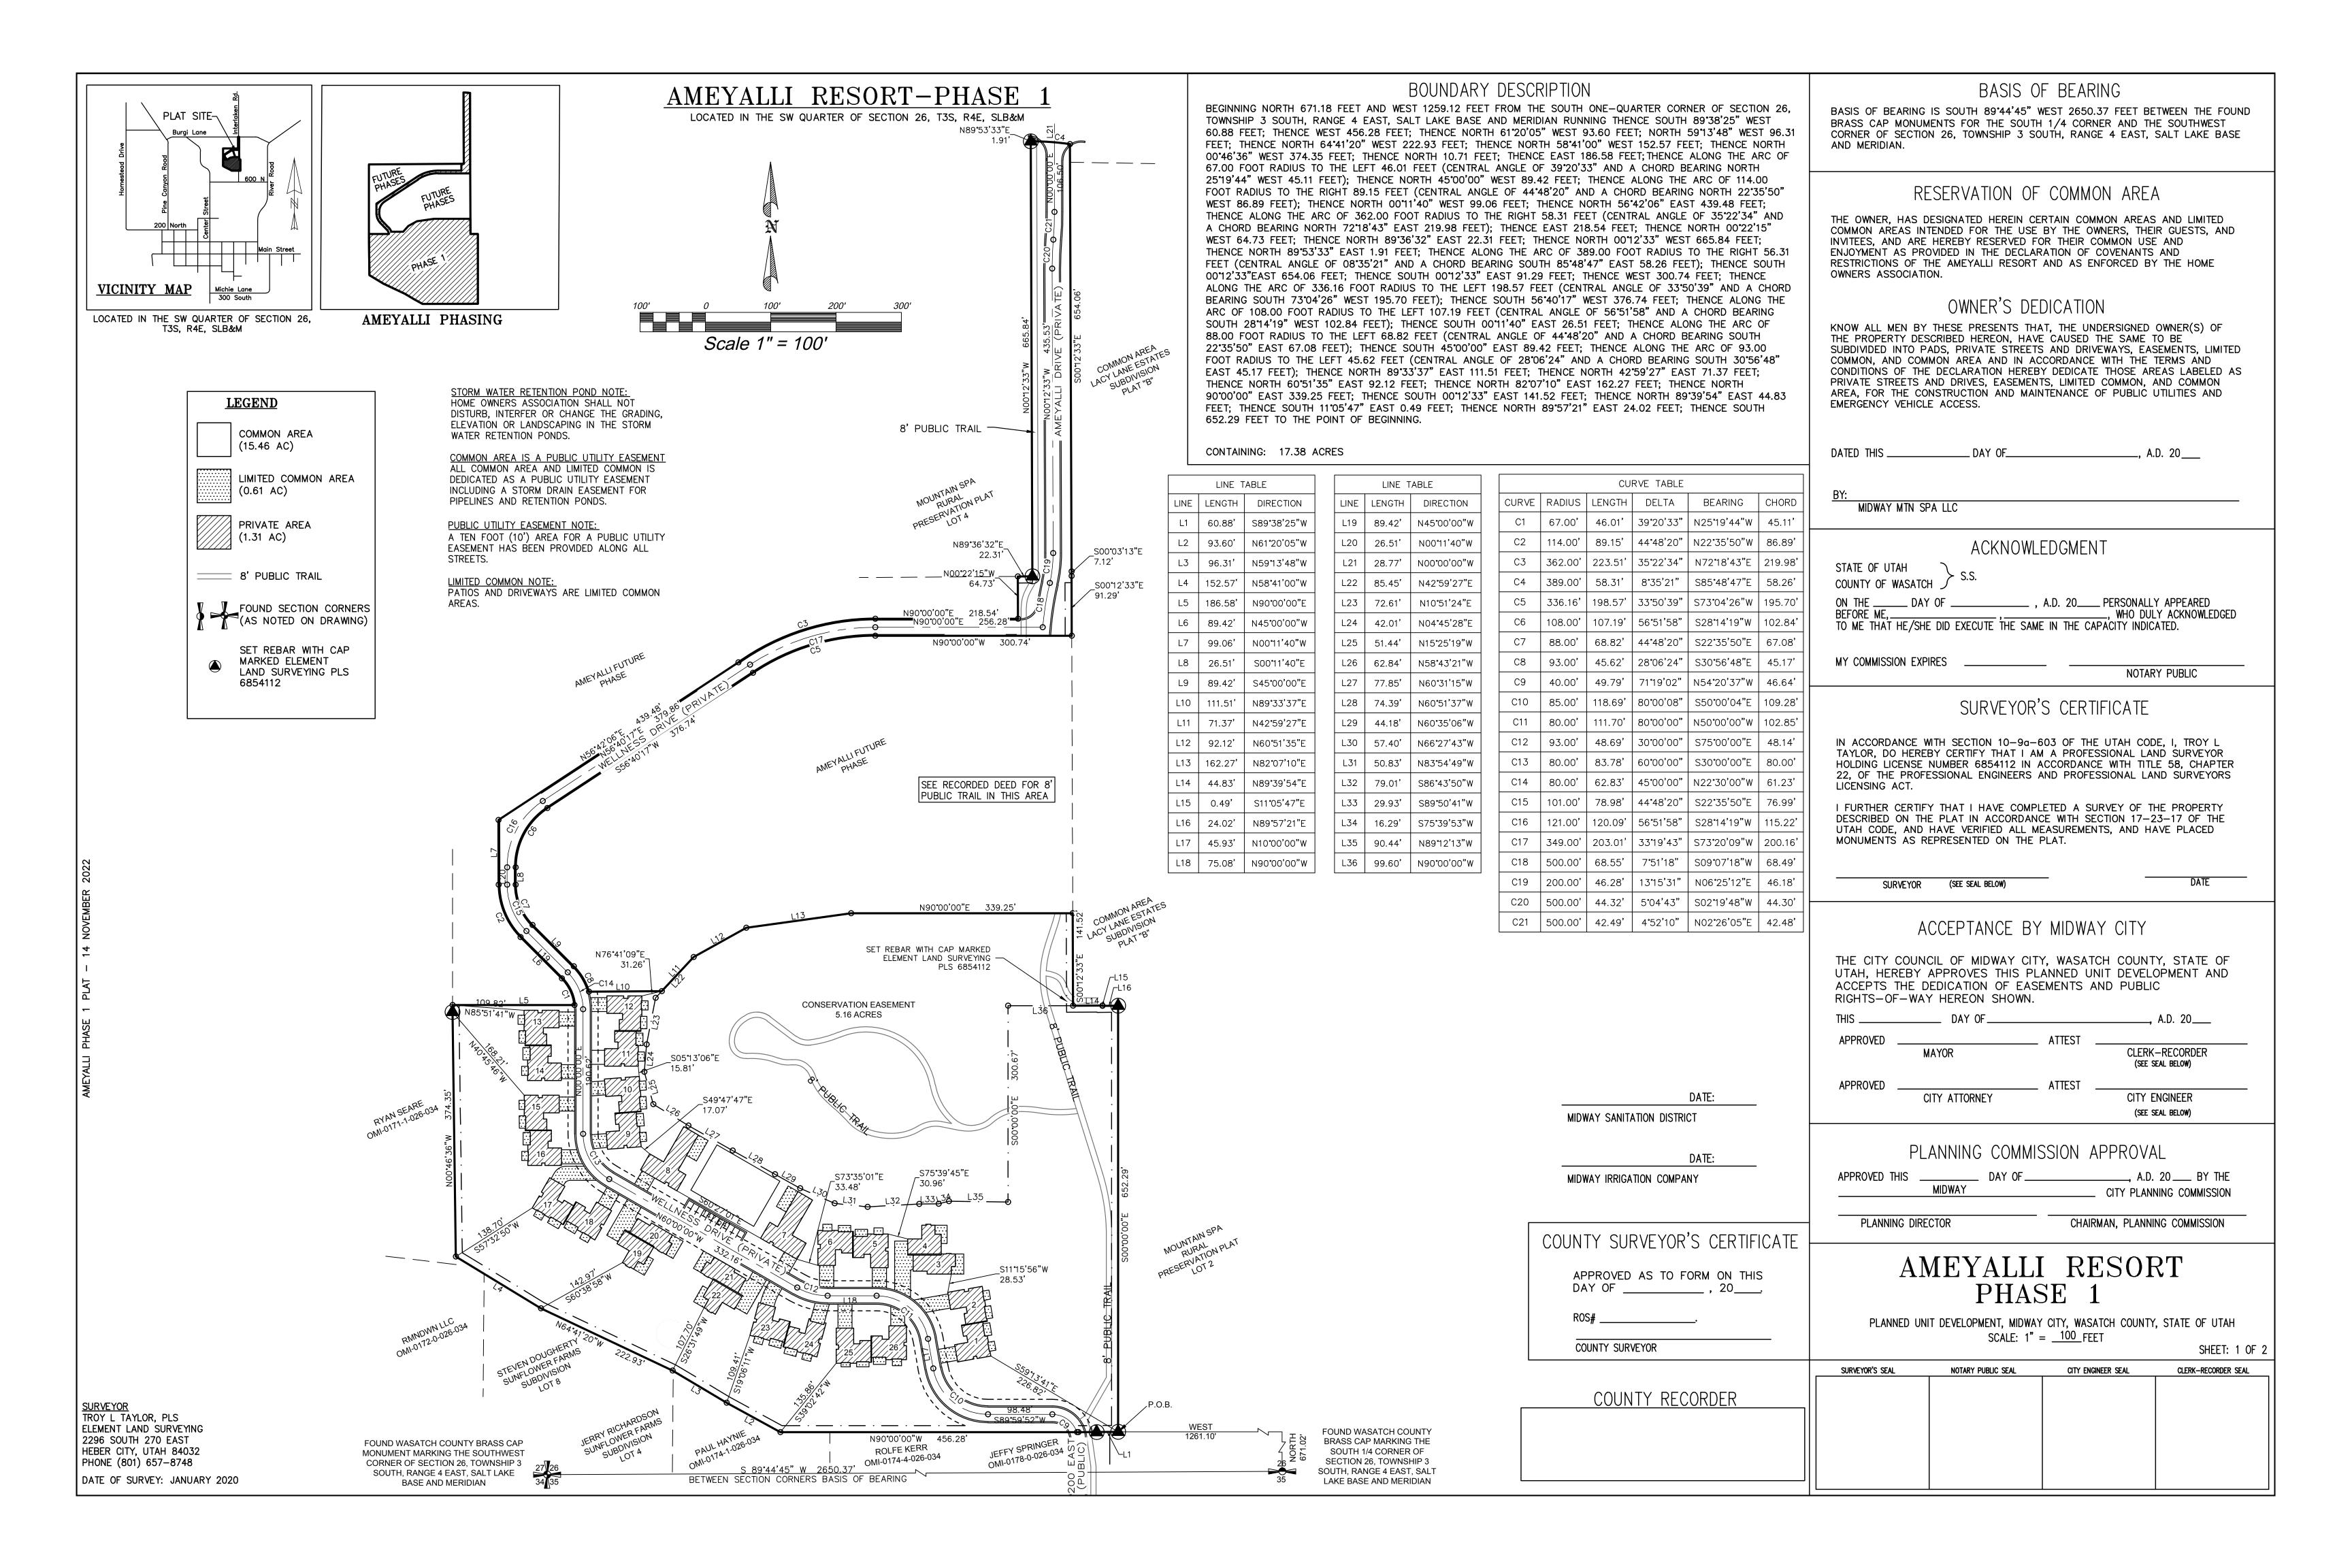


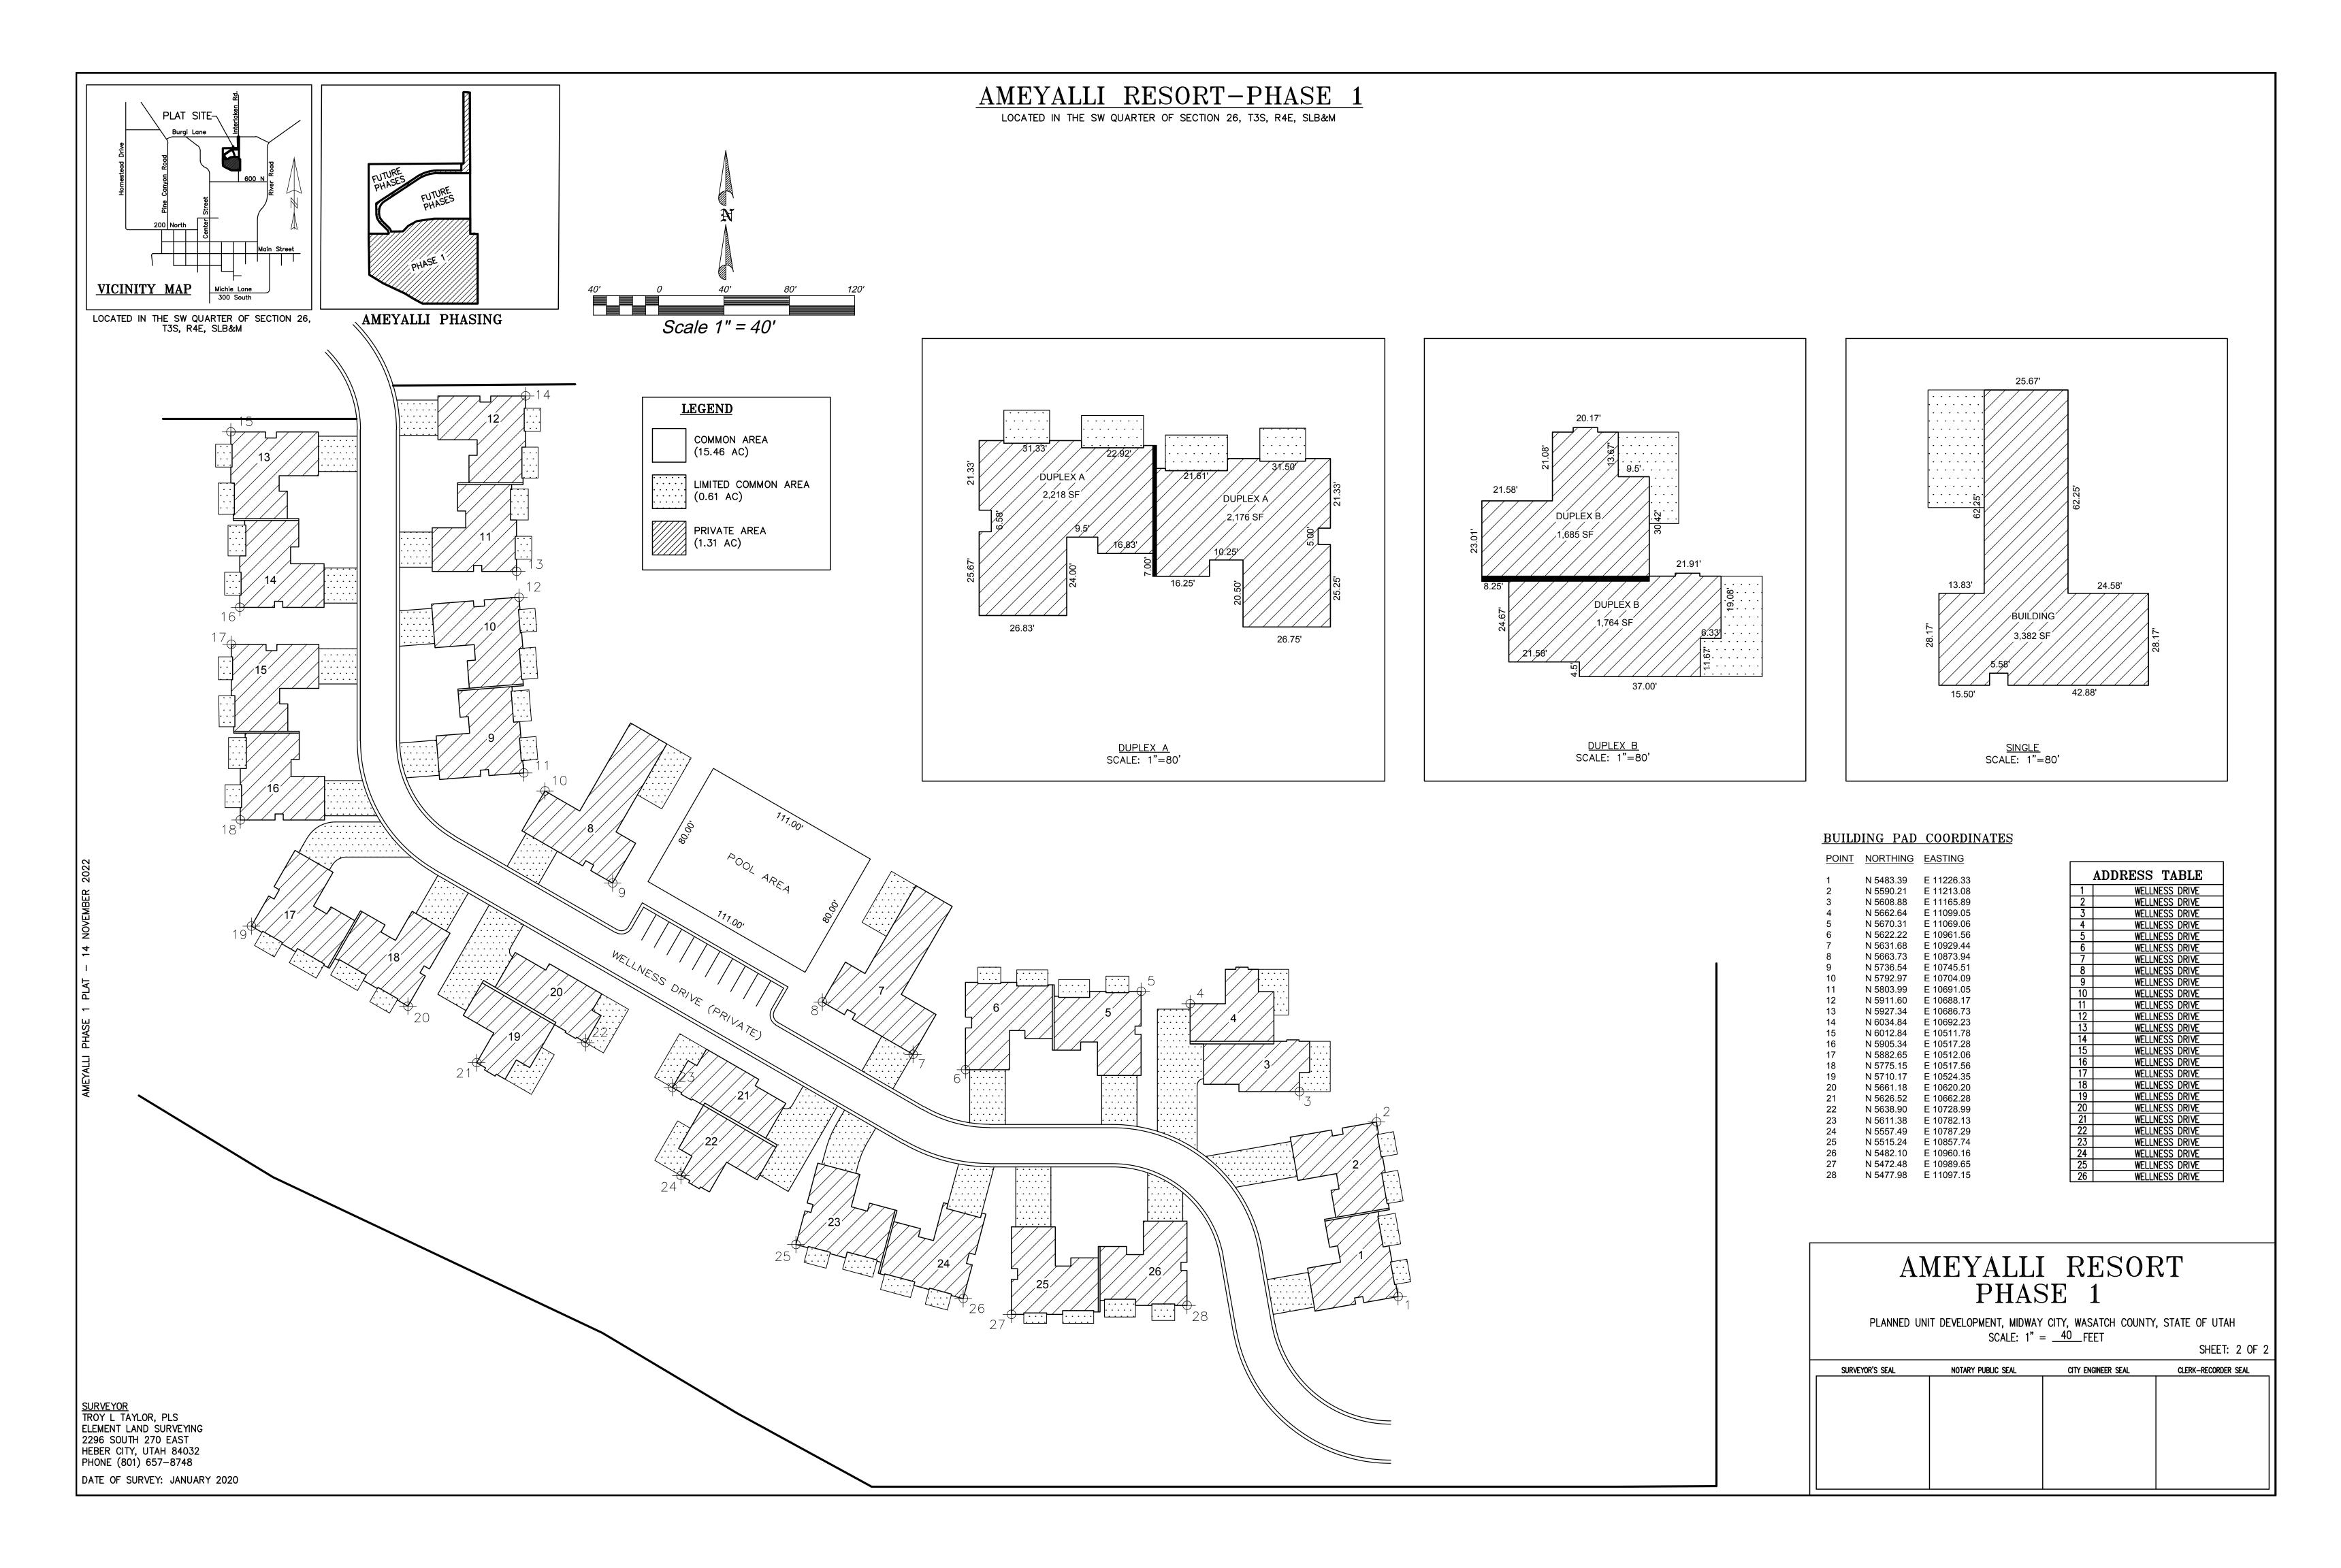


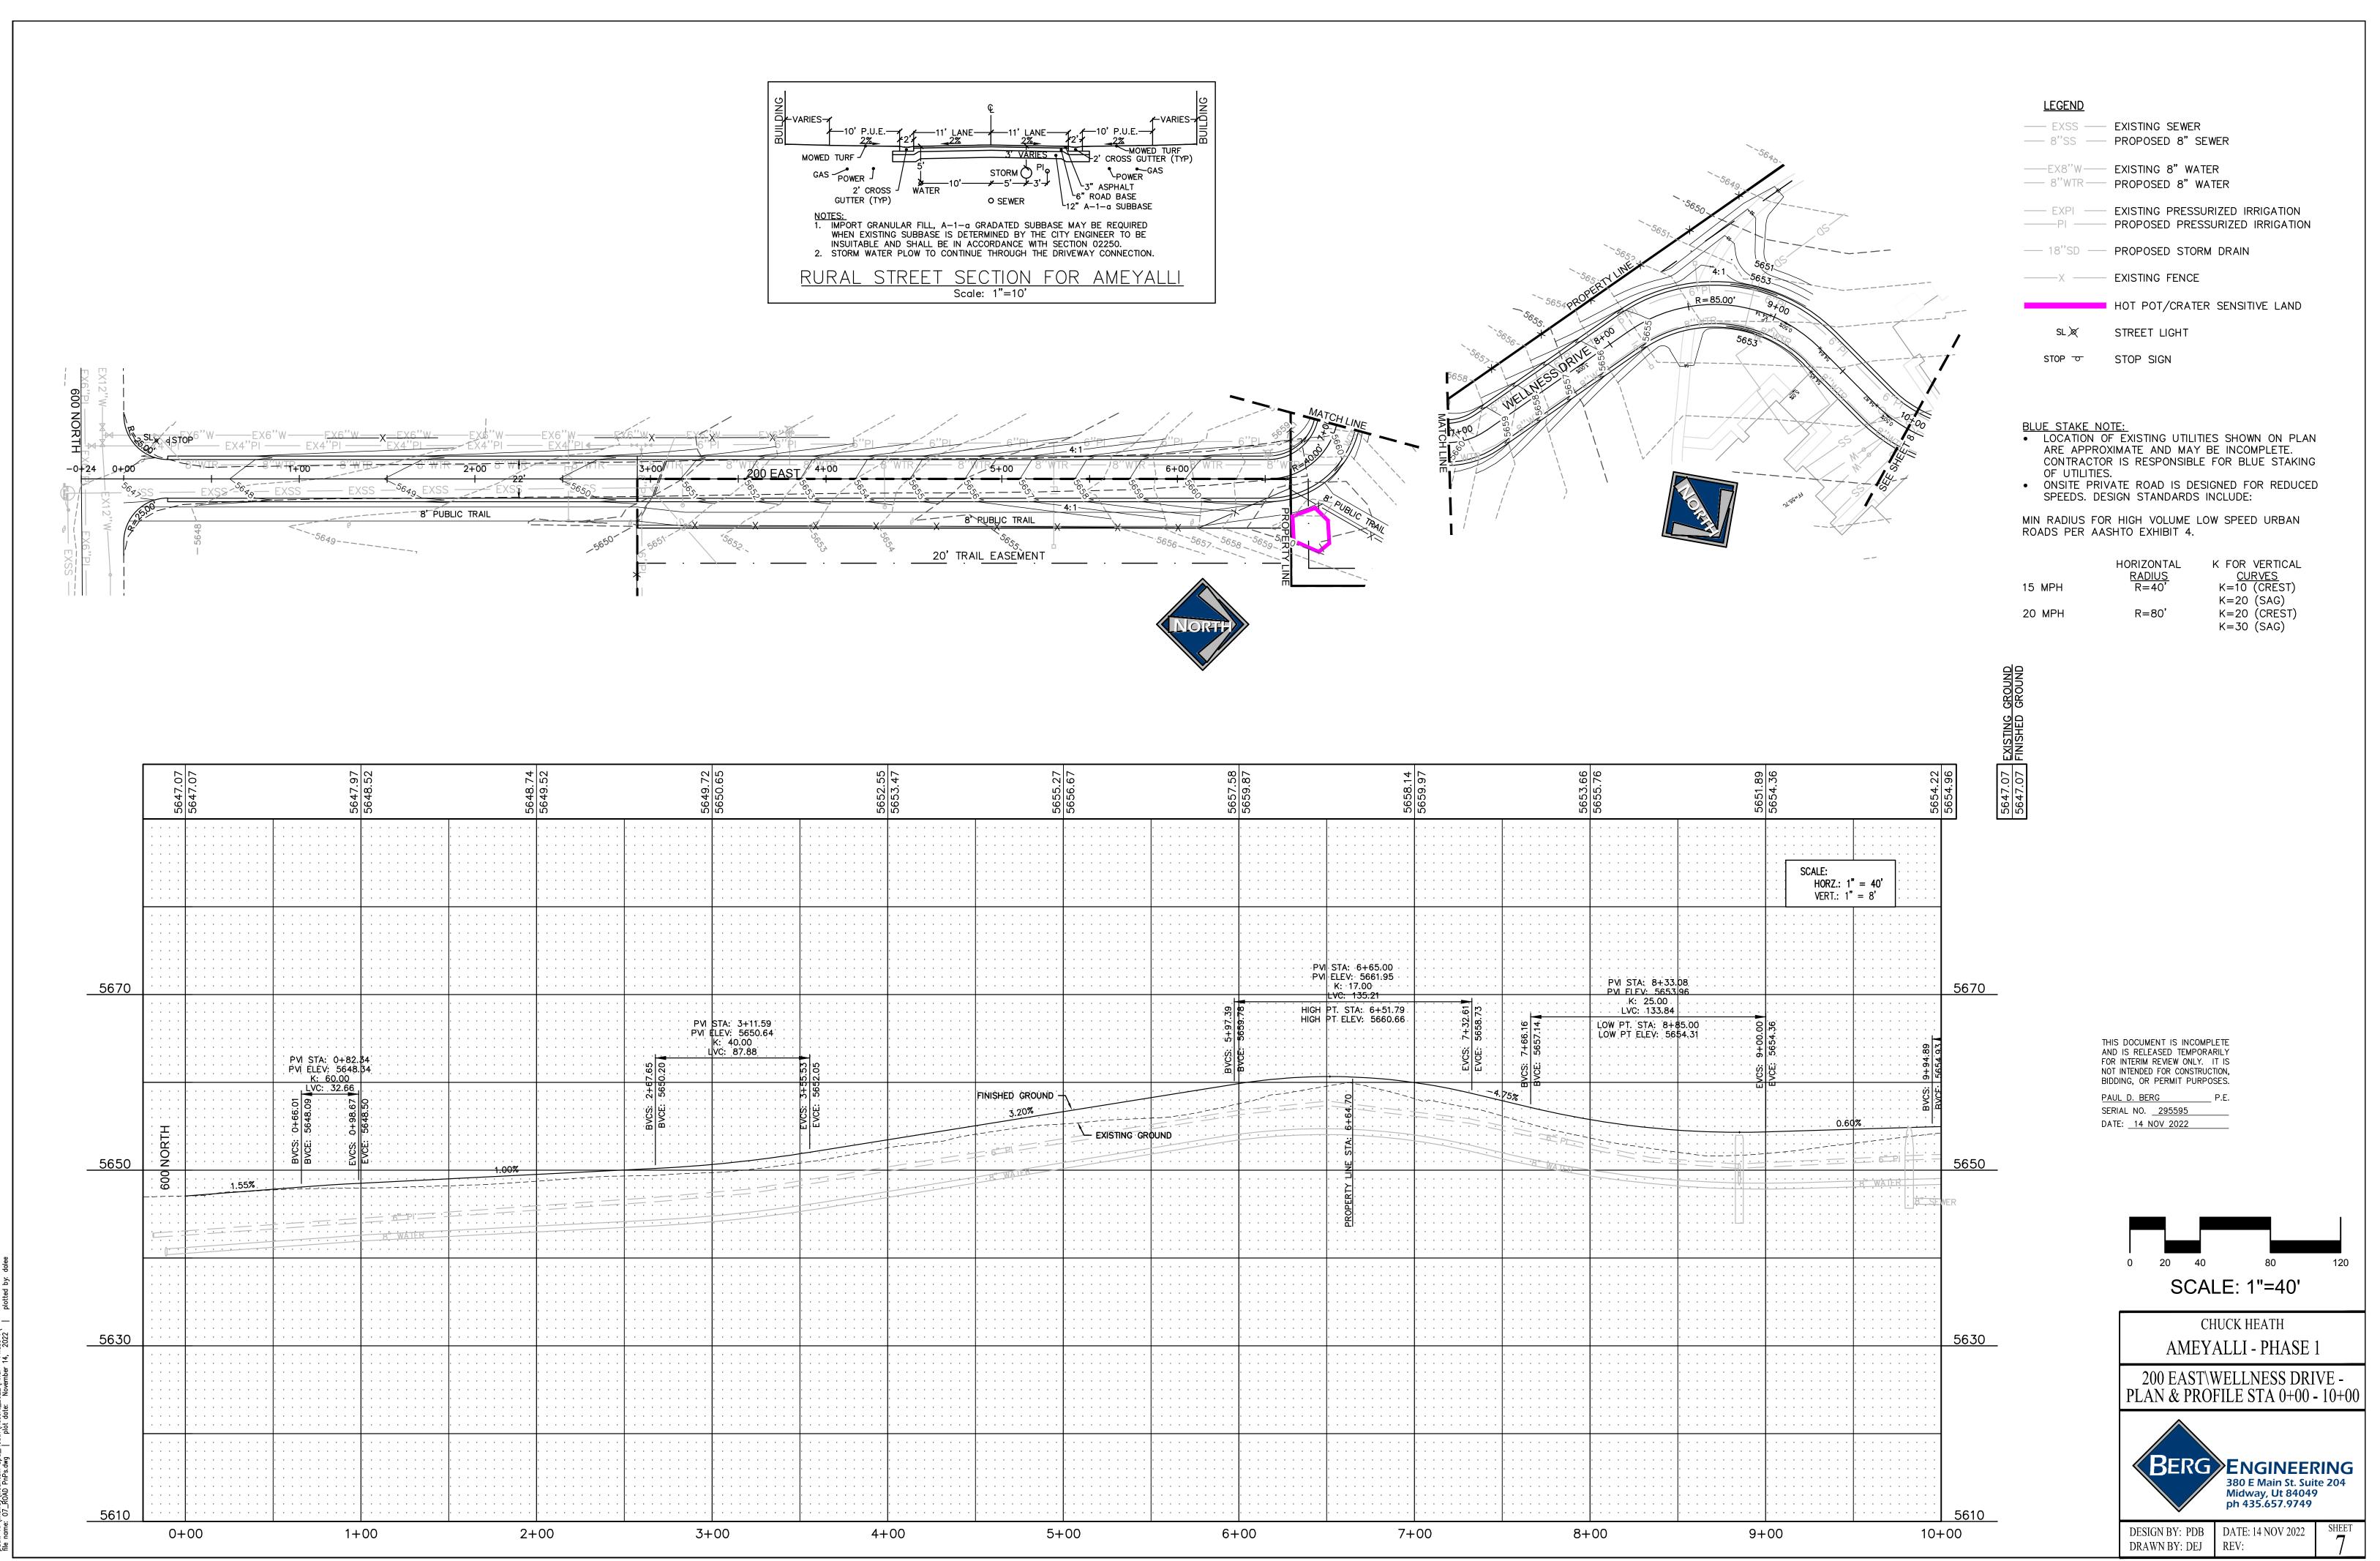


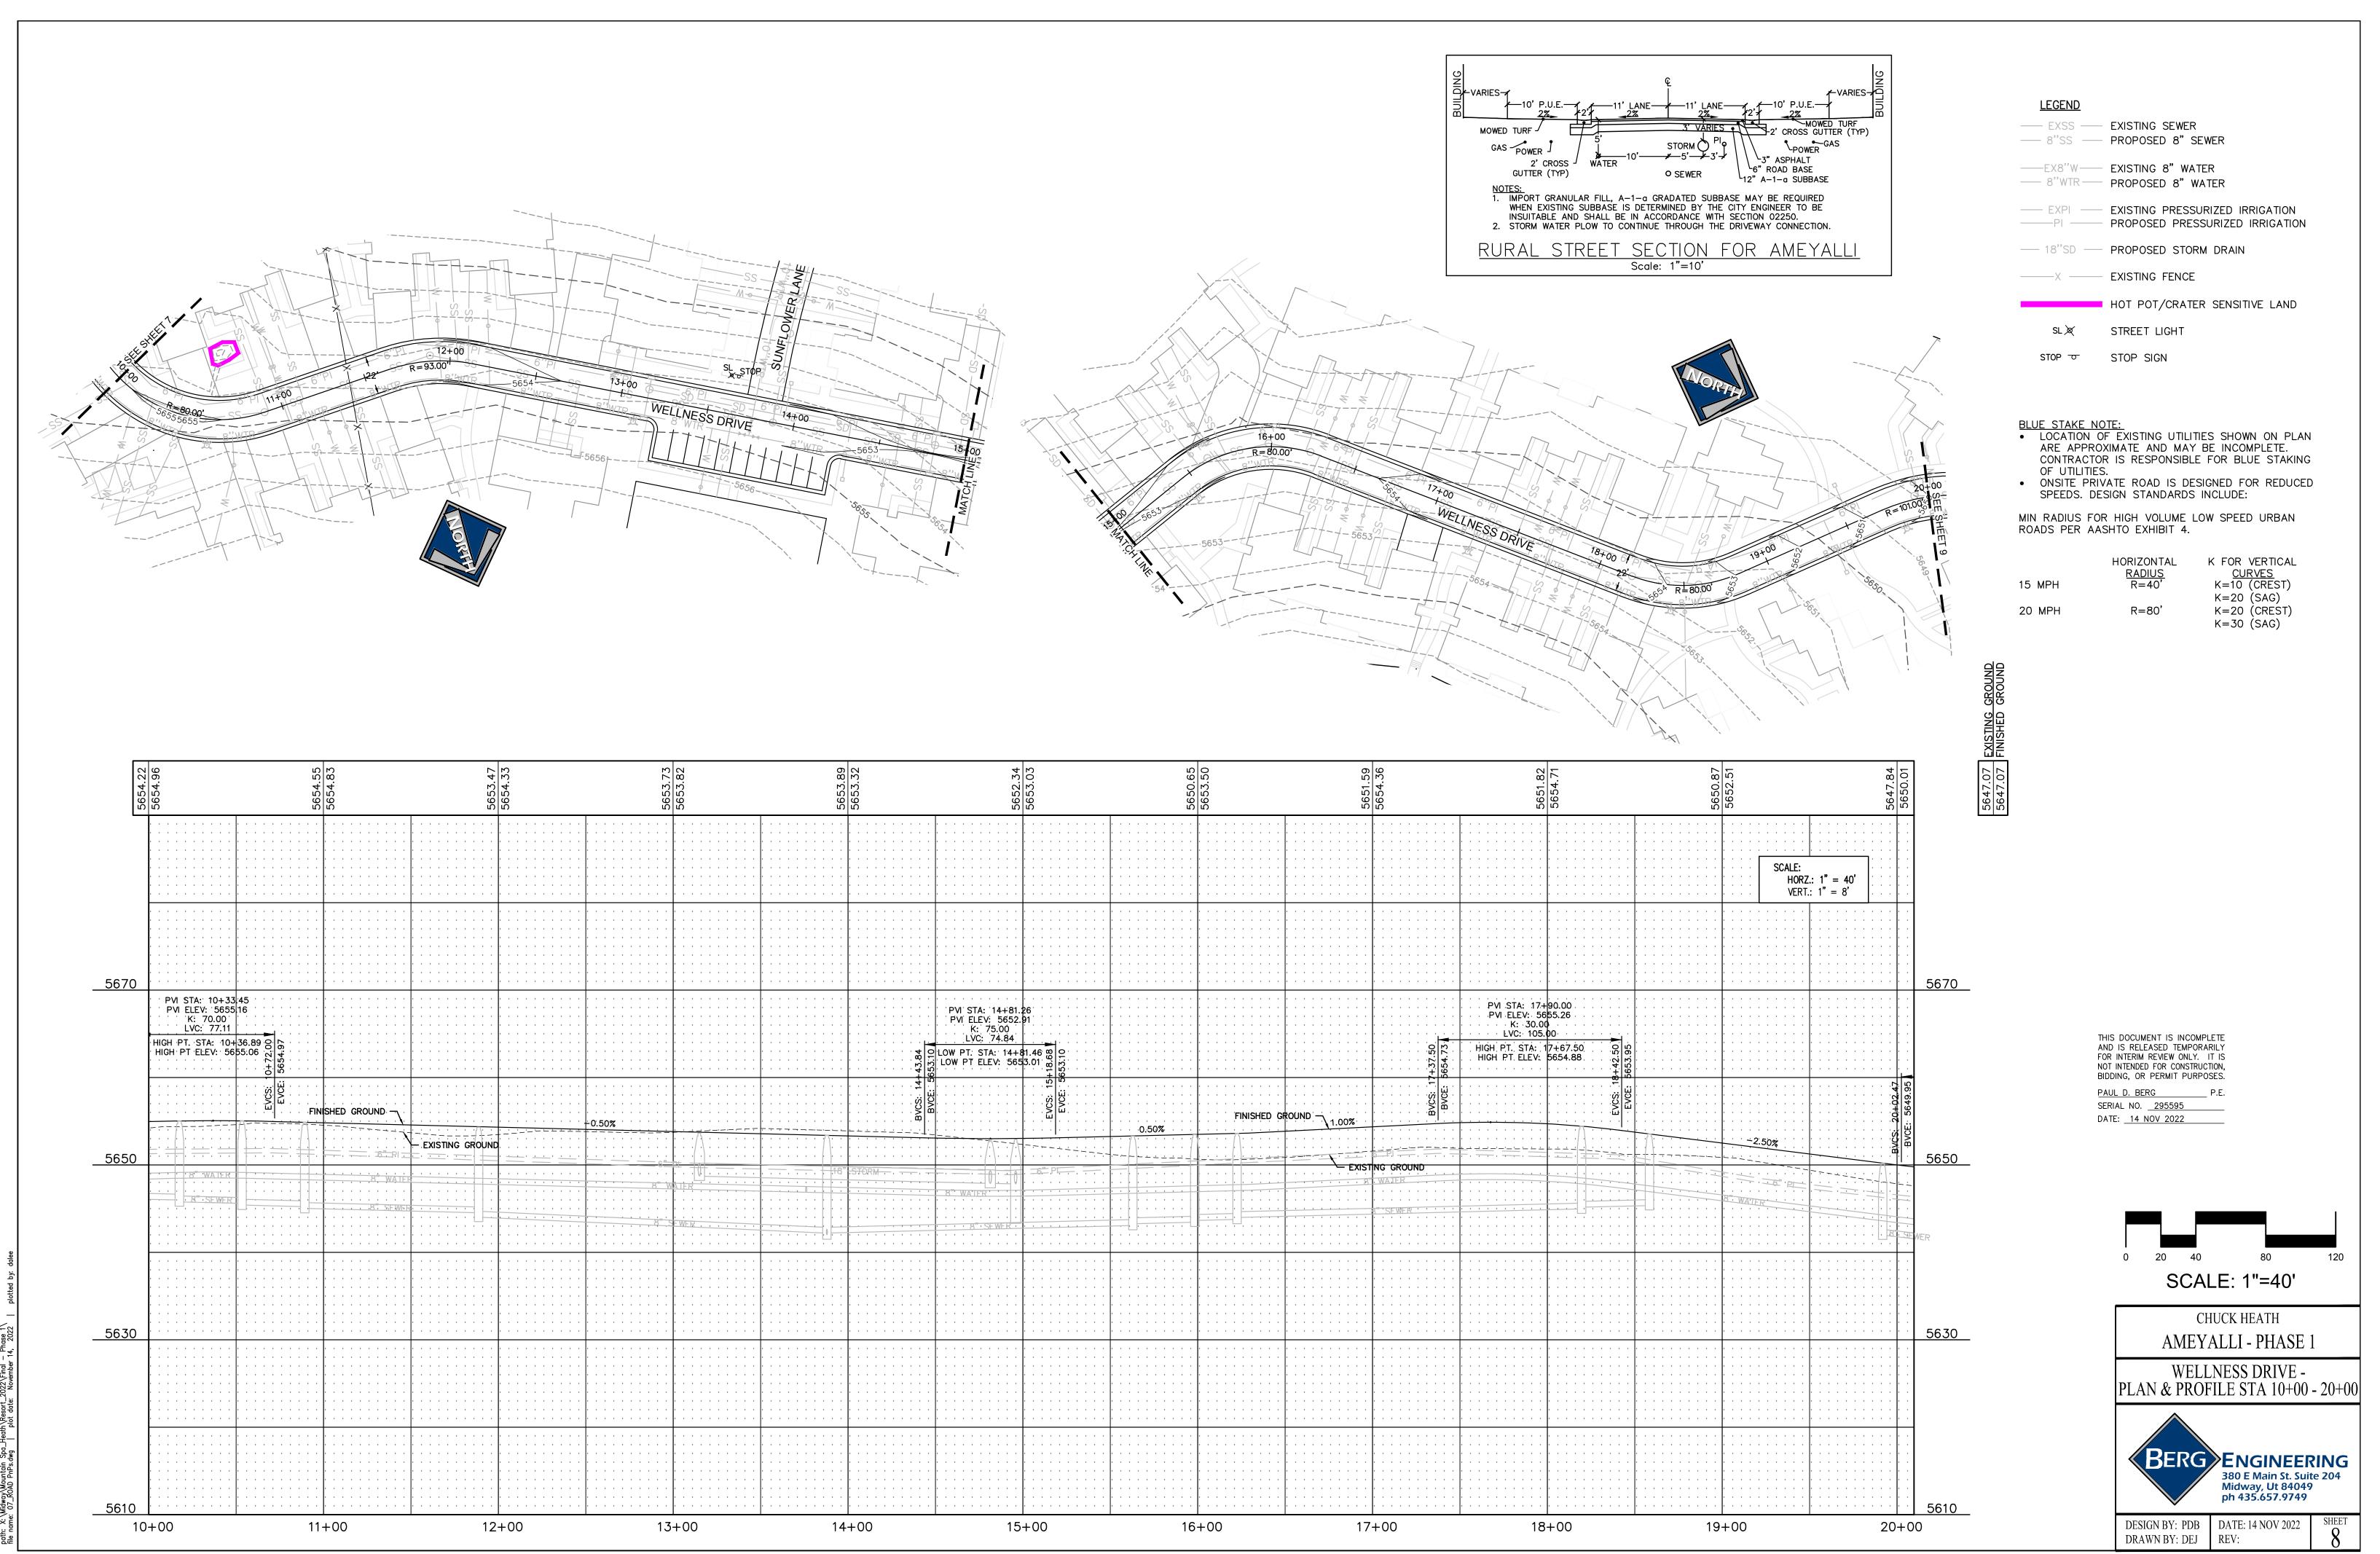


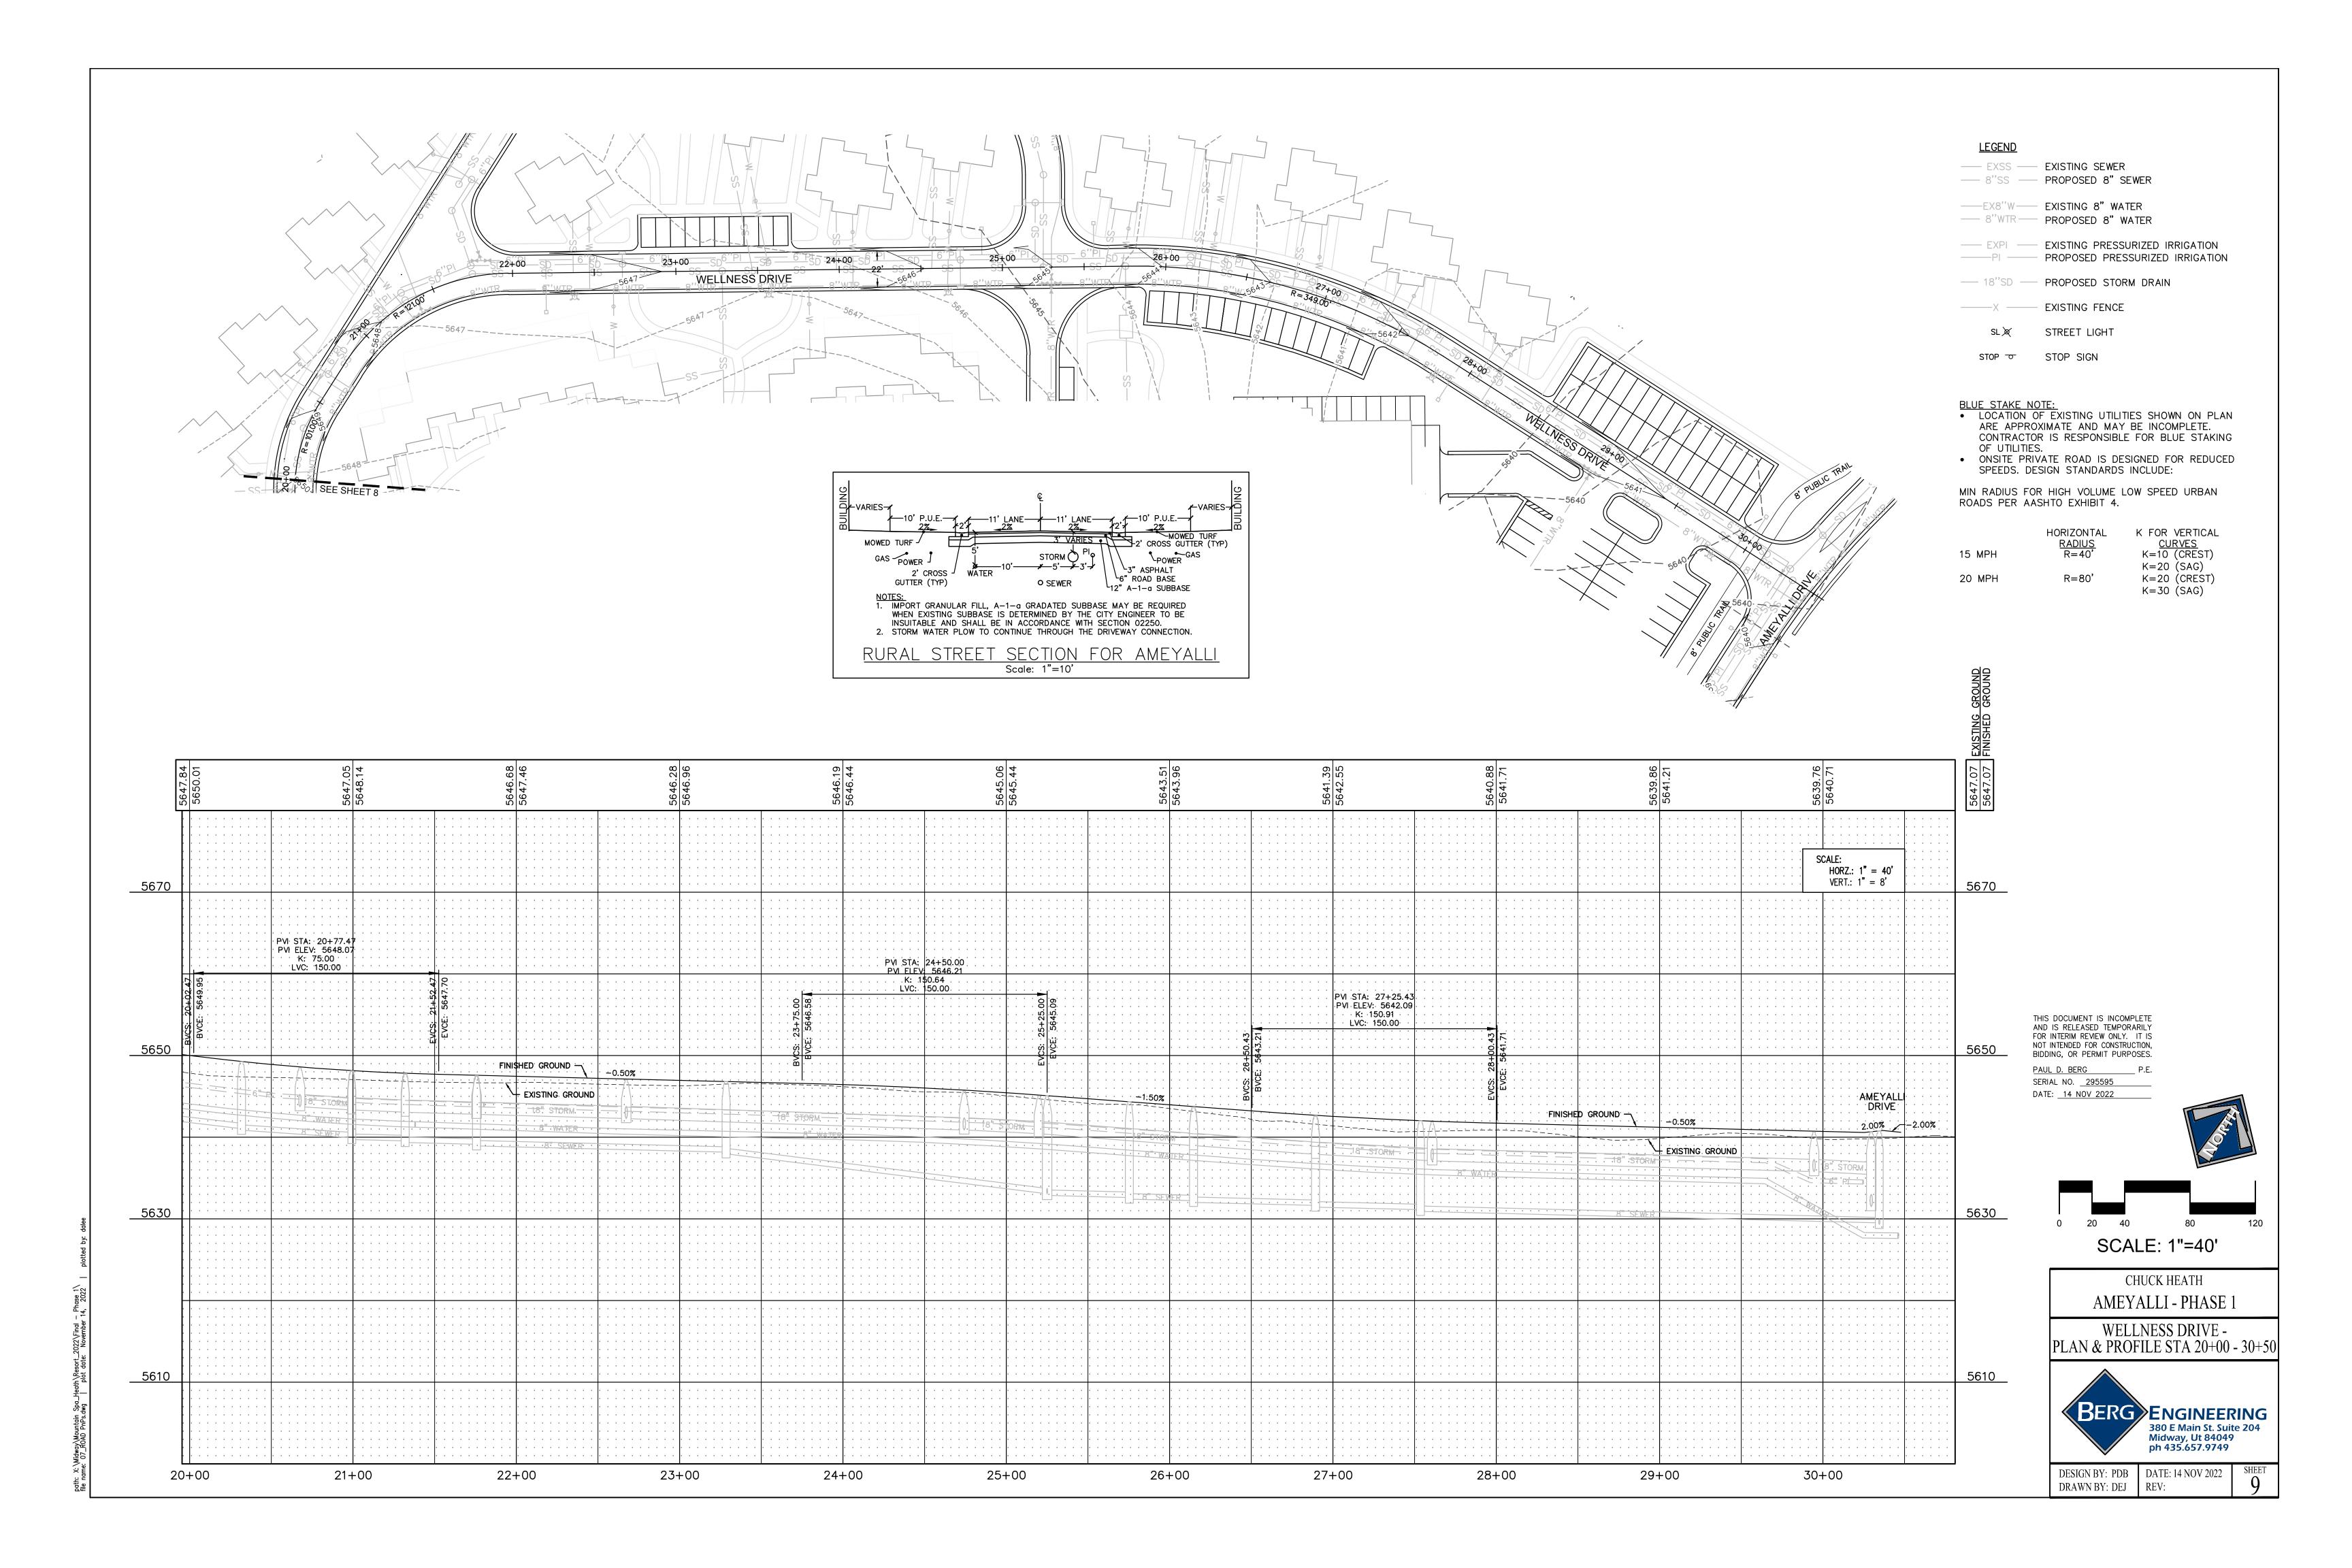

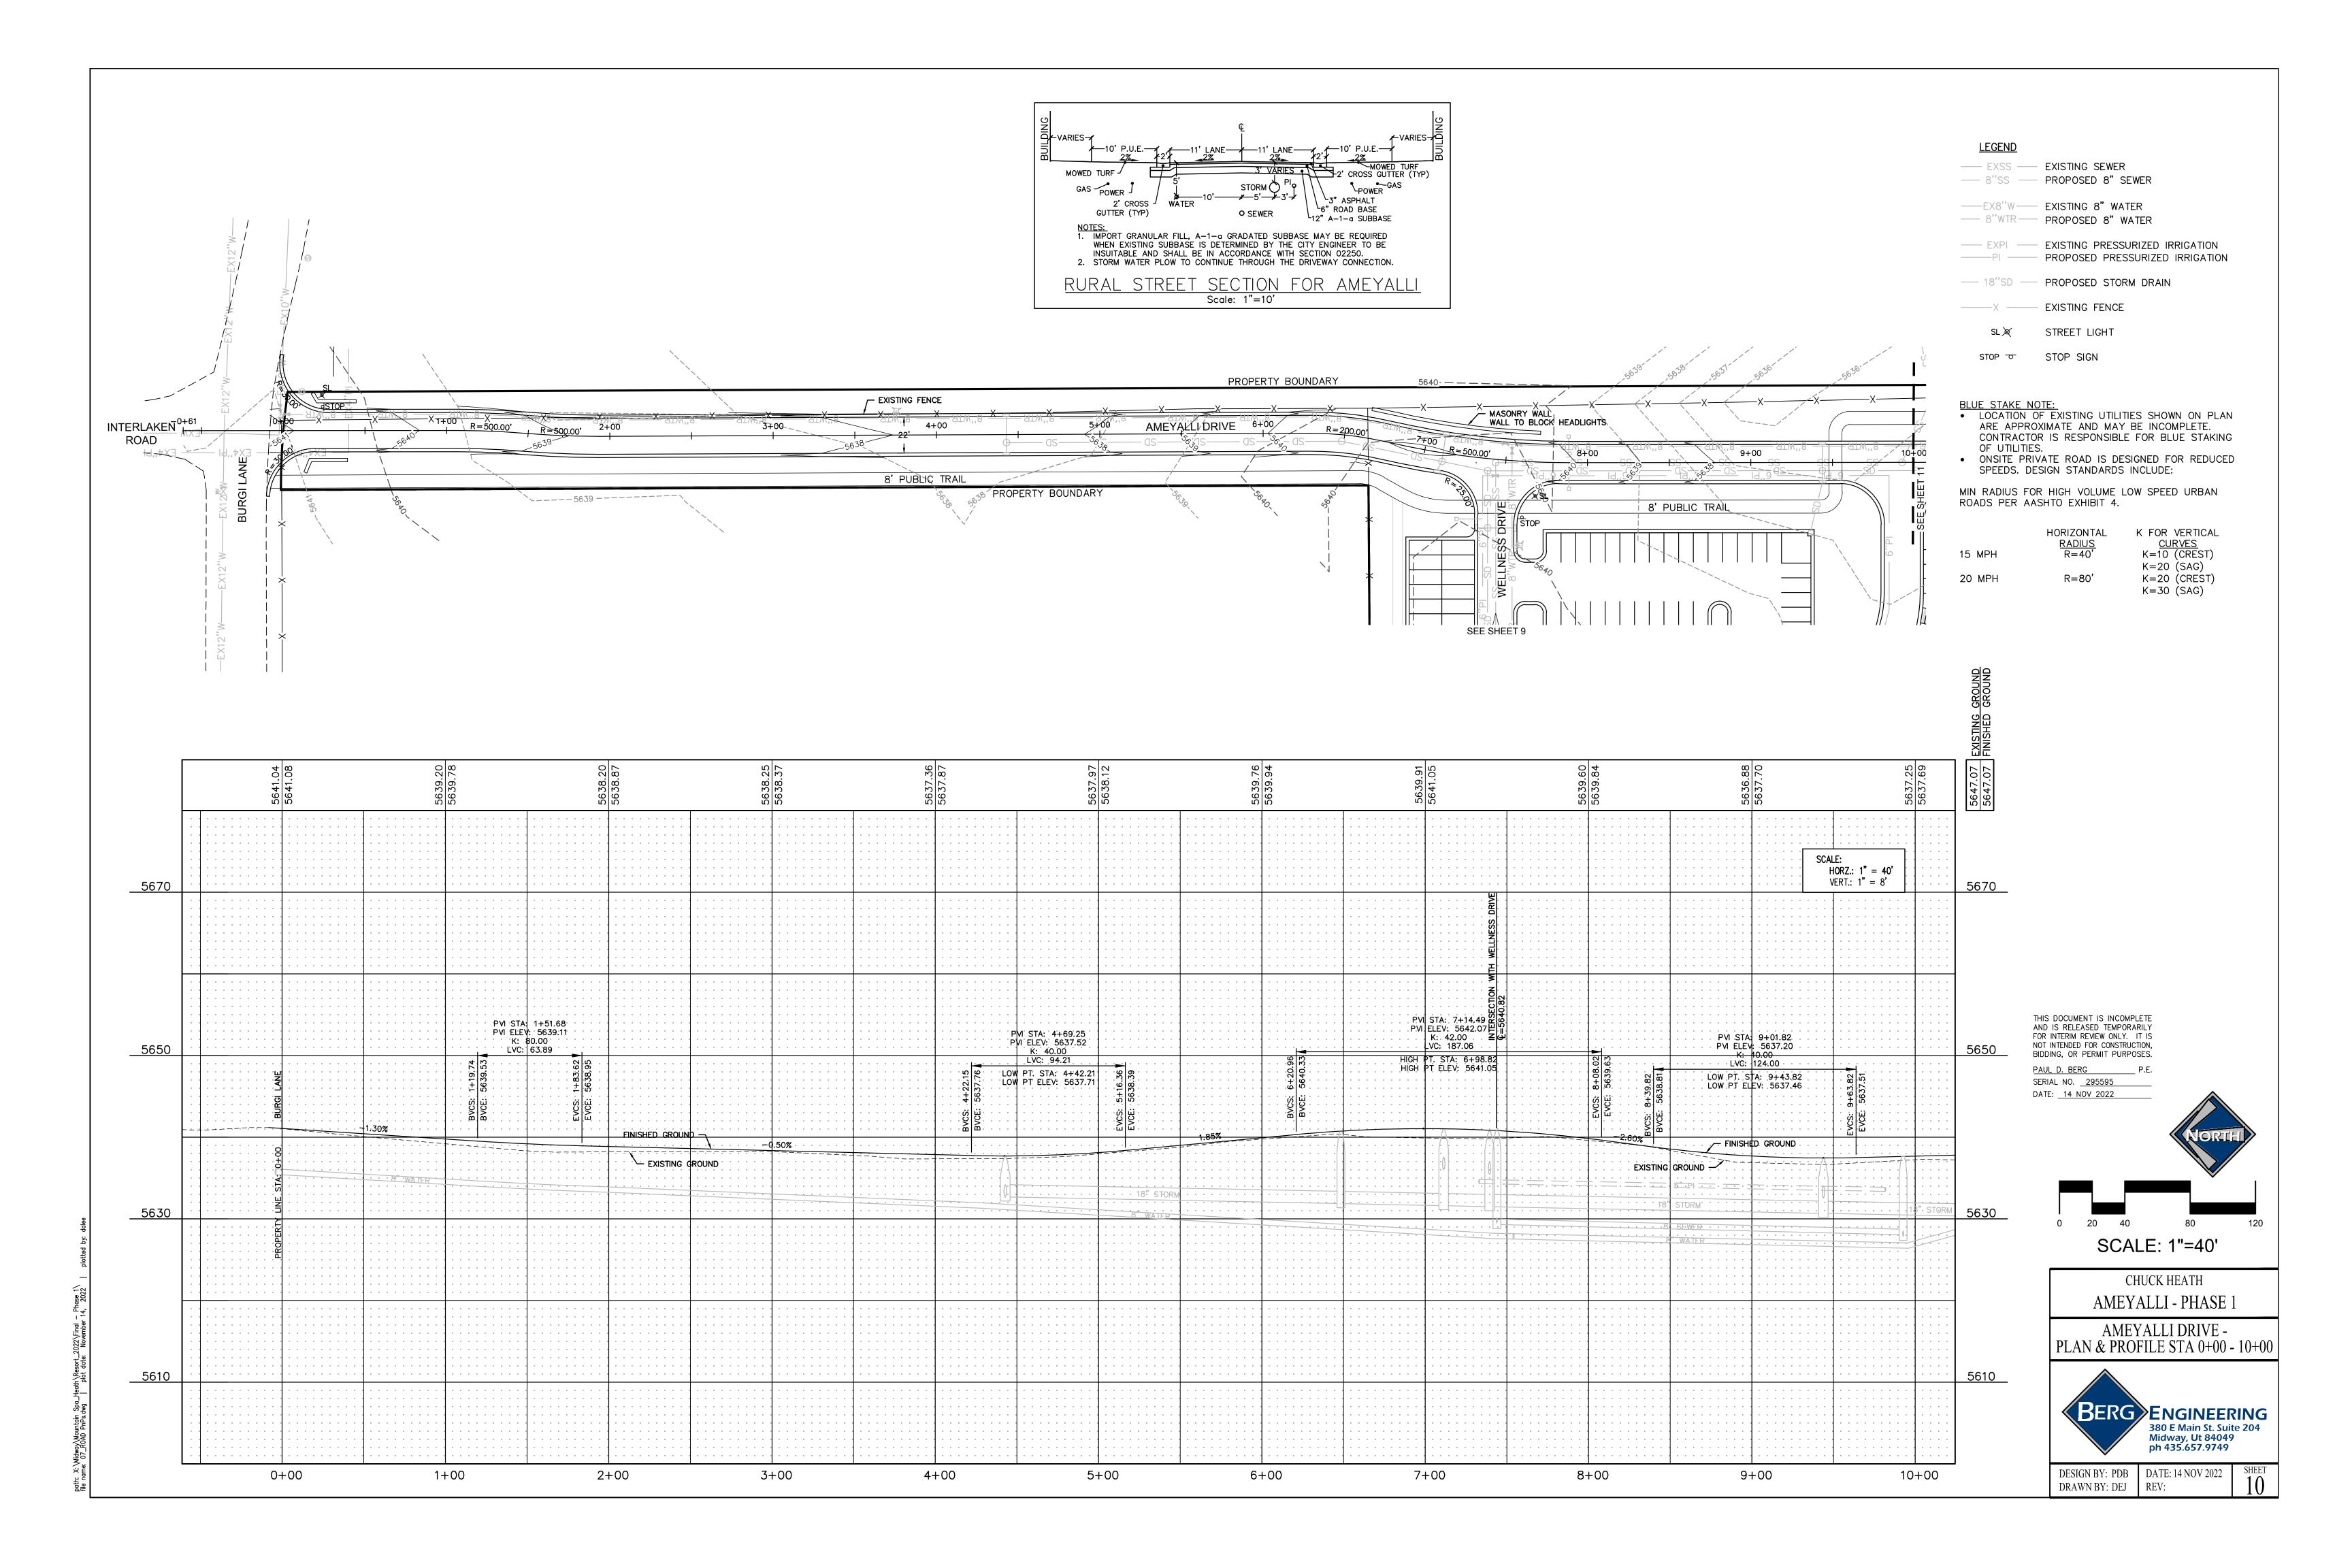

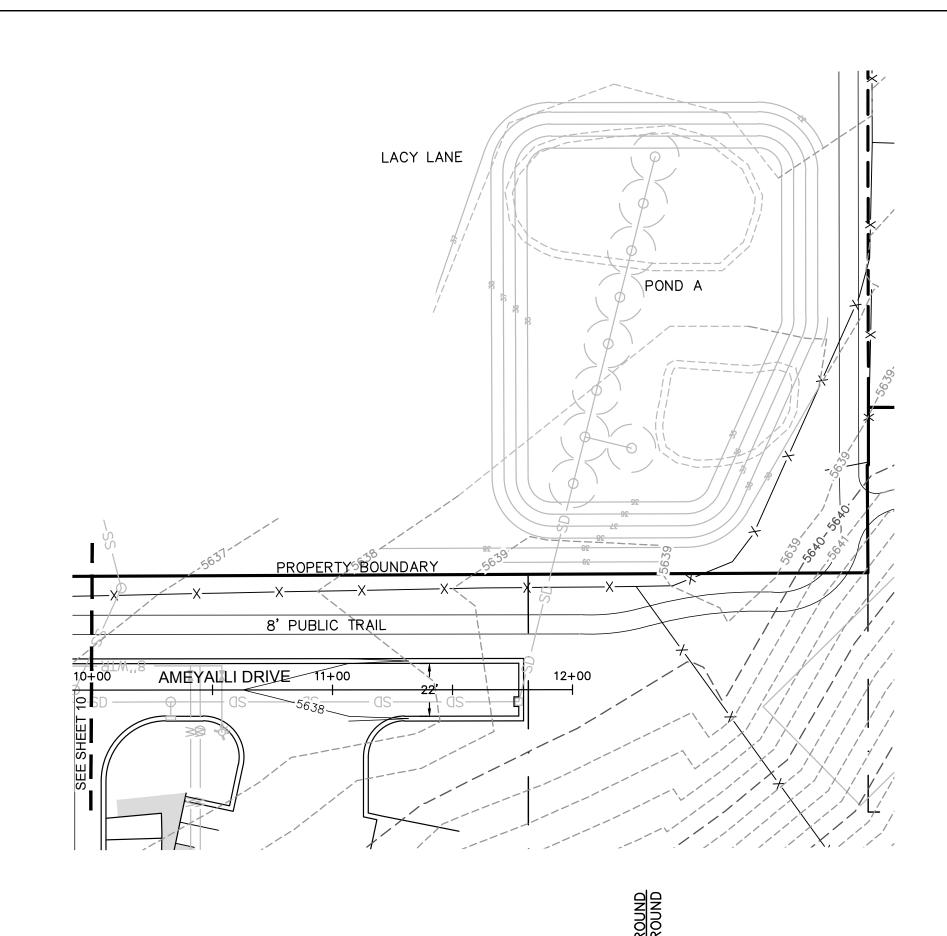

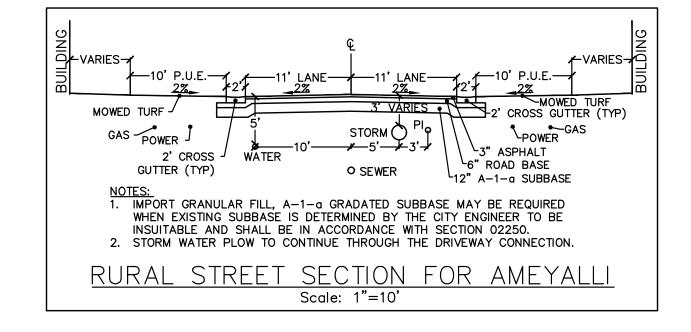

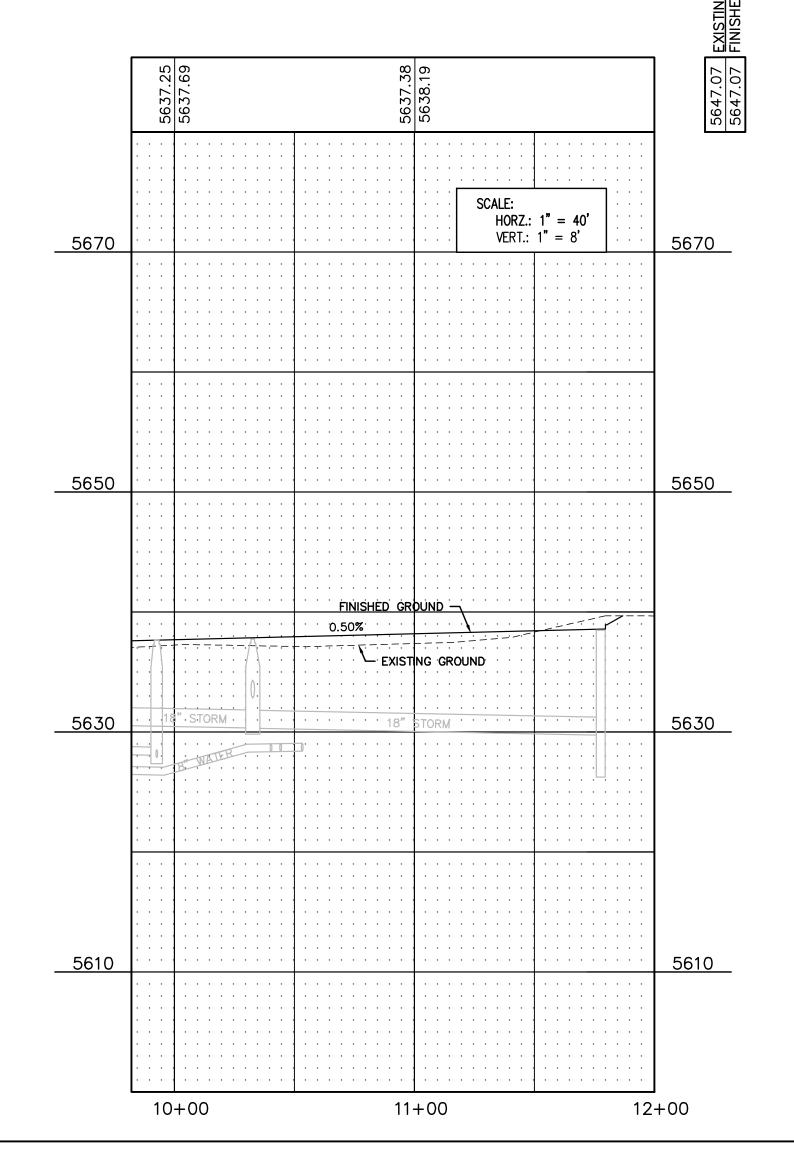

<u>LEGEND</u>

--- EXSS --- EXISTING SEWER — 8"SS — PROPOSED 8" SEWER

---EX8"W --- EXISTING 8" WATER

— 8"WTR — PROPOSED 8" WATER

--- EXPI --- EXISTING PRESSURIZED IRRIGATION Proposed Pressurized Irrigation

— 18"SD — PROPOSED STORM DRAIN

STREET LIGHT

STOP STOP SIGN


BLUE STAKE NOTE:

LOCATION OF EXISTING UTILITIES SHOWN ON PLAN ARE APPROXIMATE AND MAY BE INCOMPLETE. CONTRACTOR IS RESPONSIBLE FOR BLUE STAKING OF UTILITIES.

 ONSITE PRIVATE ROAD IS DESIGNED FOR REDUCED SPEEDS. DESIGN STANDARDS INCLUDE:

MIN RADIUS FOR HIGH VOLUME LOW SPEED URBAN ROADS PER AASHTO EXHIBIT 4.

HORIZONTAL K FOR VERTICAL CURVES K=10 (CREST) 15 MPH K=20 (SAG) K=20 (CREST) 20 MPH K=30 (SAG)

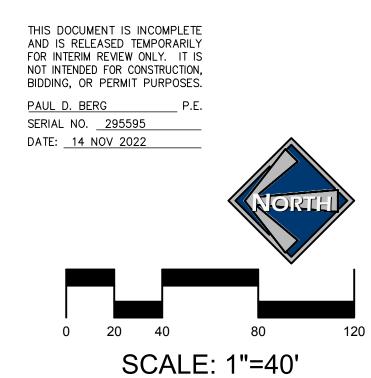


CHUCK HEATH


AMEYALLI - PHASE 1


AMEYALLI DRIVE - PLAN & PROFILE STA 10+00 - 12+00





DESIGN BY: PDB DATE: 14 NOV 2022 DRAWN BY: DEJ REV:

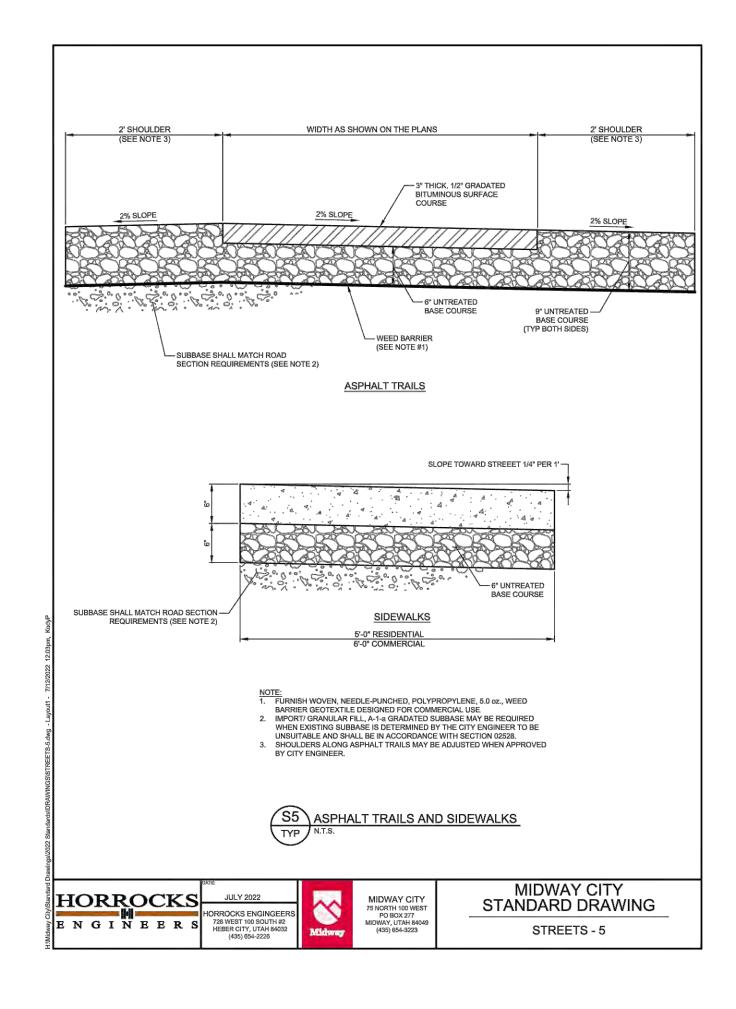


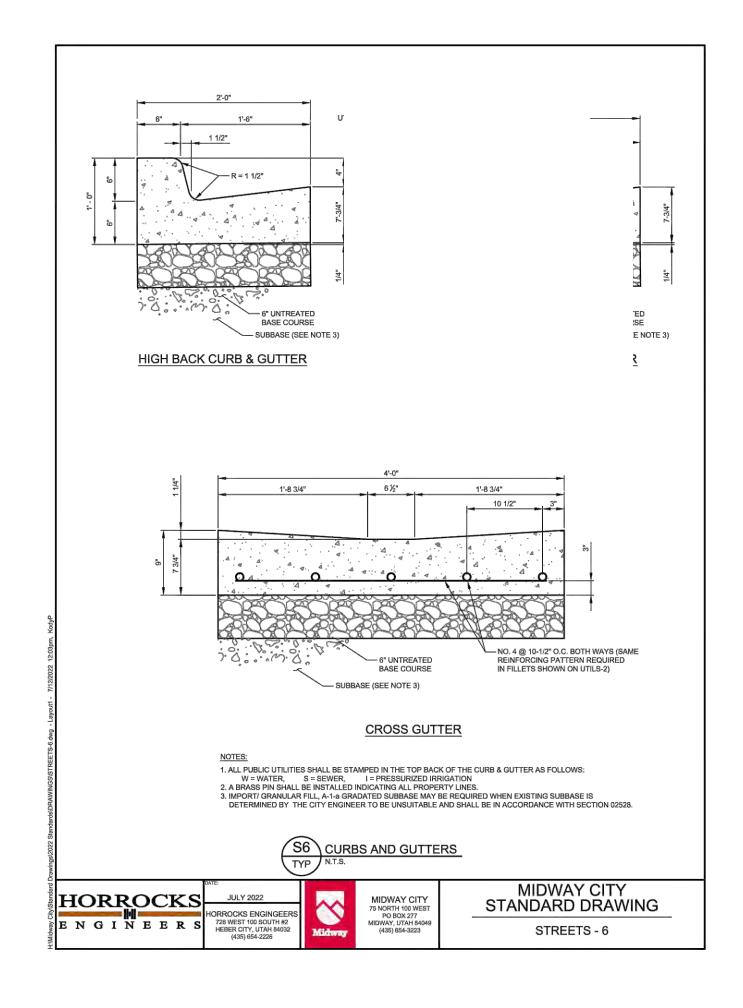


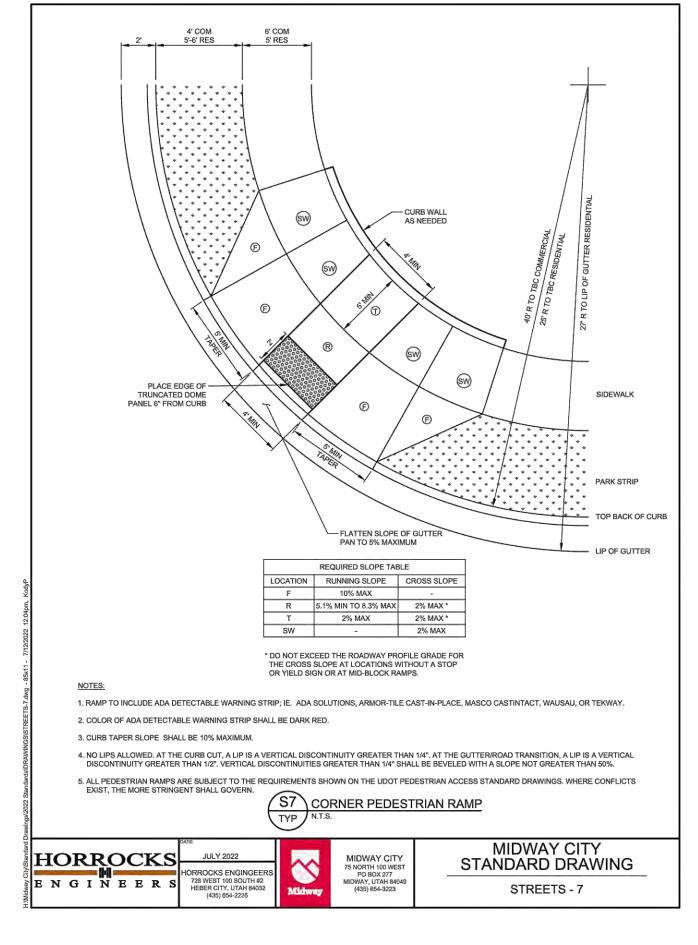

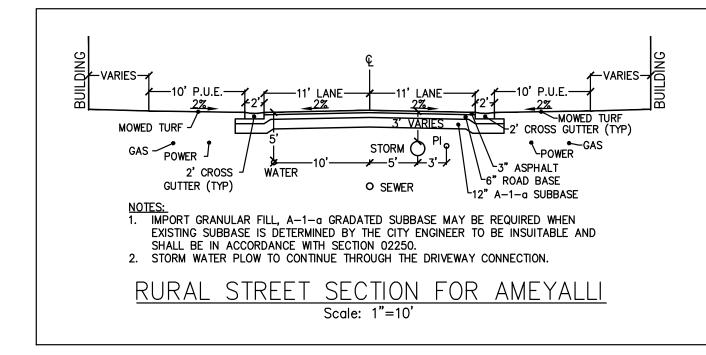

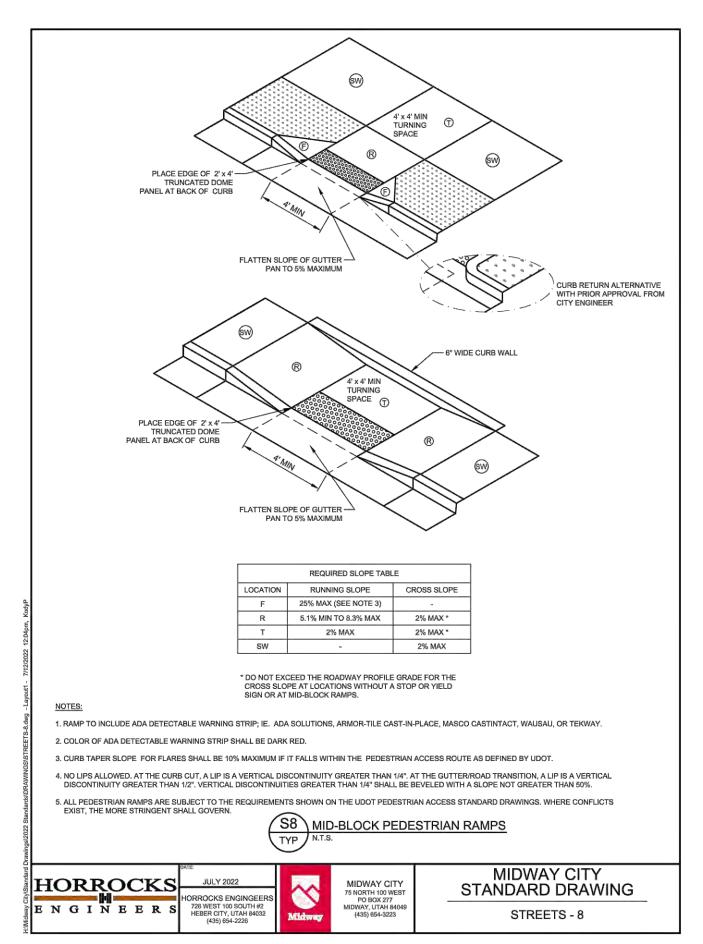


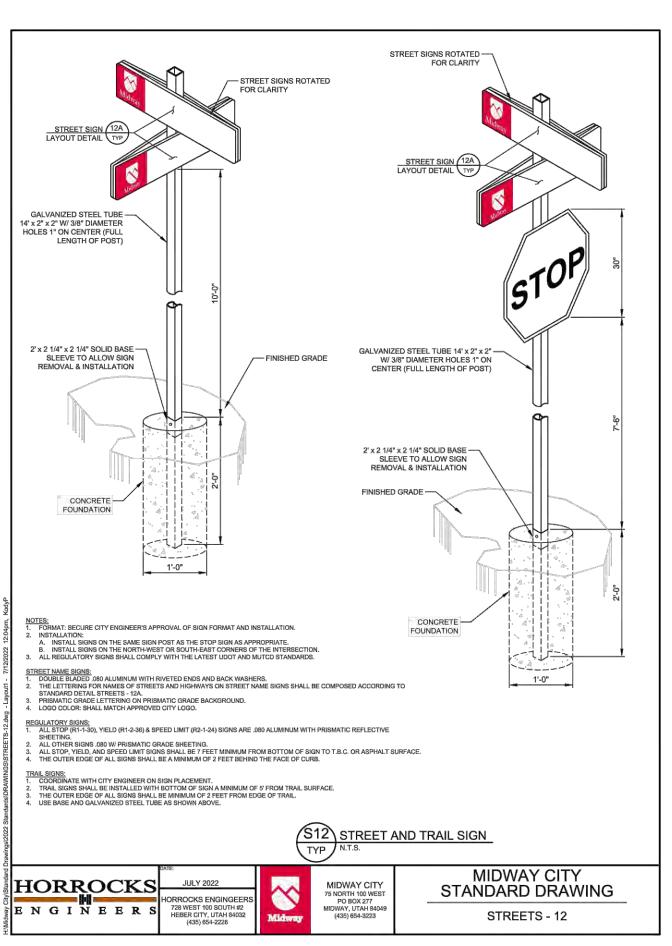

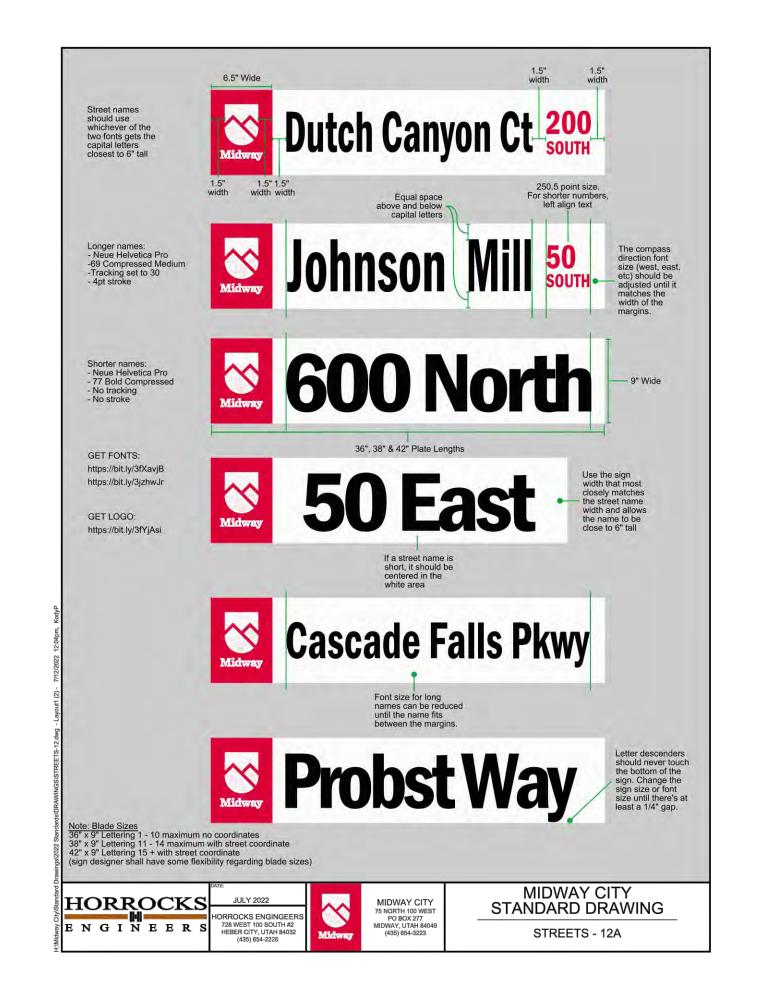




DATE: 14 NOV 2022 DESIGN BY: PDB DRAWN BY: PDB REV:

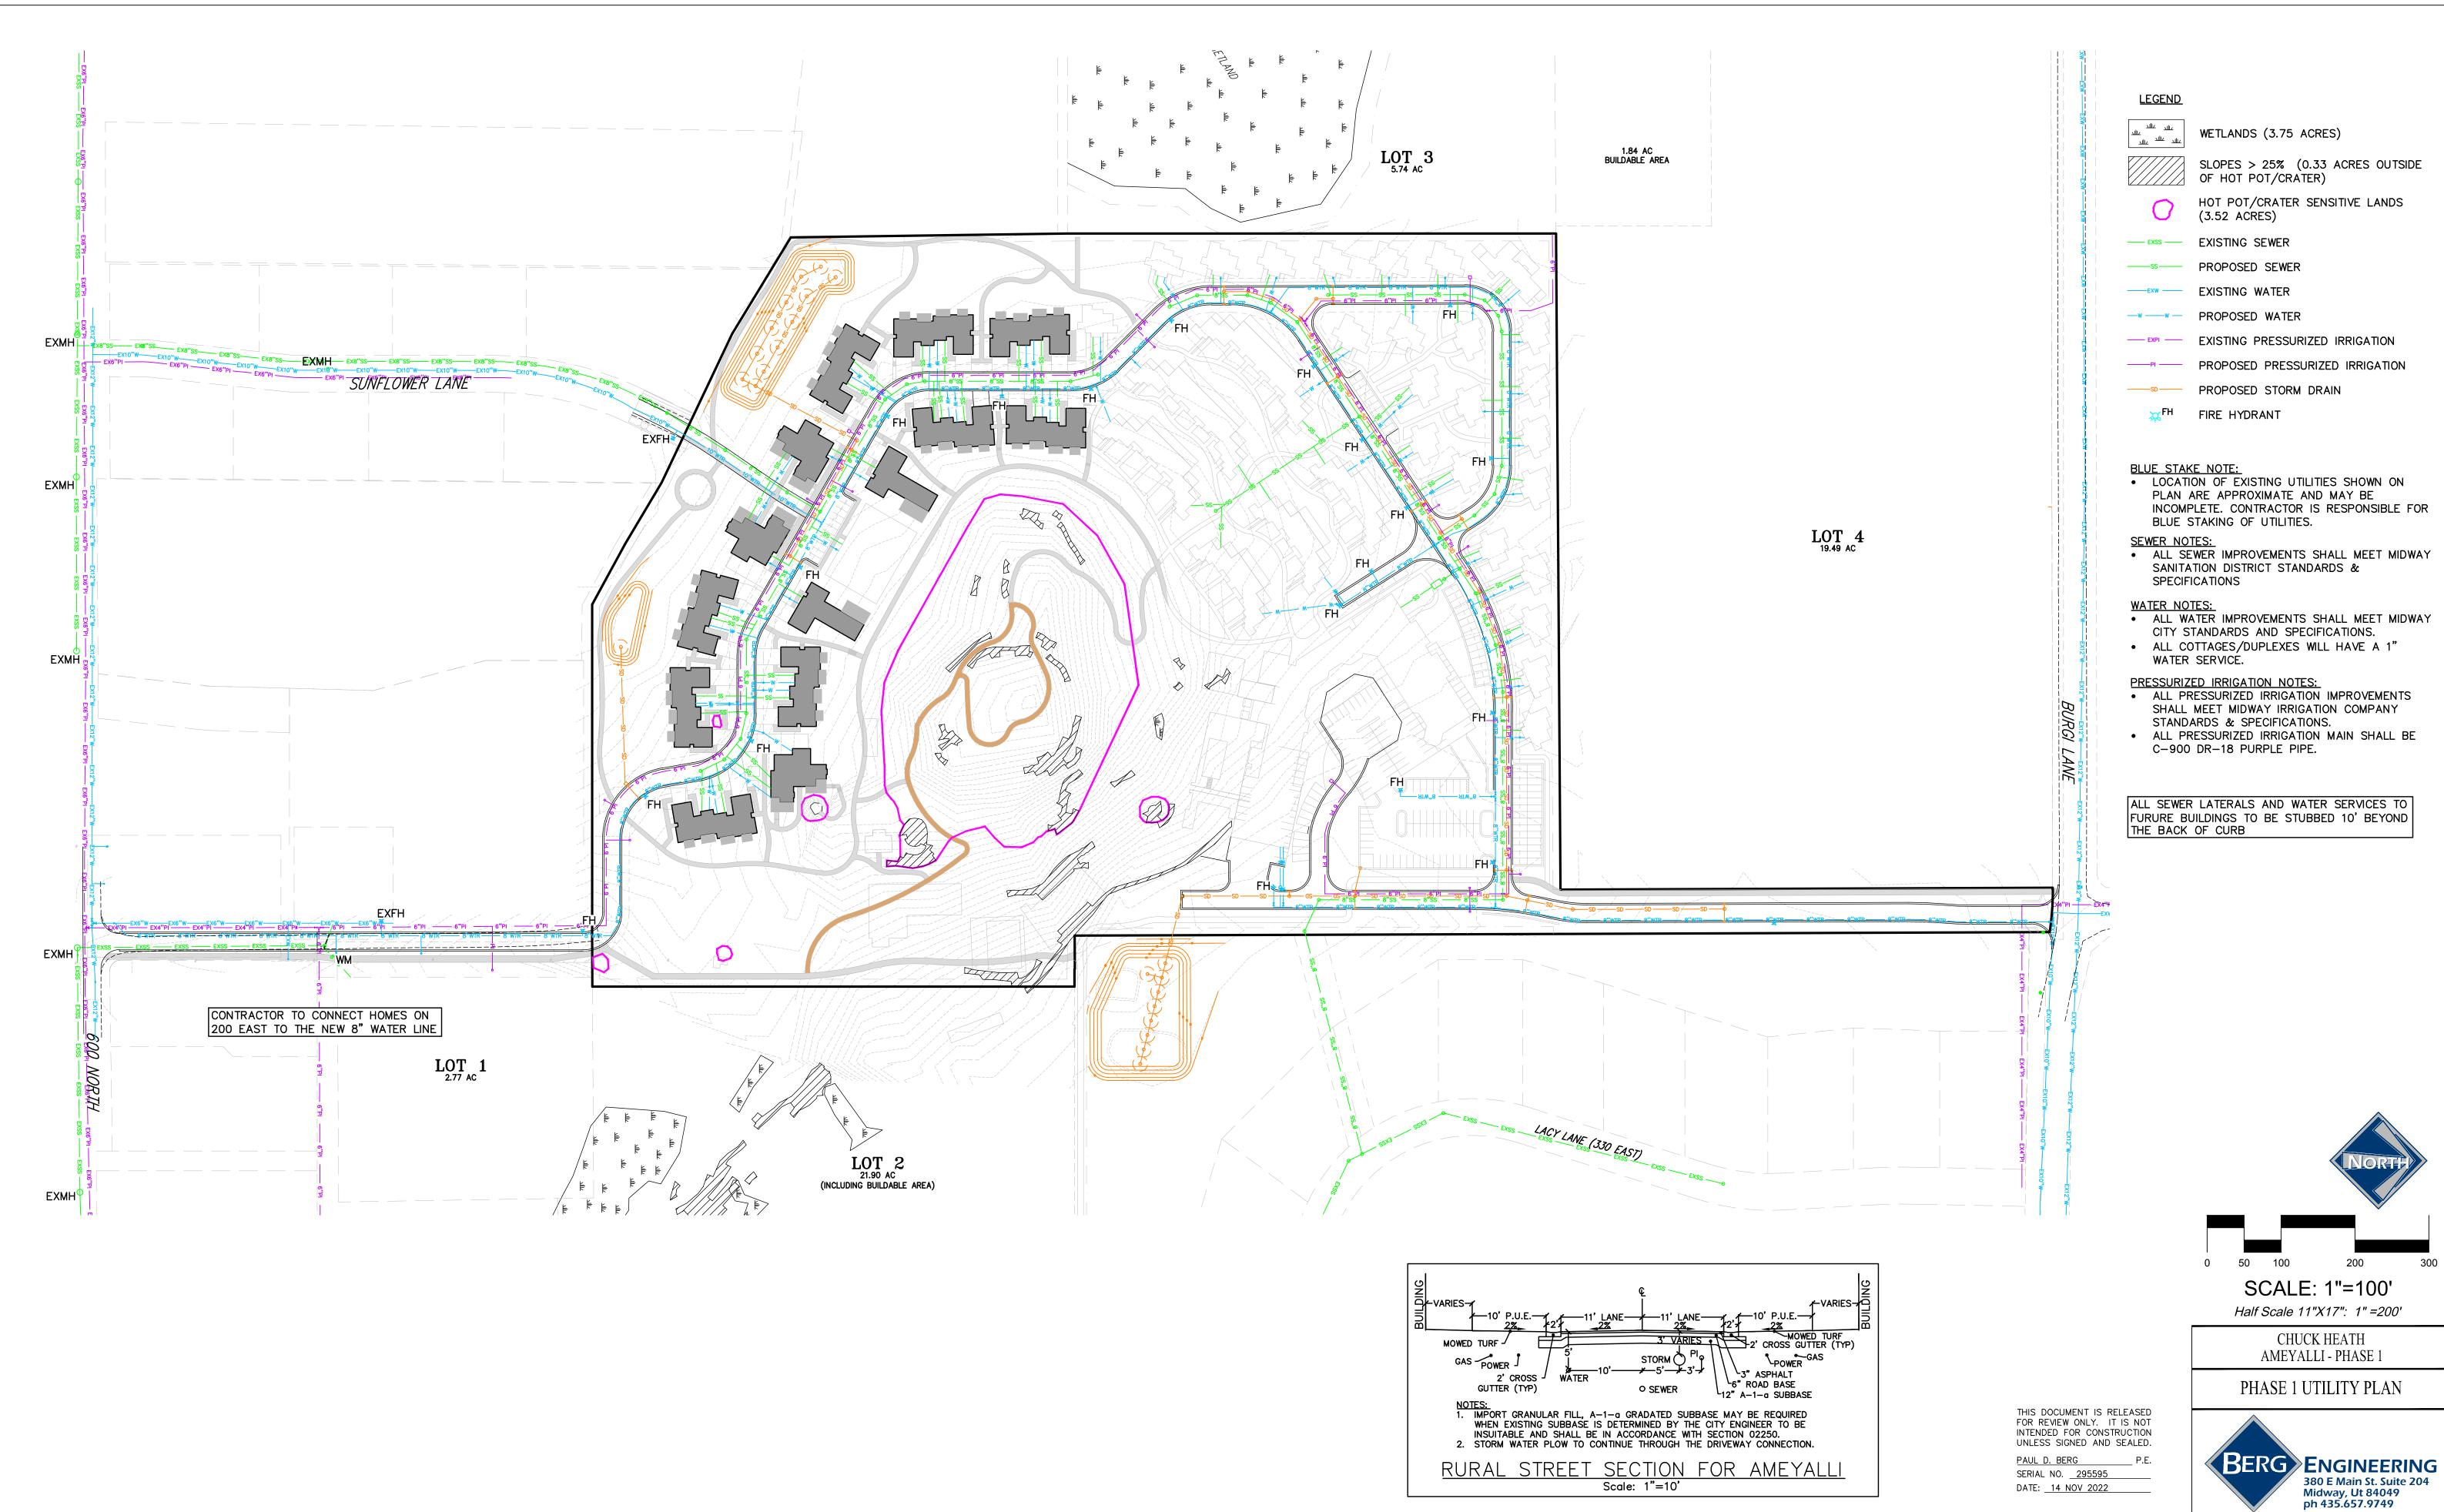



435.657.9749E: 14 NOV 2022 SHEET

DESIGN BY: PDB DATE: 14 NOV 2022
DRAWN BY: DEJ REV:

13

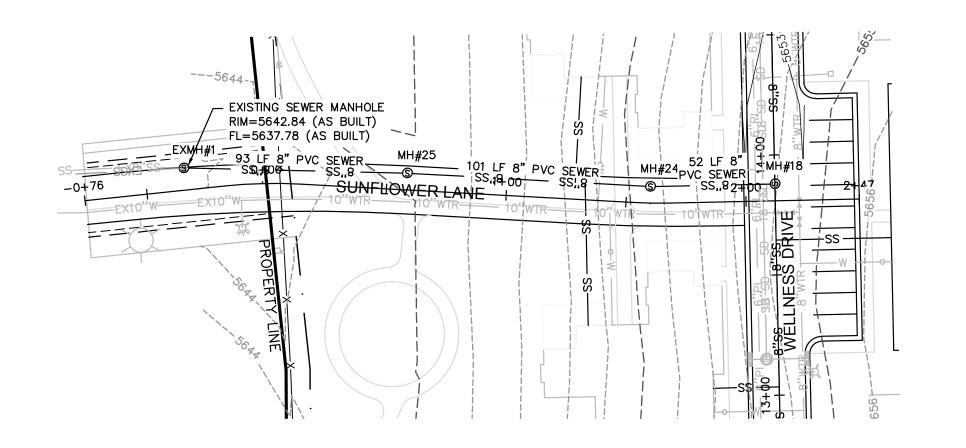

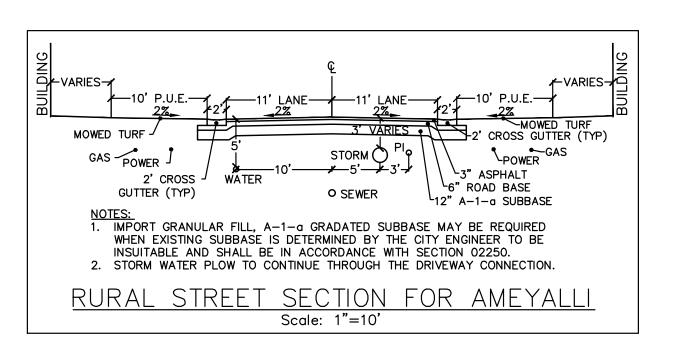

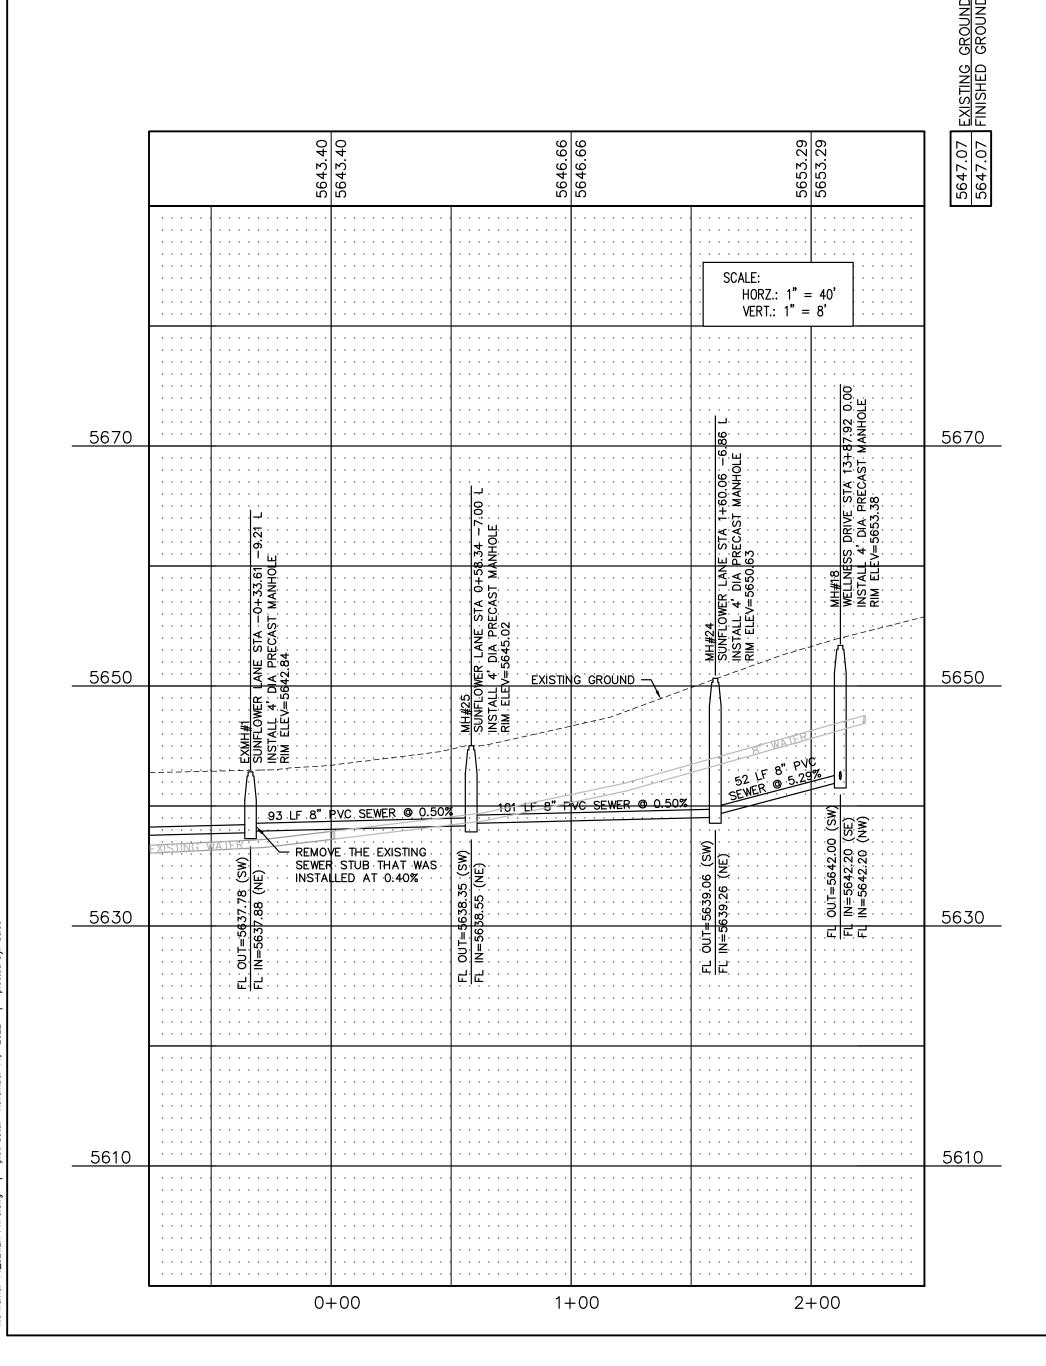

BLUE STAKE NOTE:

• LOCATION OF EXISTING UTILITIES SHOWN ON PLAN ARE APPROXIMATE AND MAY BE INCOMPLETE. CONTRACTOR IS RESPONSIBLE FOR BLUE STAKING OF UTILITIES. SEWER NOTES:

• ALL SEWER LATERALS ARE 4" EXCEPT WHERE

 ALL SEWER IMPROVEMENTS SHALL MEET MIDWAY SANITATION DISTRICT STANDARDS AND SPECIFICATIONS


<u>LEGEND</u>

—— EXSS —— EXISTING SEWER

----EX8"W---- EXISTING 8" WATER ----- 8"WTR----- PROPOSED 8" WATER

---- EXPI --- EXISTING PRESSURIZED IRRIGATION PROPOSED PRESSURIZED IRRIGATION

-----SD------ PROPOSED STORM DRAIN

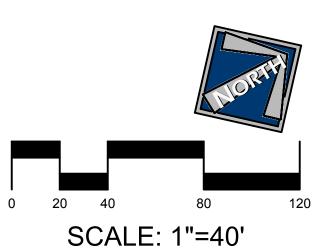

CHUCK HEATH

AMEYALLI - PHASE 1

SUNFLOWER LANE - SEWER PLAN & PROFILE STA -0+78 - 2+47



DESIGN BY: PDB DATE: 14 NOV 2022

REV:

DRAWN BY: DEJ


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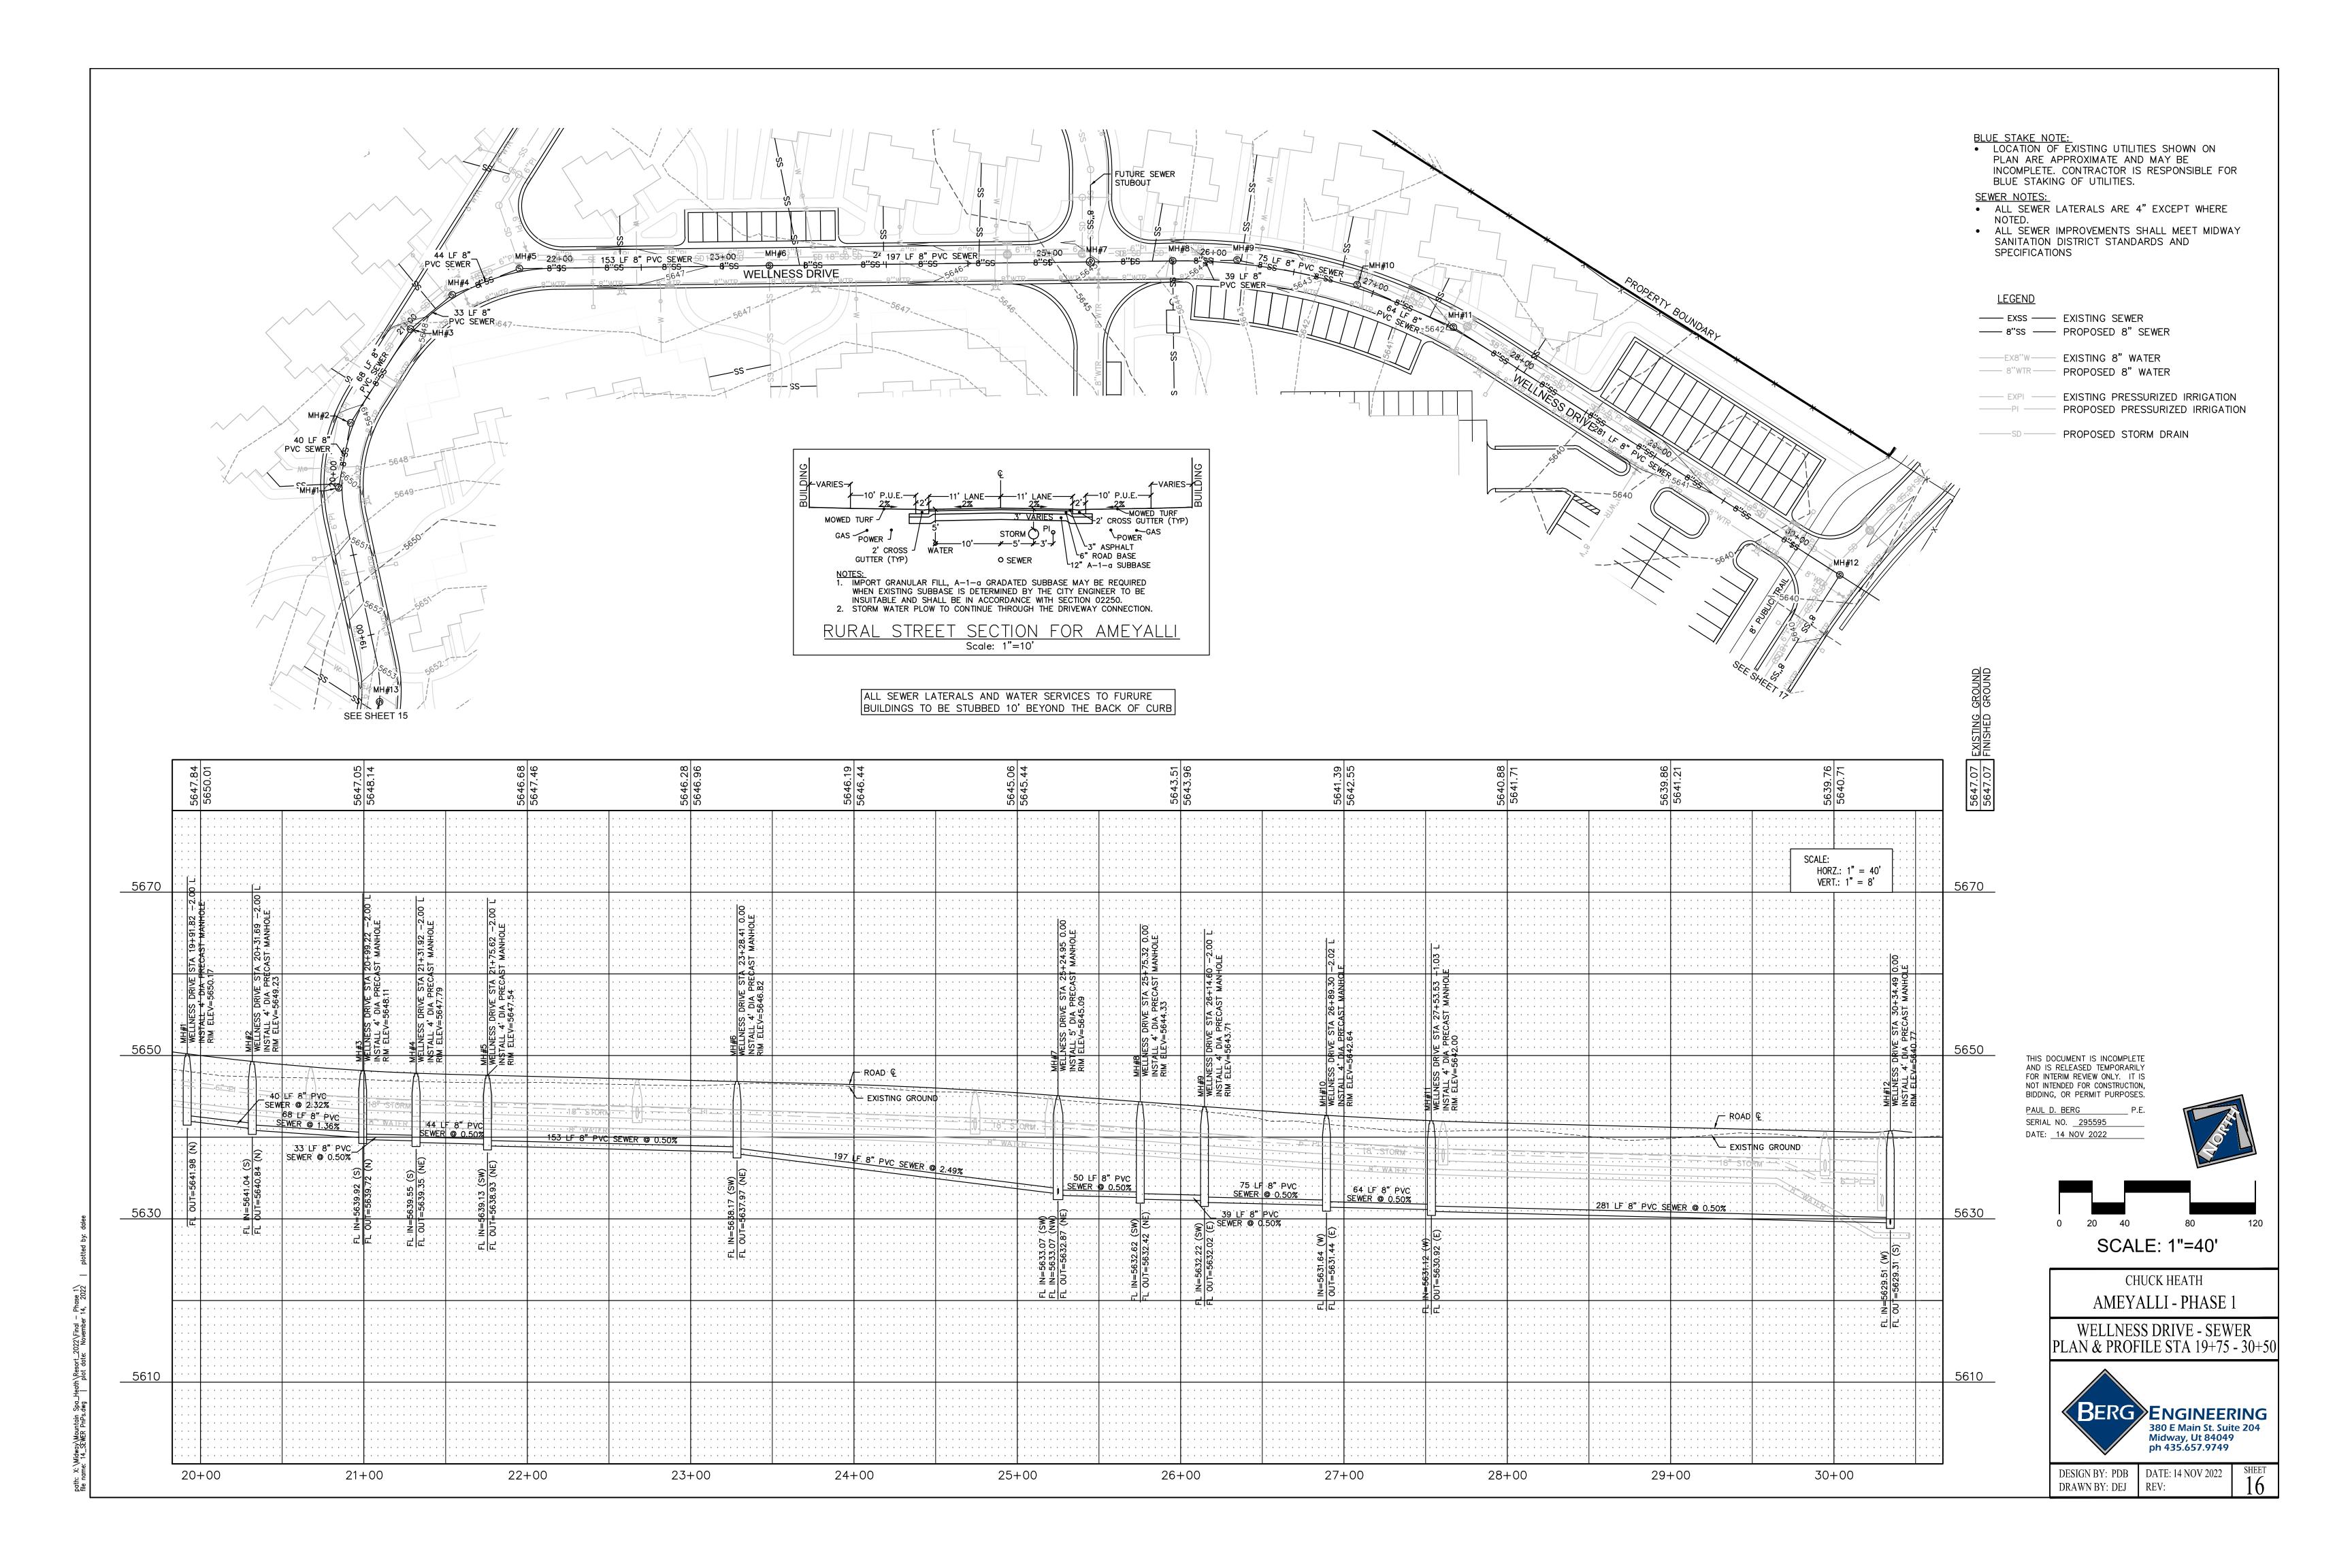
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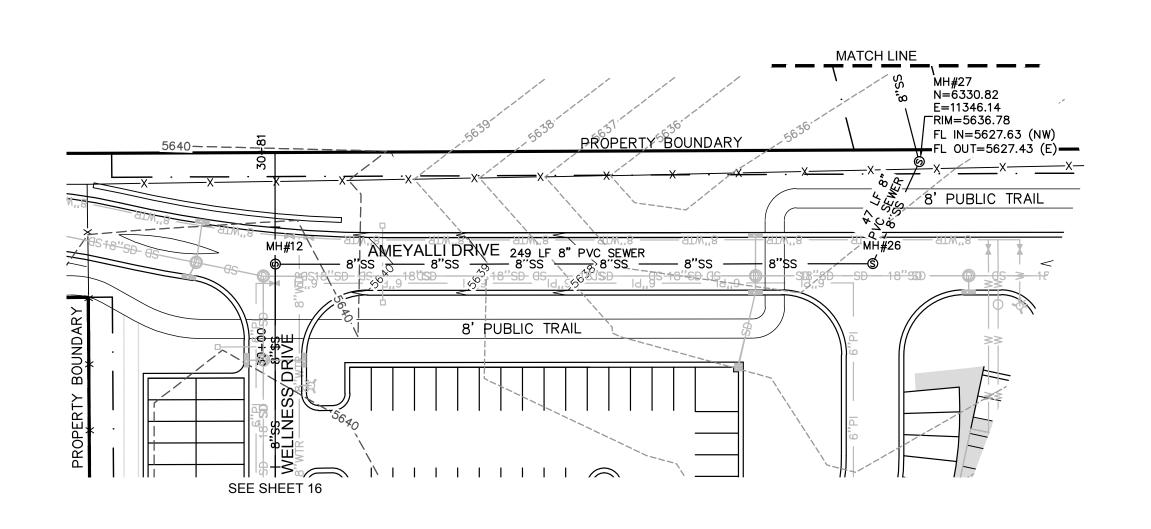
PAUL D. BERG P.E.


SERIAL NO. <u>295595</u>


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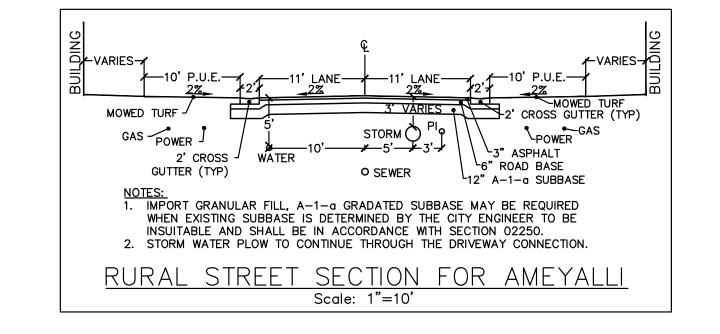






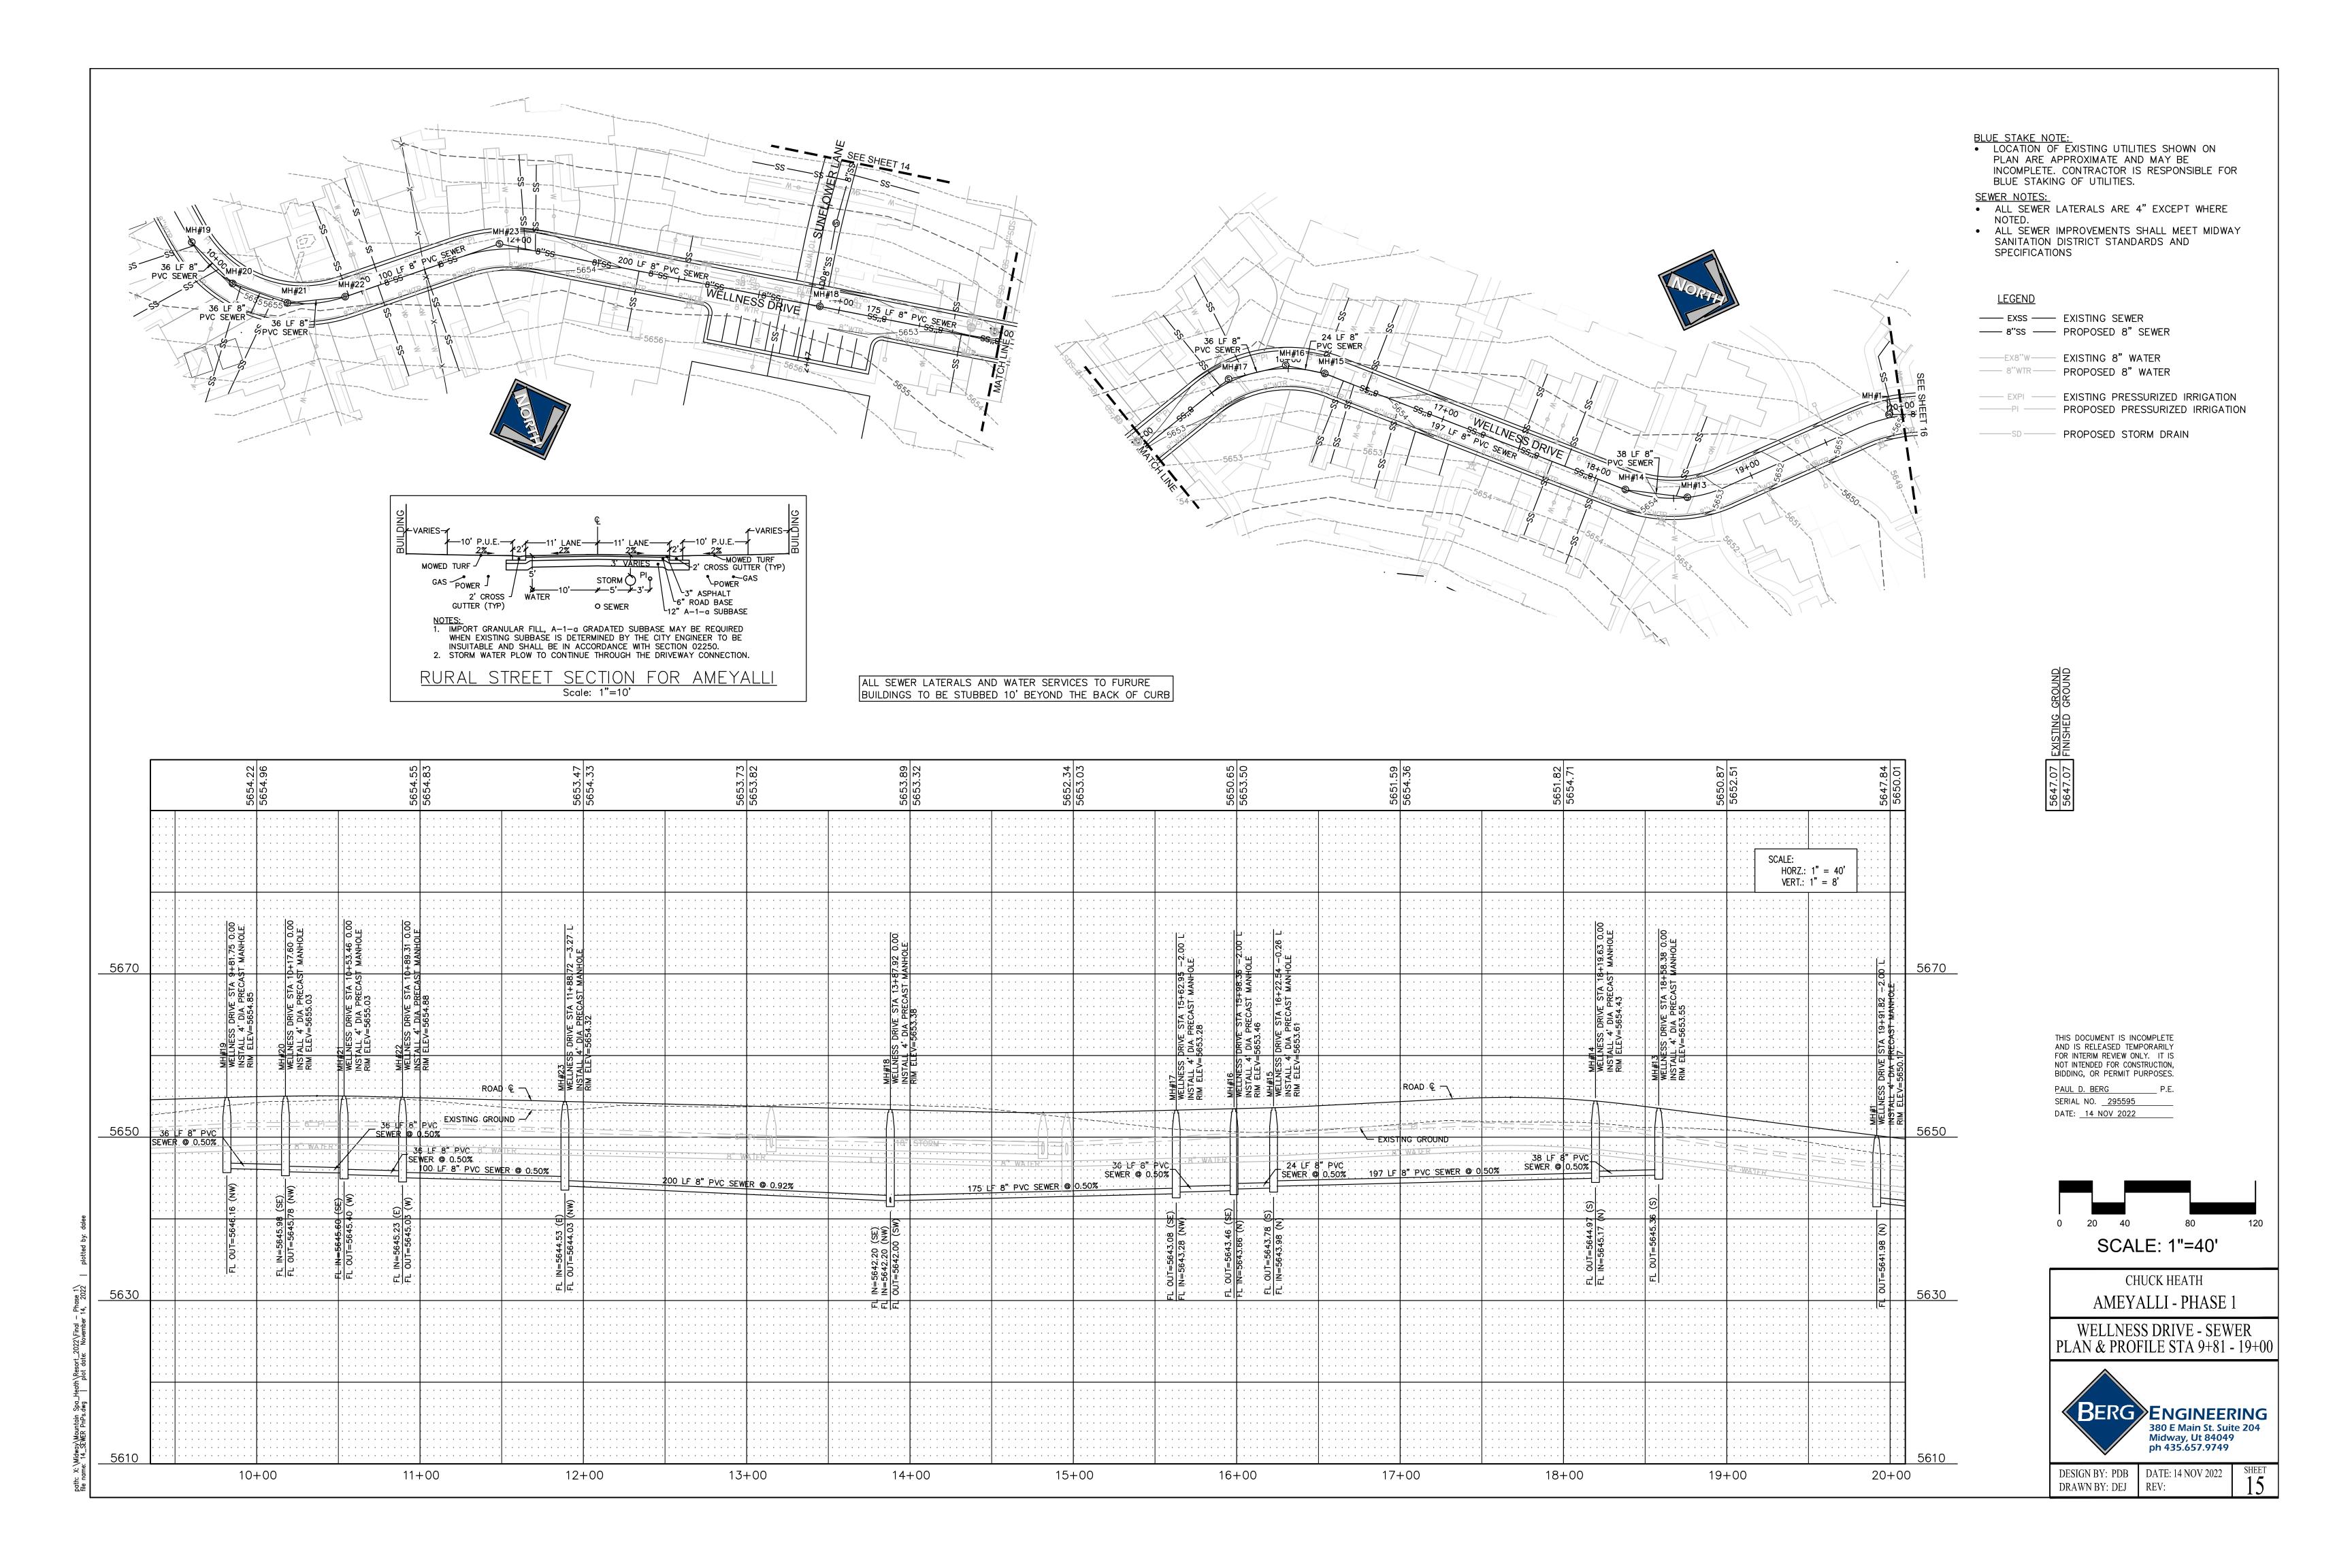

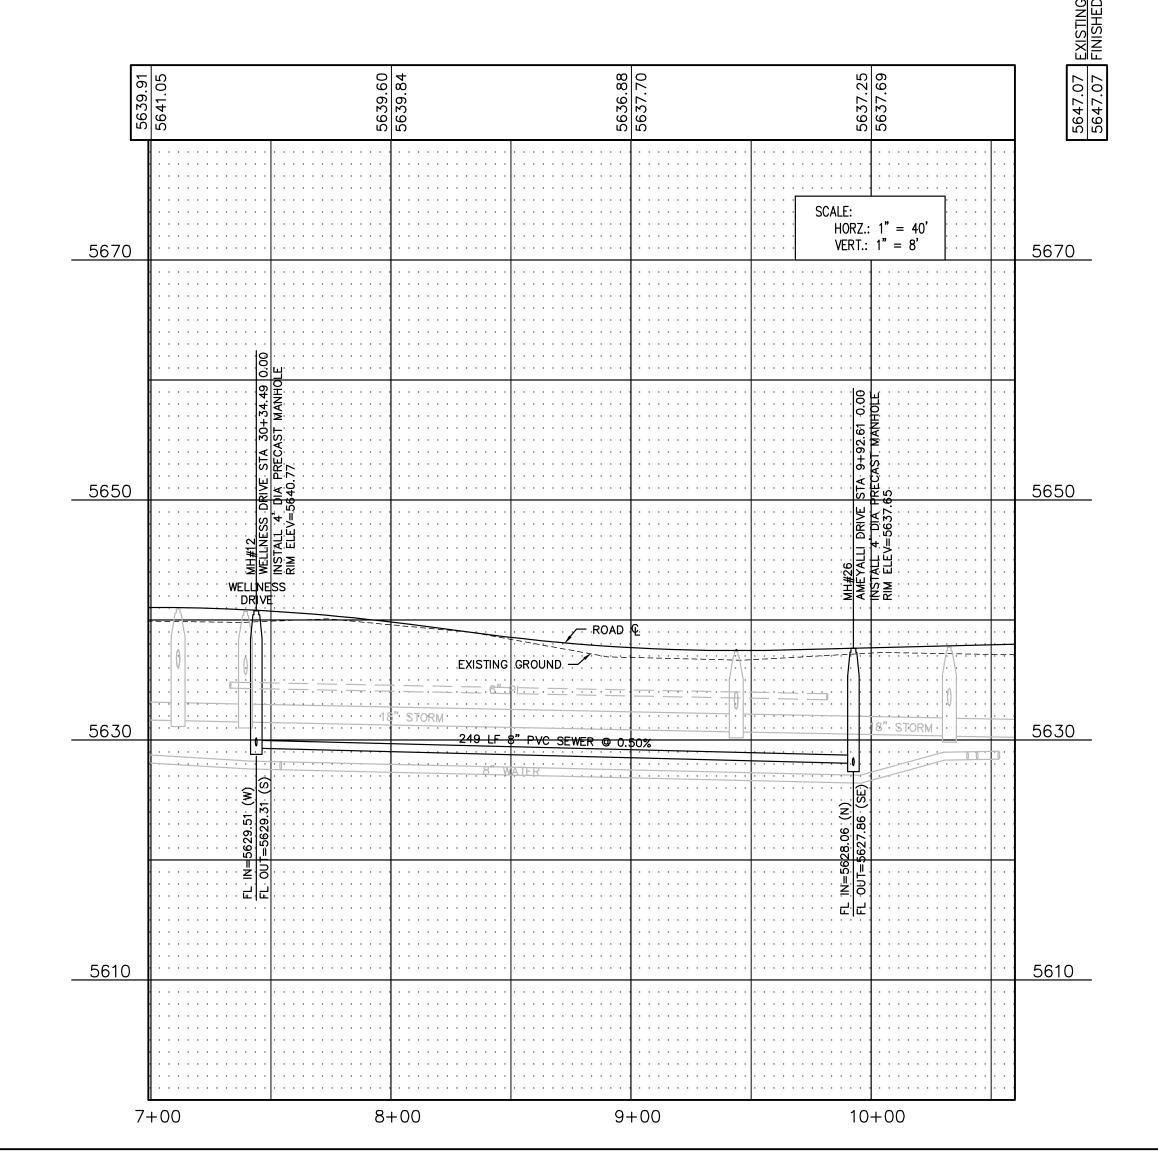

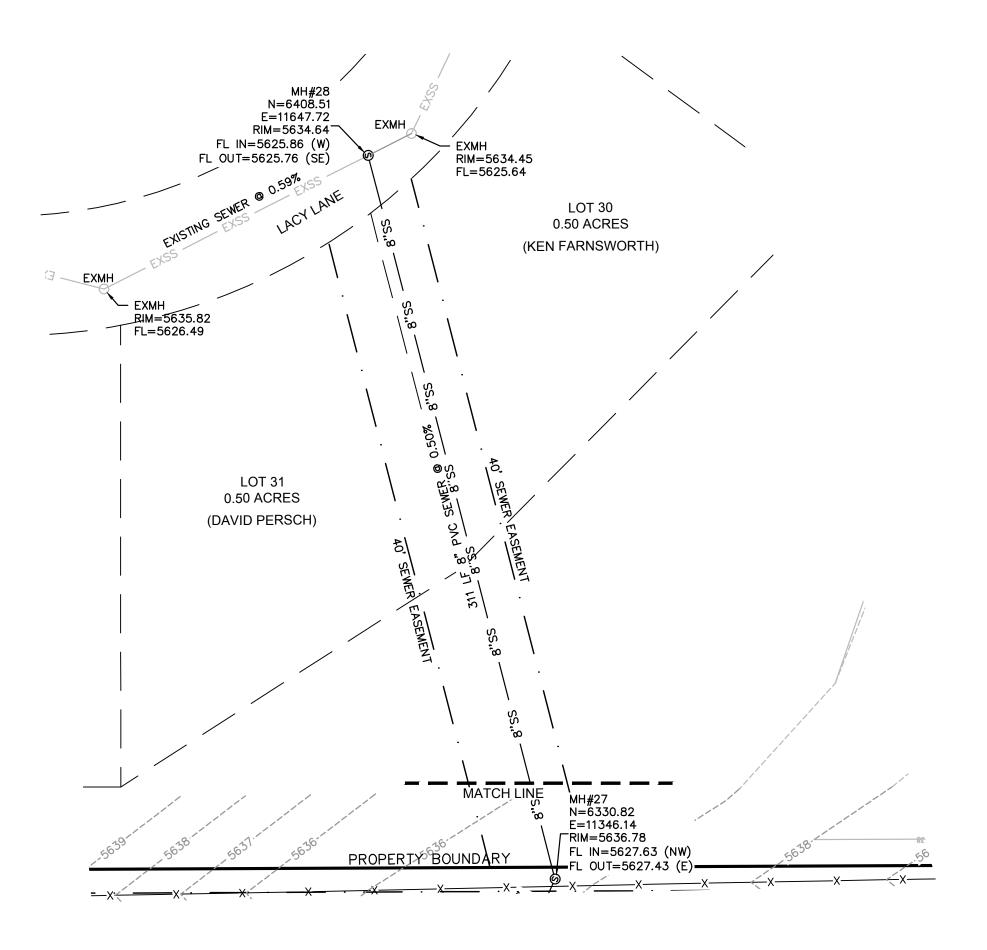

BLUE STAKE NOTE:

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SEWER NOTES:

• ALL SEWER LATERALS ARE 4" EXCEPT WHERE

 ALL SEWER IMPROVEMENTS SHALL MEET MIDWAY SANITATION DISTRICT STANDARDS AND SPECIFICATIONS

<u>LEGEND</u>

—— EXSS —— EXISTING SEWER

----EX8"W---- EXISTING 8" WATER ----- 8"WTR----- PROPOSED 8" WATER

---- EXPI --- EXISTING PRESSURIZED IRRIGATION PI PROPOSED PRESSURIZED IRRIGATION

PROPOSED STORM DRAIN

SCALE: 1"=40'

CHUCK HEATH AMEYALLI - PHASE

AMEYALLI DRIVE/OFFSITE - SEWER PLAN & PROFILE STA 7+00 - 10+00

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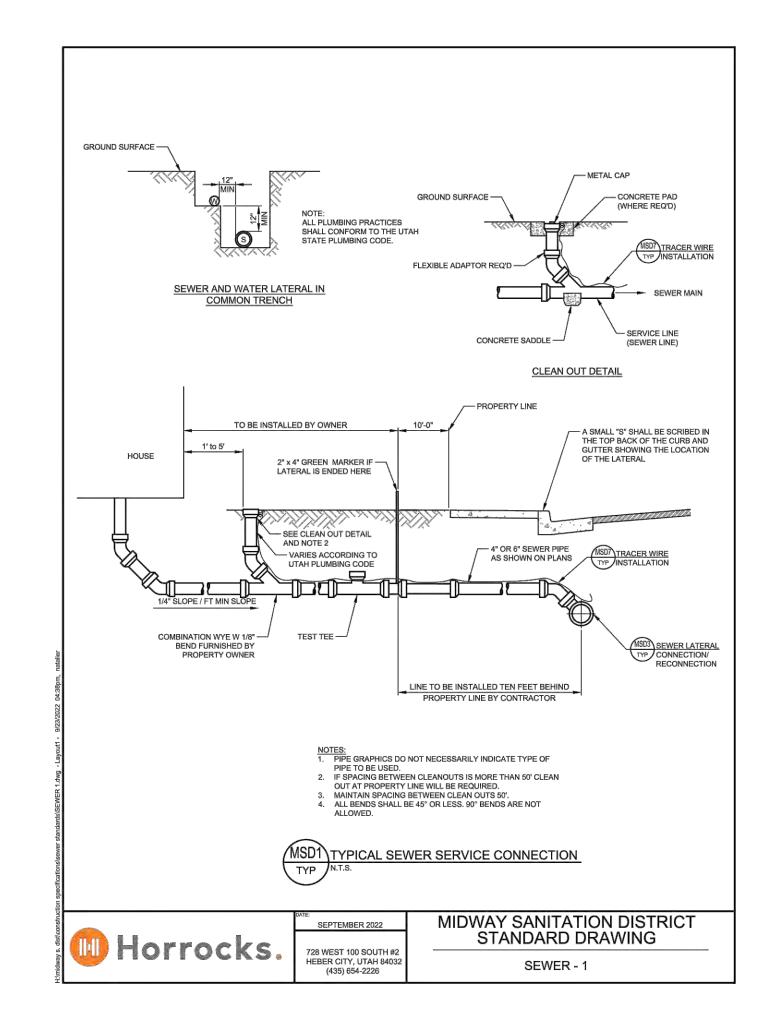
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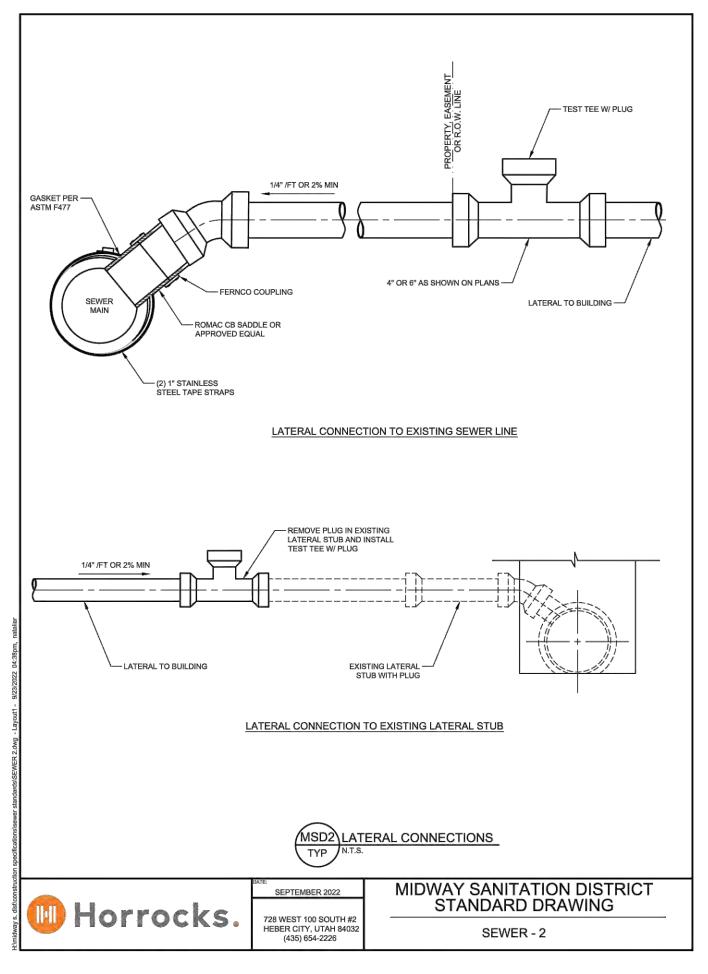
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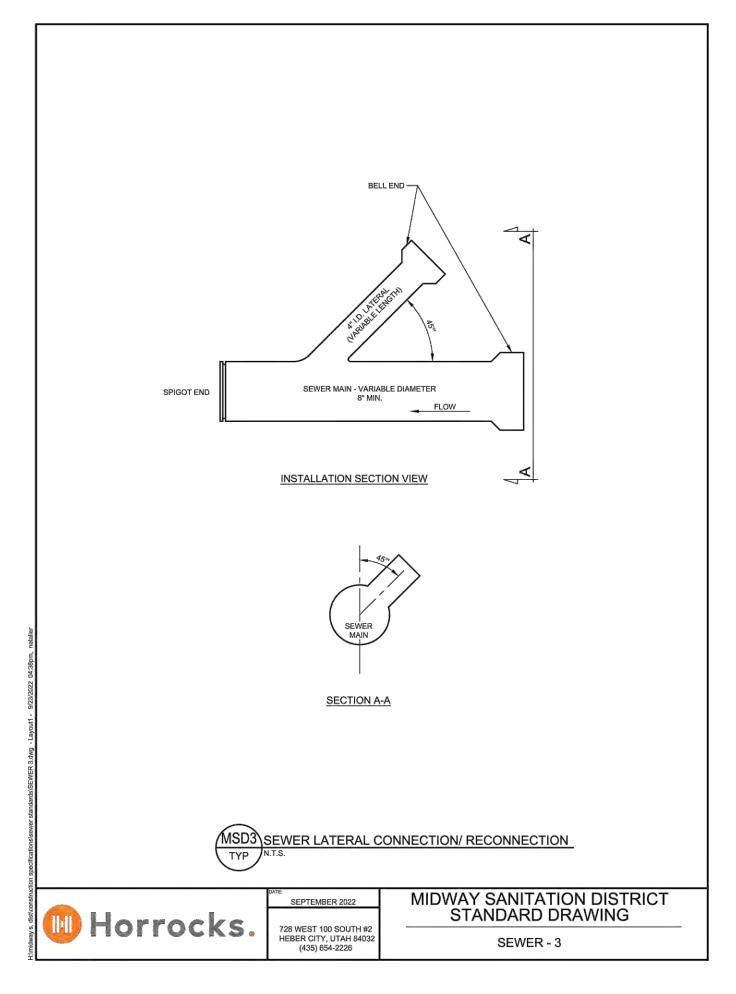
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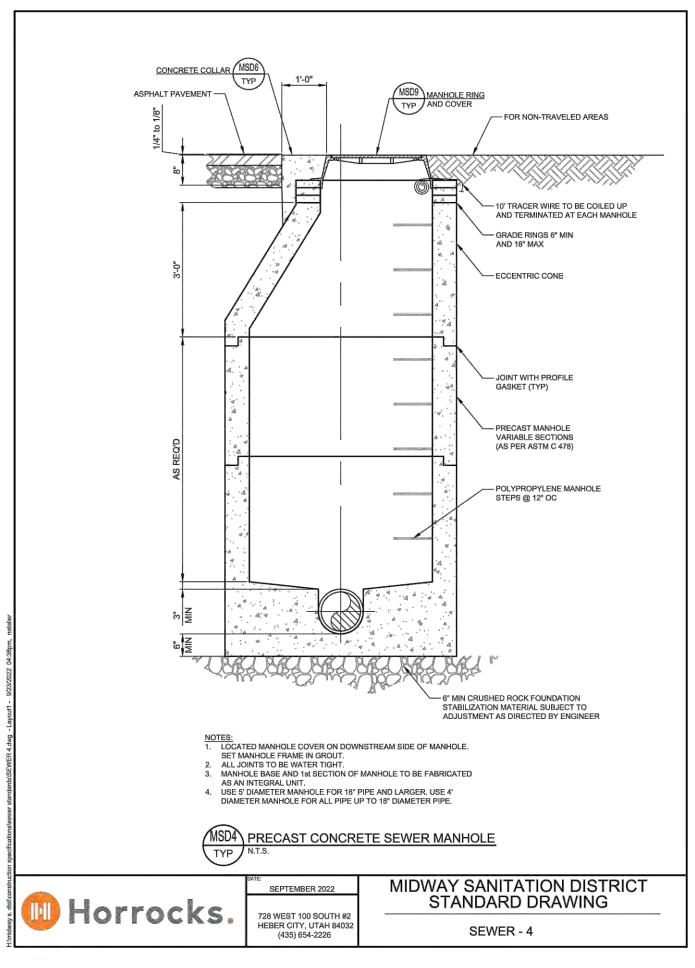



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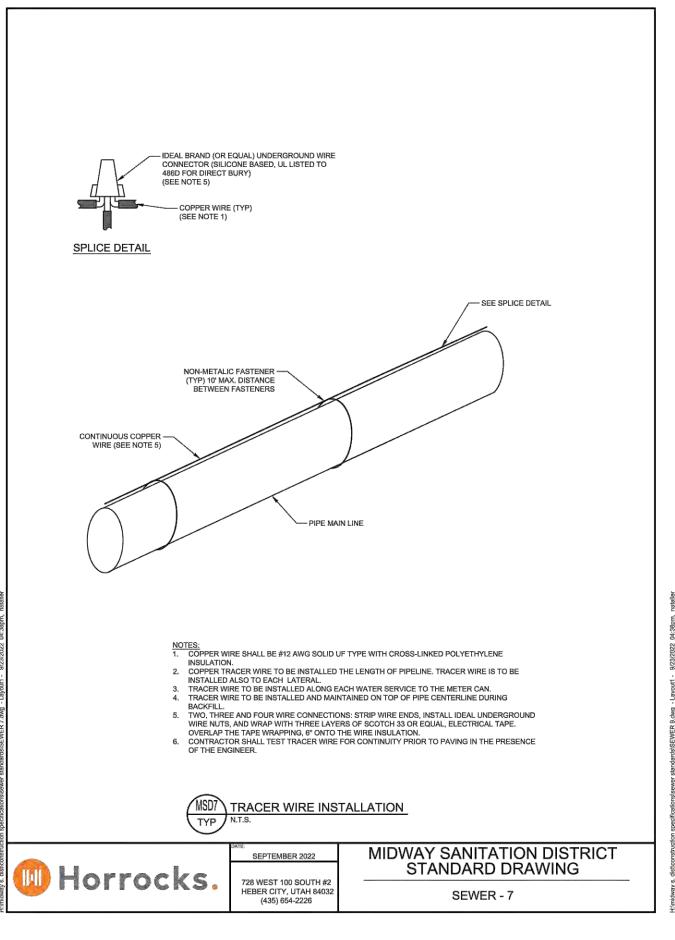













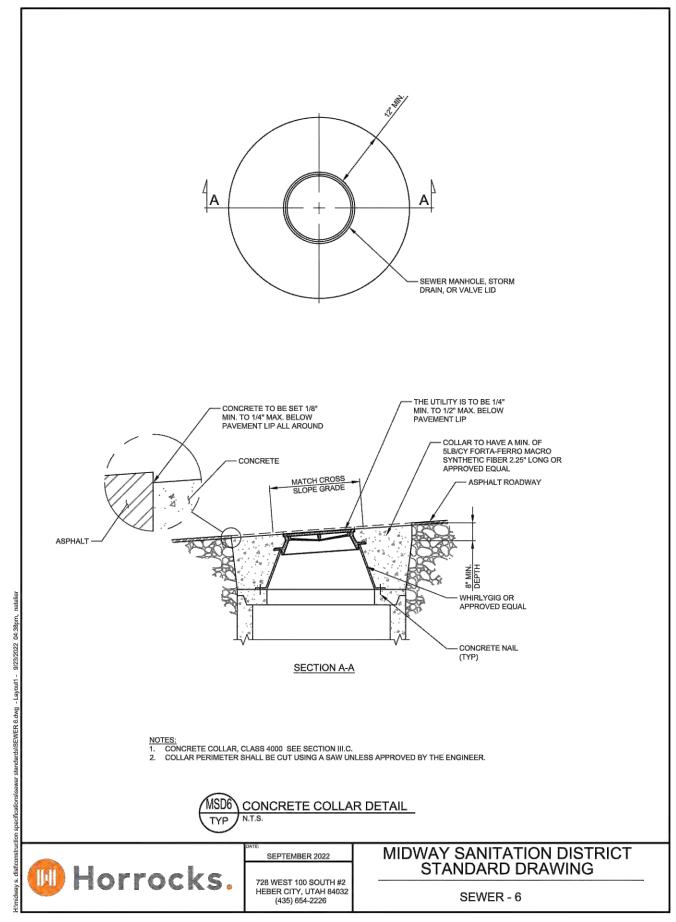

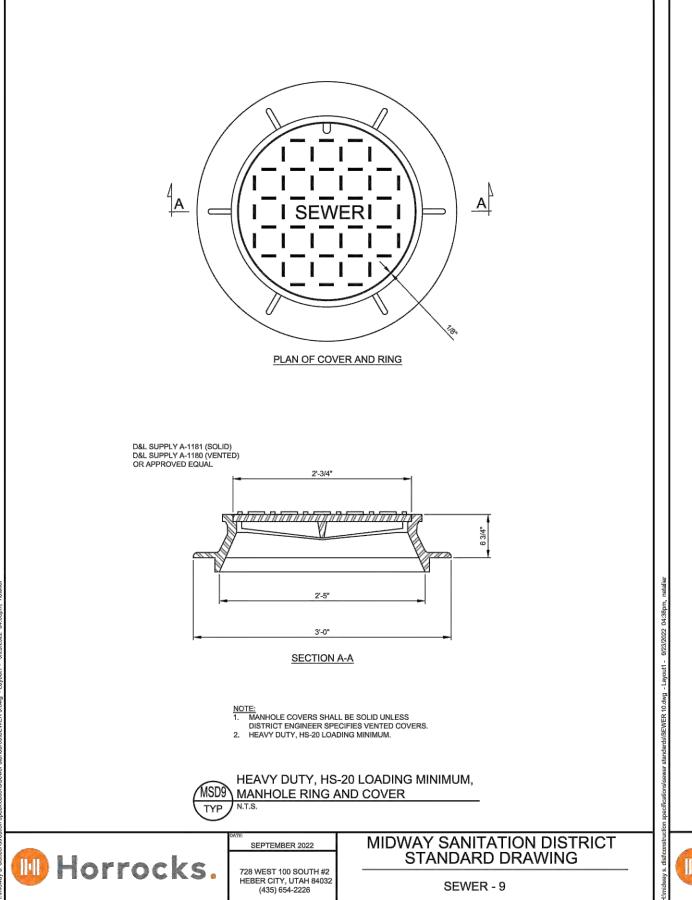

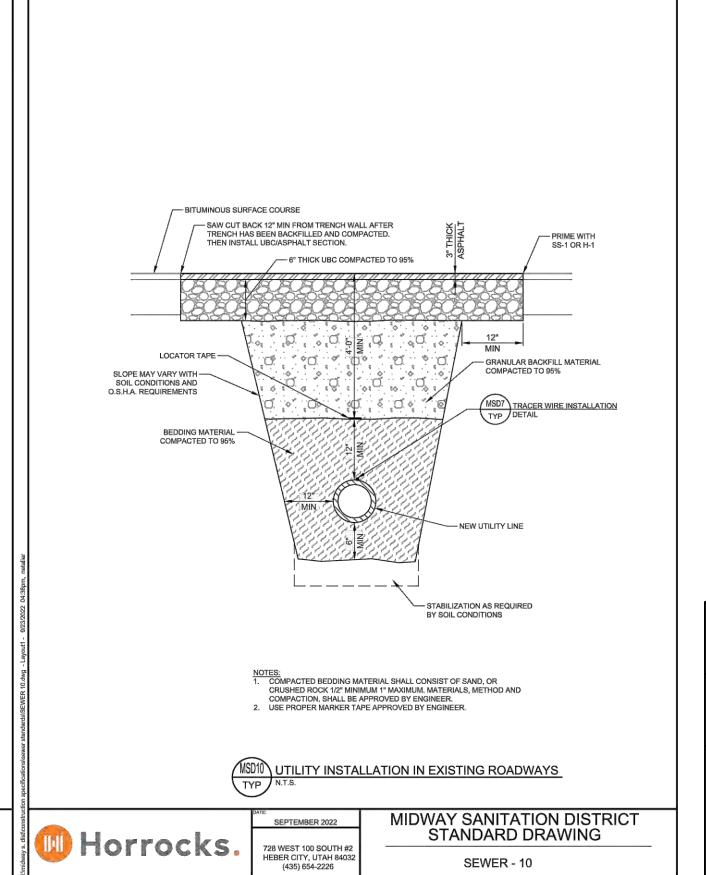



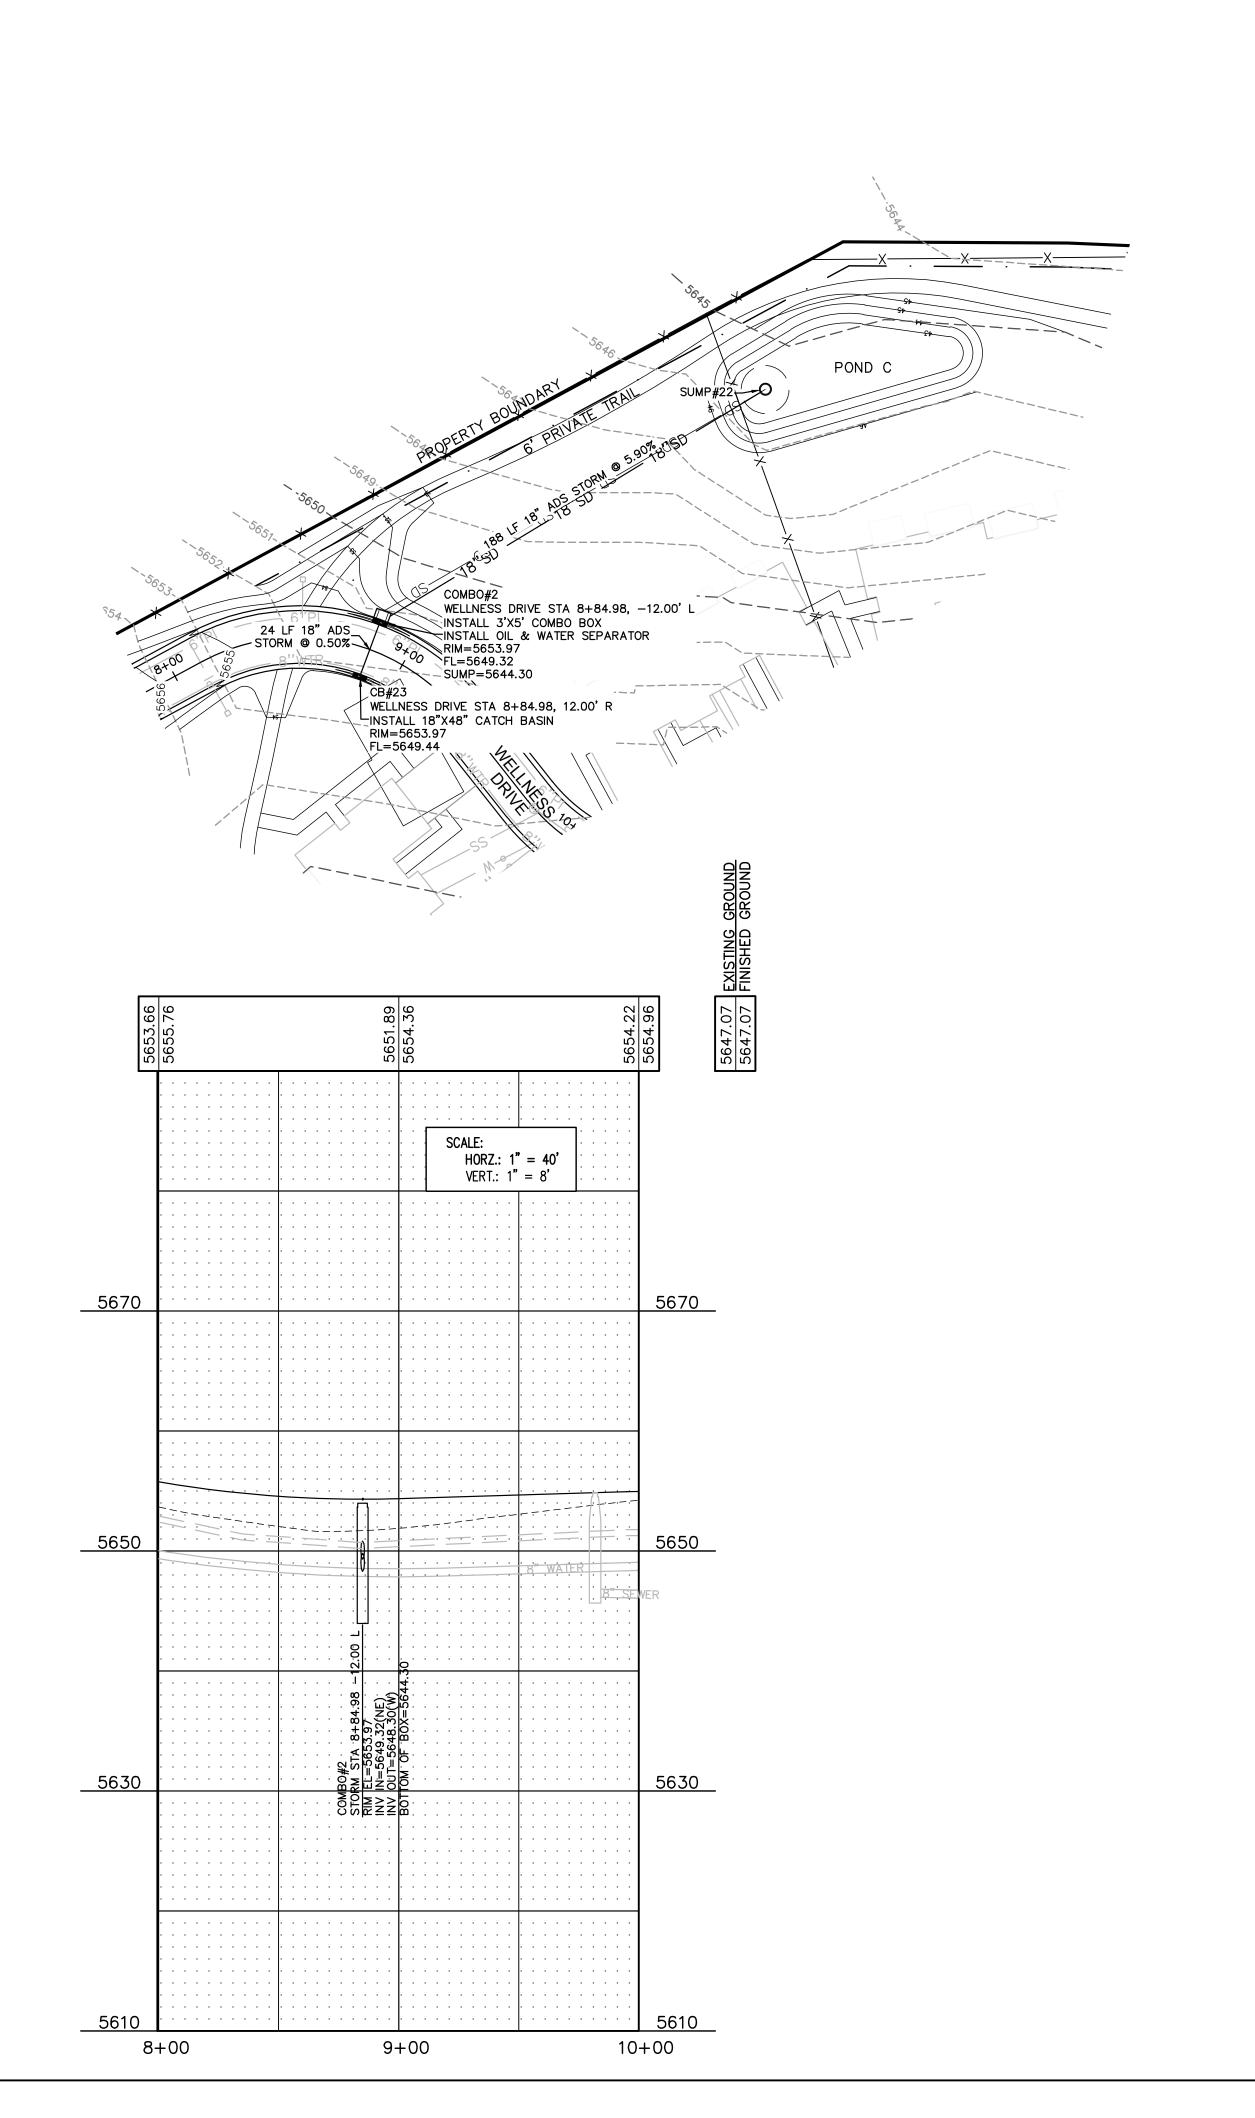

		POND	С		
SUMP	NORTHING	EASTING	RIM	FLOWLINE	BOTTOM OF SUMP
SUMP#16	N=5570.11	E=10599.60	5641.00	5636.40	5633.00

Table 8 - 100 Year Storm Peak Runoff and Volume for Basin C

Table 6 - 100 f	ear Storm r	eak Kunon a	na volume ioi	Dasin C	
			Developed	Peak	Total
Time	Rainfall		Runoff	Runoff	Runoff
Period	Intensity	Area	Coefficient	Rate	Volume
(min)	(in / hr)	(acres)		(cfs)	(cf)
15	4.08	1.28	0.40	2.10	1,891
30	2.76	1.28	0.40	1.42	2,559
60	1.71	1.28	0.40	0.88	3,170
120	0.96	1.28	0.40	0.49	3,560
180	0.65	1.28	0.40	0.33	3,615
360	0.35	1.28	0.40	0.18	3,893
720	0.21	1.28	0.40	0.11	4,672
1440	0.13	1.28	0.40	0.07	5,784

	Total	Soil	1 - 8'	Percolation	Storage
Time	Runoff	Percolation	Sump	from	Needed
Period	Volume	Rate	Volume	Sump	in Pond
(min)	(cf)	(inch / hour)	(cf)	(cf)	(cf)
15	1,891	2.0	855	22	1,014
30	2,559	2.0	855	43	1,660
60	3,170	2.0	855	86	2,229
120	3,560	2.0	855	173	2,532
180	3,615	2.0	855	259	2,501
360	3,893	2.0	855	518	2,520
720	4,672	2.0	855	1,037	2,780
1440	5,784	2.0	855	2.074	2.856

Bevation	Pond Depth	Pond Area	Pond Volume	Pond Volume	
	(ft)	(sf)	(cf)	(acre-ft)	
5642	0.00	12	0	0.00	
5643	1.00	2,382	1,197	0.03	
5644	2.00	3,319	4,048	0.09	contains the 100
5645	3.00	4,357	7,886	0.18	1' of freeboard

contains the 100 year storm

BLUE STAKE NOTE:

 LOCATION OF EXISTING UTILITIES SHOWN ON PLAN ARE APPROXIMATE AND MAY BE INCOMPLETE. CONTRACTOR IS RESPONSIBLE FOR BLUE STAKING OF UTILITIES.

STORM DRAIN SYSTEM NOTE: ALL STORM DRAIN CONSTRUCTION TO MEET MIDWAY CITY STANDARDS.


<u>LEGEND</u>

--- EXSS --- EXISTING SEWER — 8"SS — PROPOSED 8" SEWER

——EX8''W—— EXISTING 8" WATER - 8"WTR - PROPOSED 8" WATER

— EXPI — EXISTING PRESSURIZED IRRIGATION PI PROPOSED PRESSURIZED IRRIGATION

— 18"SD — PROPOSED STORM DRAIN

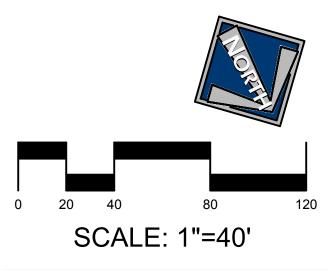

CHUCK HEATH AMEYALLI - PHASE 1

WELLNESS DRIVE - STORM PLAN & PROFILE STA 8+00 - 10+00

BERG ENGINEERING 380 E Main St. Suite 204 Midway, Ut 84049 ph 435.657.9749


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THIS DOCUMENT IS INCOMPLETE

AND IS RELEASED TEMPORARILY

DRAWN BY: DEJ REV:

DESIGN BY: PDB DATE: 14 NOV 2022

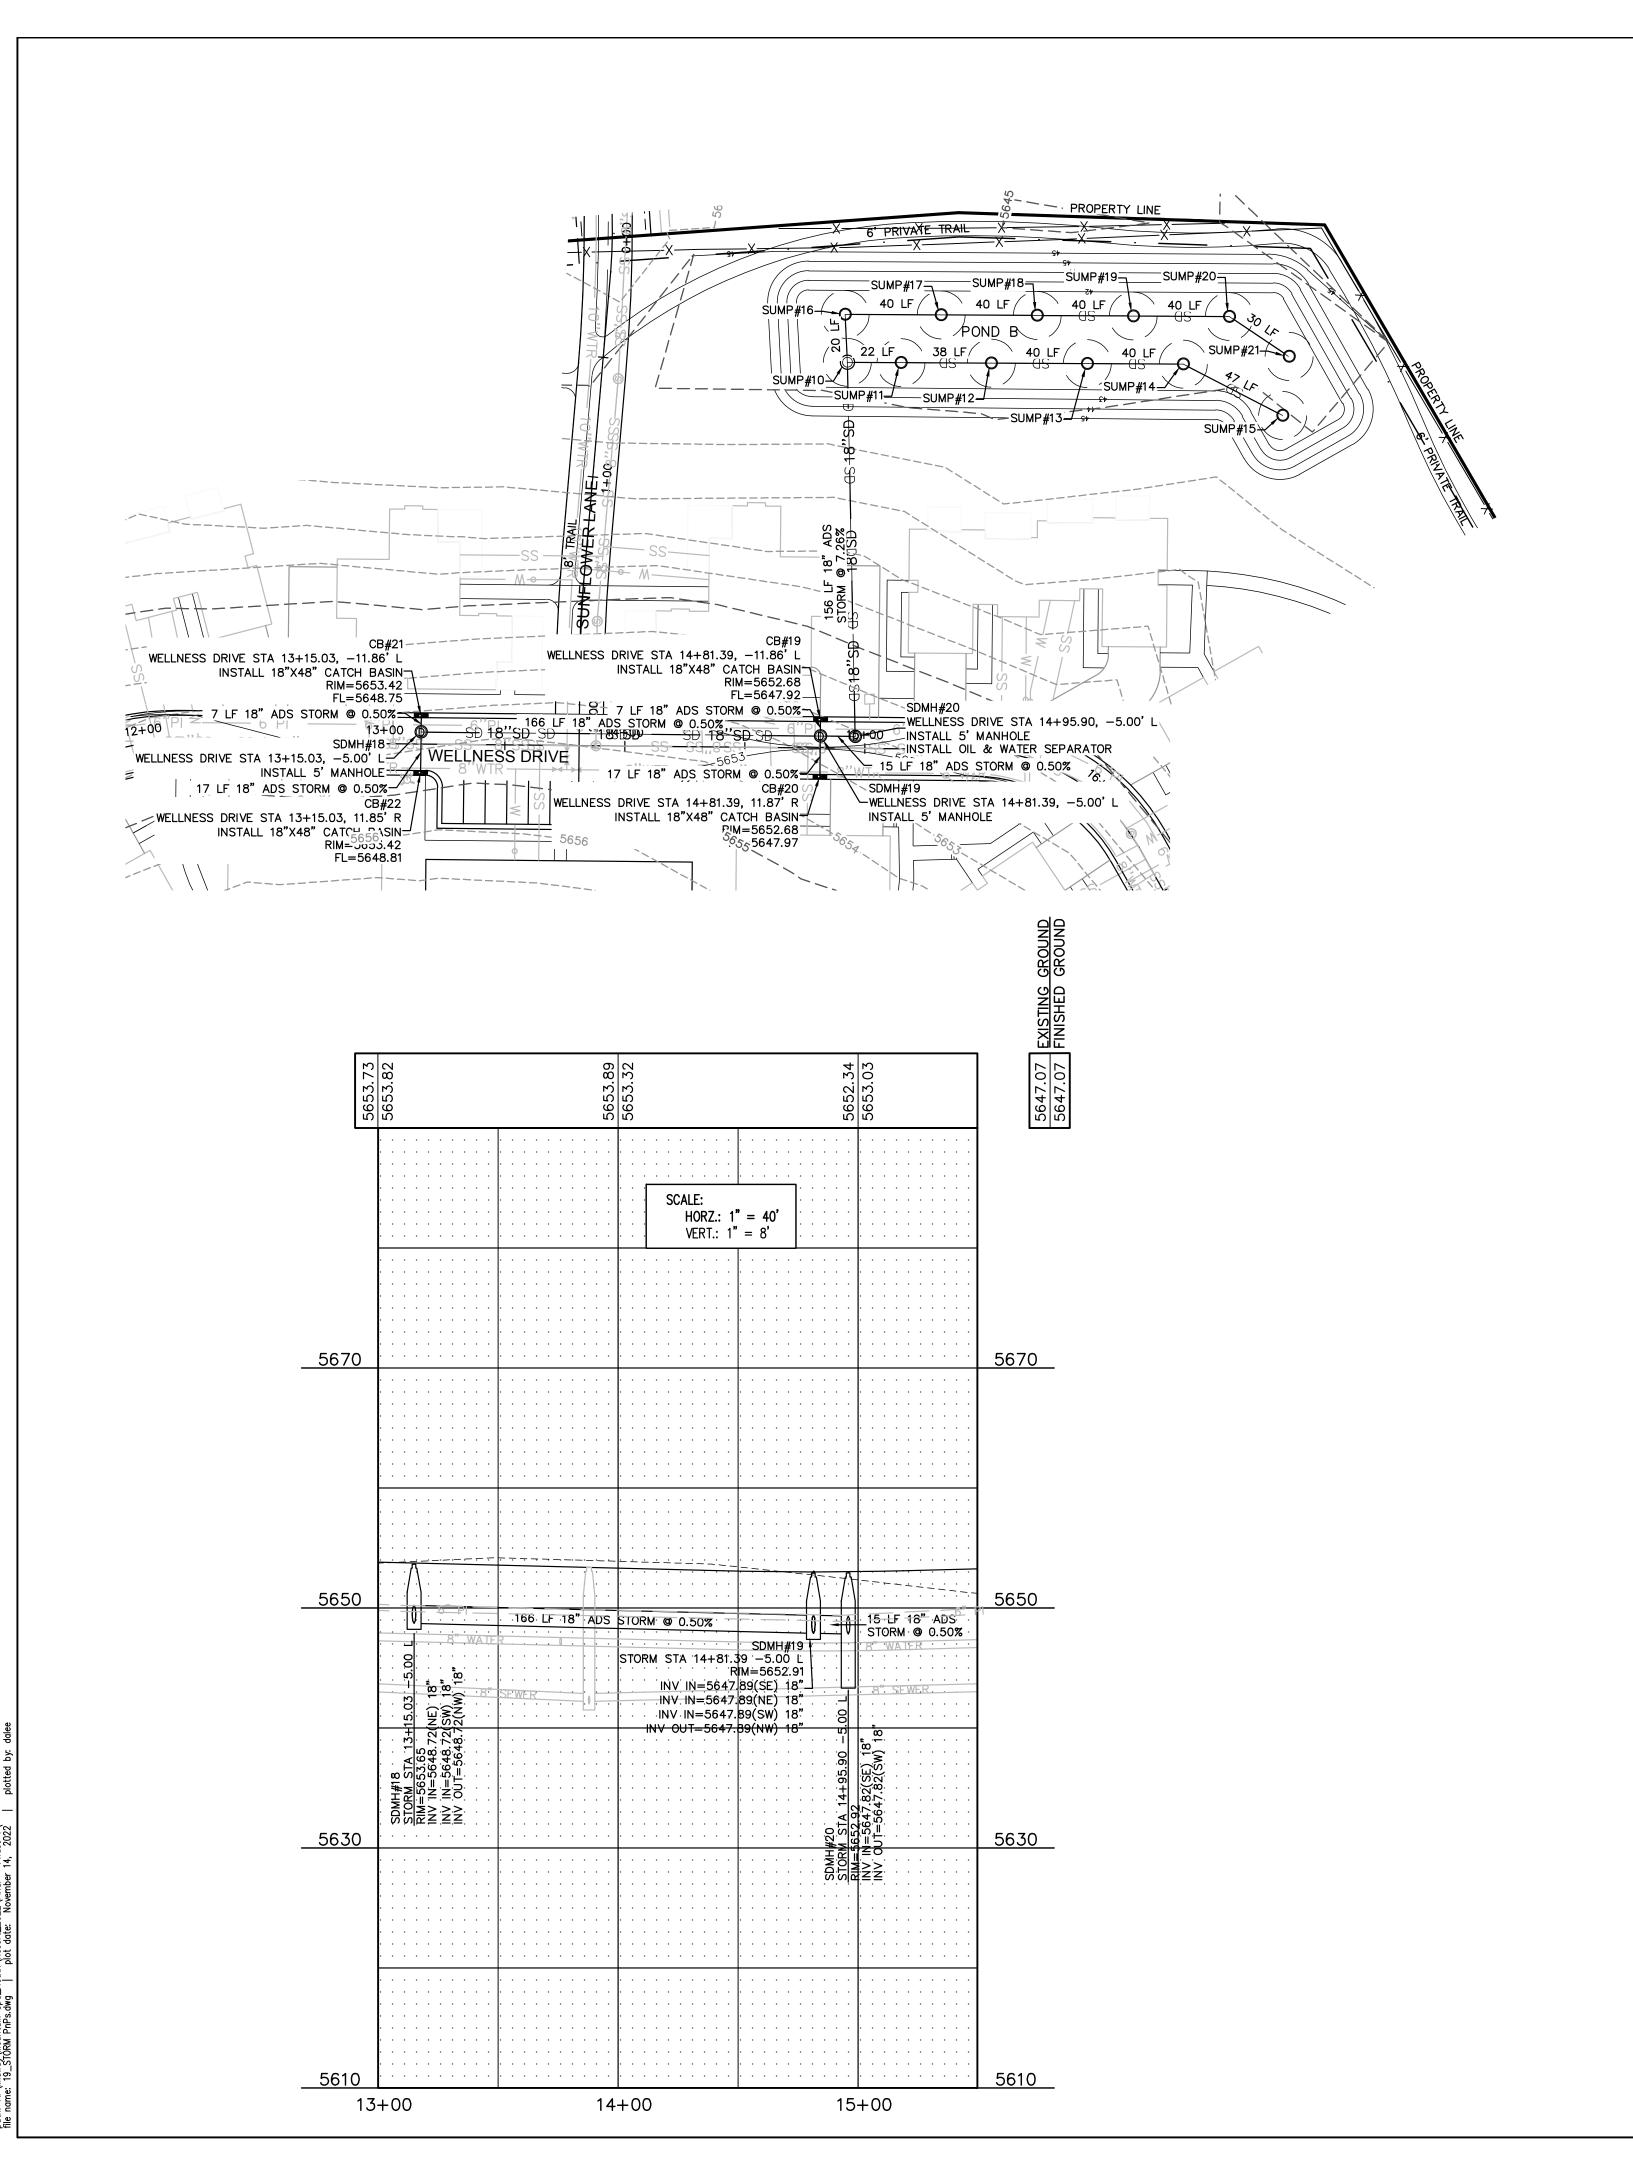

		POND	В		
SUMP	NORTHING	EASTING	RIM	FLOWLINE	BOTTOM OF SUMP
SUMP#10	N=5587.94	E=10608.65	5641.00	5636.50	5633.00
SUMP#11	N=5599.03	E=10589.24	5641.00	5636.39	5633.00
SUMP#12	N=5617.71	E=10556.55	5641.00	5636.20	5633.00
SUMP#13	N=5637.55	E=10521.82	5641.00	5636.00	5633.00
SUMP#14	N=5657.40	E=10487.09	5641.00	5635.80	5633.00
SUMP#15	N=5696.32	E=10461.59	5641.00	5635.57	5633.00
SUMP#16	N=5570.11	E=10599.60	5641.00	5636.40	5633.00
SUMP#17	N=5589.95	E=10564.87	5641.00	5636.20	5633.00
SUMP#18	N=5609.80	E=10530.14	5641.00	5636.00	5633.00
SUMP#19	N=5629.65	E=10495.41	5641.00	5635.80	5633.00
SUMP#20	N=5649.49	E=10460.68	5641.00	5635.60	5633.00
SUMP#21	N=5676.23	E=10447.15	5641.00	5635.45	5633.00

able 5 - 100 Year Storm	Peak Runoff and Volume for	Basin B

Time Period	Rainfall Intensity	Area	Developed Runoff Coefficient	Peak Runoff Rate	Total Runoff Volume
(min)	(in / hr)	(acres)	(4	(cfs)	(cf)
15	4.08	12.92	0.40	21.14	19,025
30	2.76	12.92	0.40	14.30	25,739
60	1.71	12.92	0.40	8.86	31,894
120	0.96	12.92	0.40	4.97	35,811
180	0.65	12.92	0.40	3.37	36,371
360	0.35	12.92	0.40	1.81	39,168
720	0.21	12.92	0.40	1.09	47,002
1440	0.13	12.92	0.40	0.67	58,193

	Total	Soil	12 - 8'	Percolation	Storage
Time	Runoff	Percolation	Sump	from	Needed
Period	Volume	Rate	Volume	Sump	in Pond
(min)	(cf)	(inch / hour)	(cf)	(cf)	(cf)
15	19,025	2.0	10,260	259	8,505
30	25,739	2.0	10,260	518	14,961
60	31,894	2.0	10,260	1,037	20,597
120	35,811	2.0	10,260	2,074	23,477
180	36,371	2.0	10,260	3,110	23,000
360	39,168	2.0	10,260	6,221	22,688
720	47,002	2.0	10,260	12,442	24,300
1440	58.193	2.0	10.260	24.883	23.050

⊟evation	Pond Depth	Pond Area	Pond Volume	Pond Volume	
	(ft)	(sf)	(cf)	(acre-ft)	
5641	0.00	144	0	0.00	
5642	1.00	9,368	4,756	0.11	
5643	2.00	11,566	15,223	0.35	
5644	3.00	13,866	27,939	0.64	contains the 100 year storn
5645	4.00	16,266	43,005	0.99	1' of freeboard

BLUE STAKE NOTE:

 LOCATION OF EXISTING UTILITIES SHOWN ON PLAN ARE APPROXIMATE AND MAY BE INCOMPLETE. CONTRACTOR IS RESPONSIBLE FOR BLUE STAKING OF UTILITIES.

STORM DRAIN SYSTEM NOTE: ALL STORM DRAIN CONSTRUCTION TO MEET MIDWAY CITY STANDARDS.


<u>LEGEND</u>

— EXSS — EXISTING SEWER — 8"SS — PROPOSED 8" SEWER

——EX8''W—— EXISTING 8" WATER - 8"WTR - PROPOSED 8" WATER

--- EXPI --- EXISTING PRESSURIZED IRRIGATION PI PROPOSED PRESSURIZED IRRIGATION

— 18"SD — PROPOSED STORM DRAIN

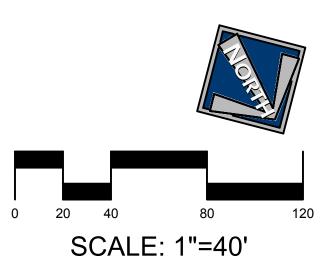

CHUCK HEATH AMEYALLI - PHASE 1

WELLNESS DRIVE - STORM PLAN & PROFILE STA 13+00 - 15+00

BERG ENGINEERING 380 E Main St. Suite 204 Midway, Ut 84049 ph 435.657.9749

DESIGN BY: PDB DATE: 14 NOV 2022 DRAWN BY: DEJ REV:

THIS DOCUMENT IS INCOMPLETE


AND IS RELEASED TEMPORARILY


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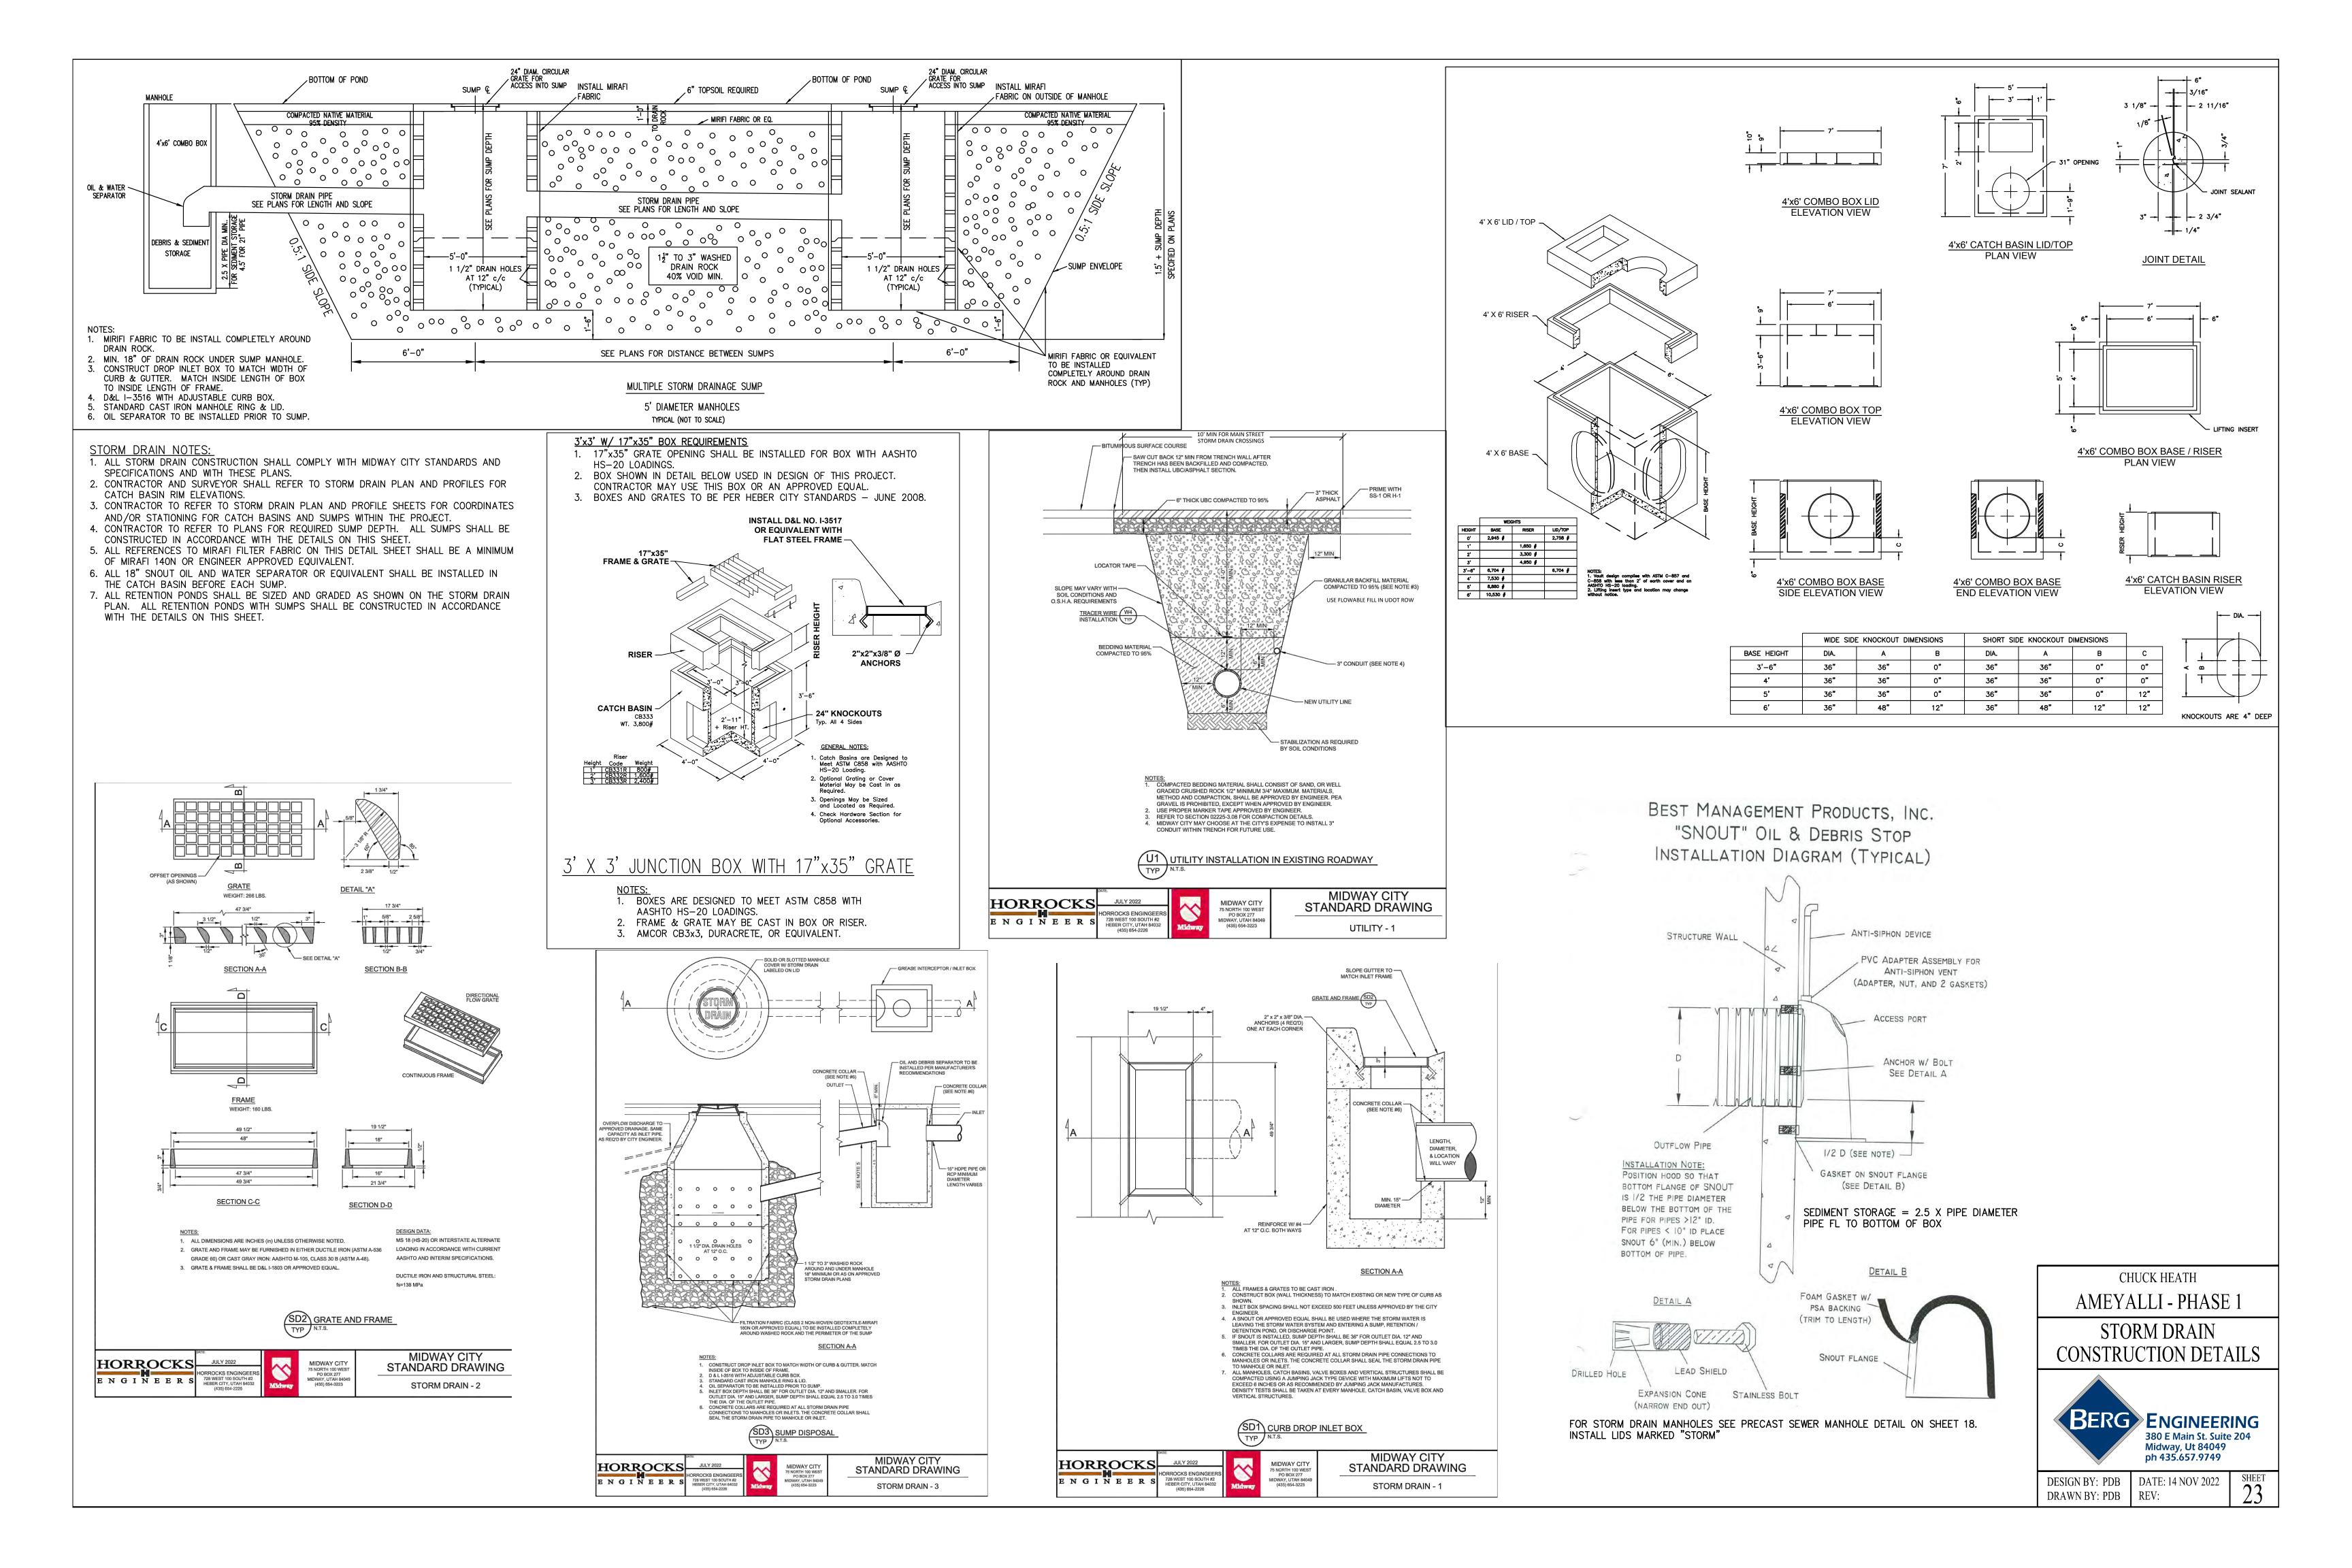
PAUL D. BERG P.E.


SERIAL NO. <u>295595</u>

DATE: <u>14 NOV 2022</u>



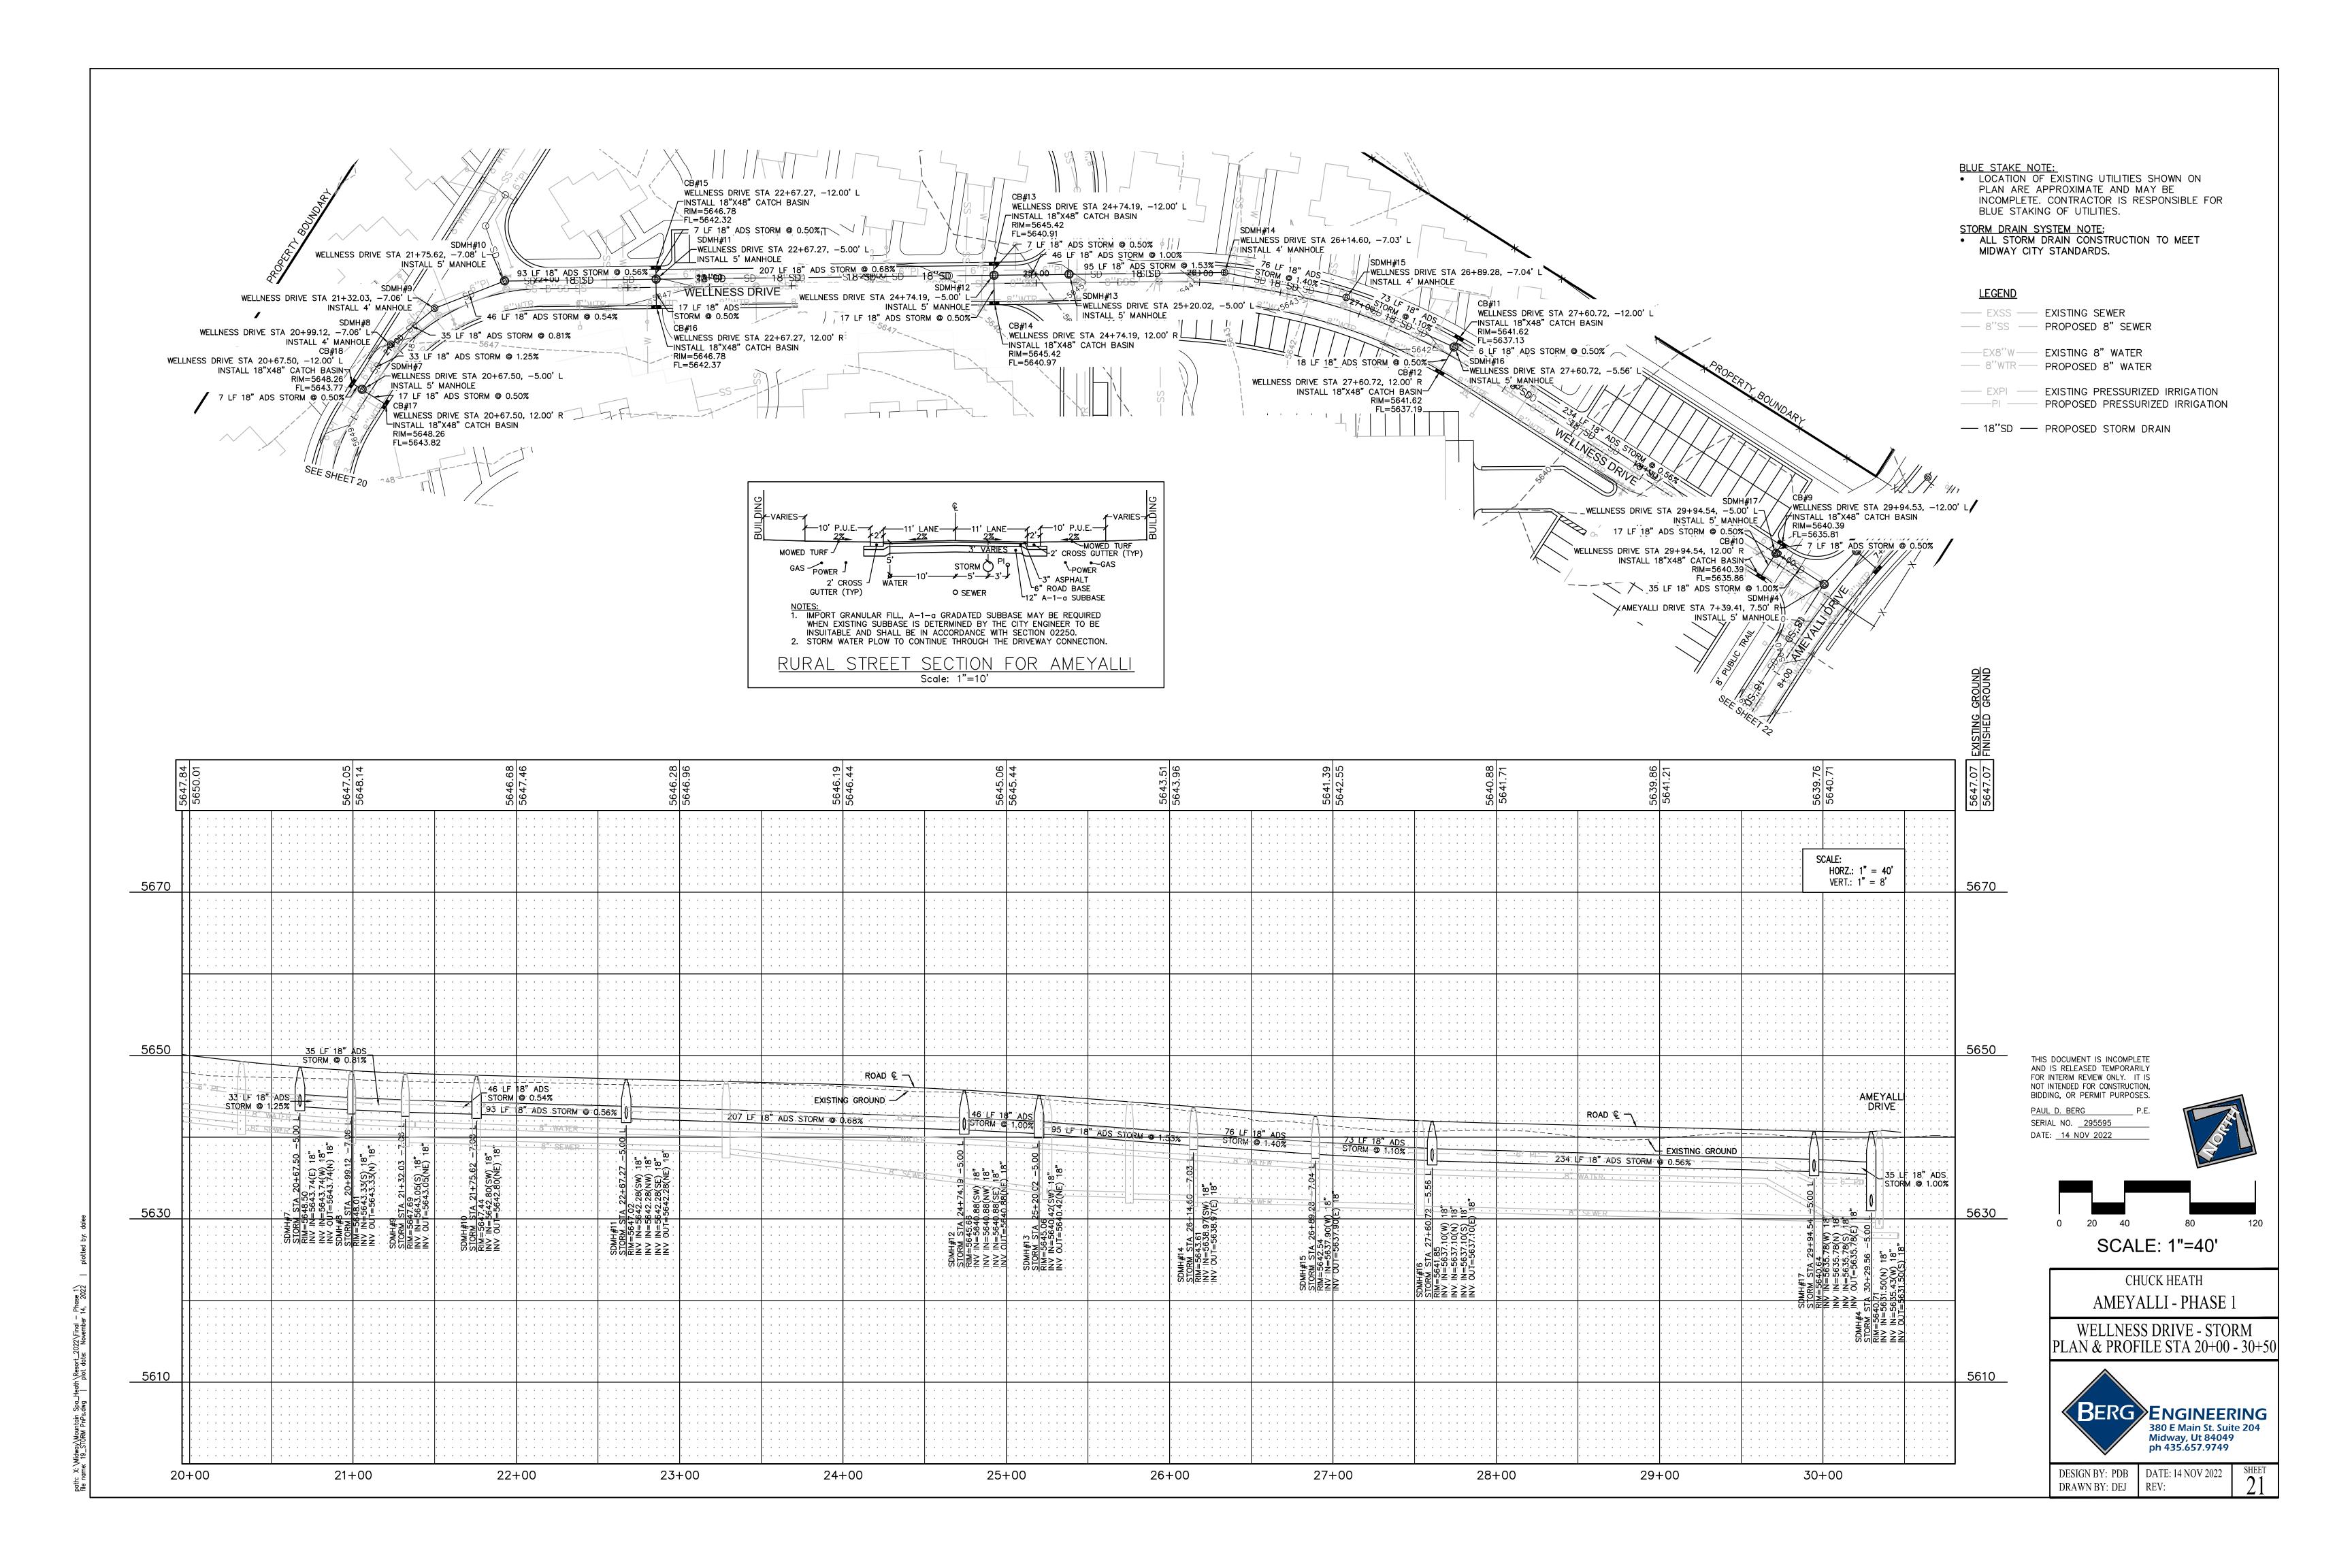

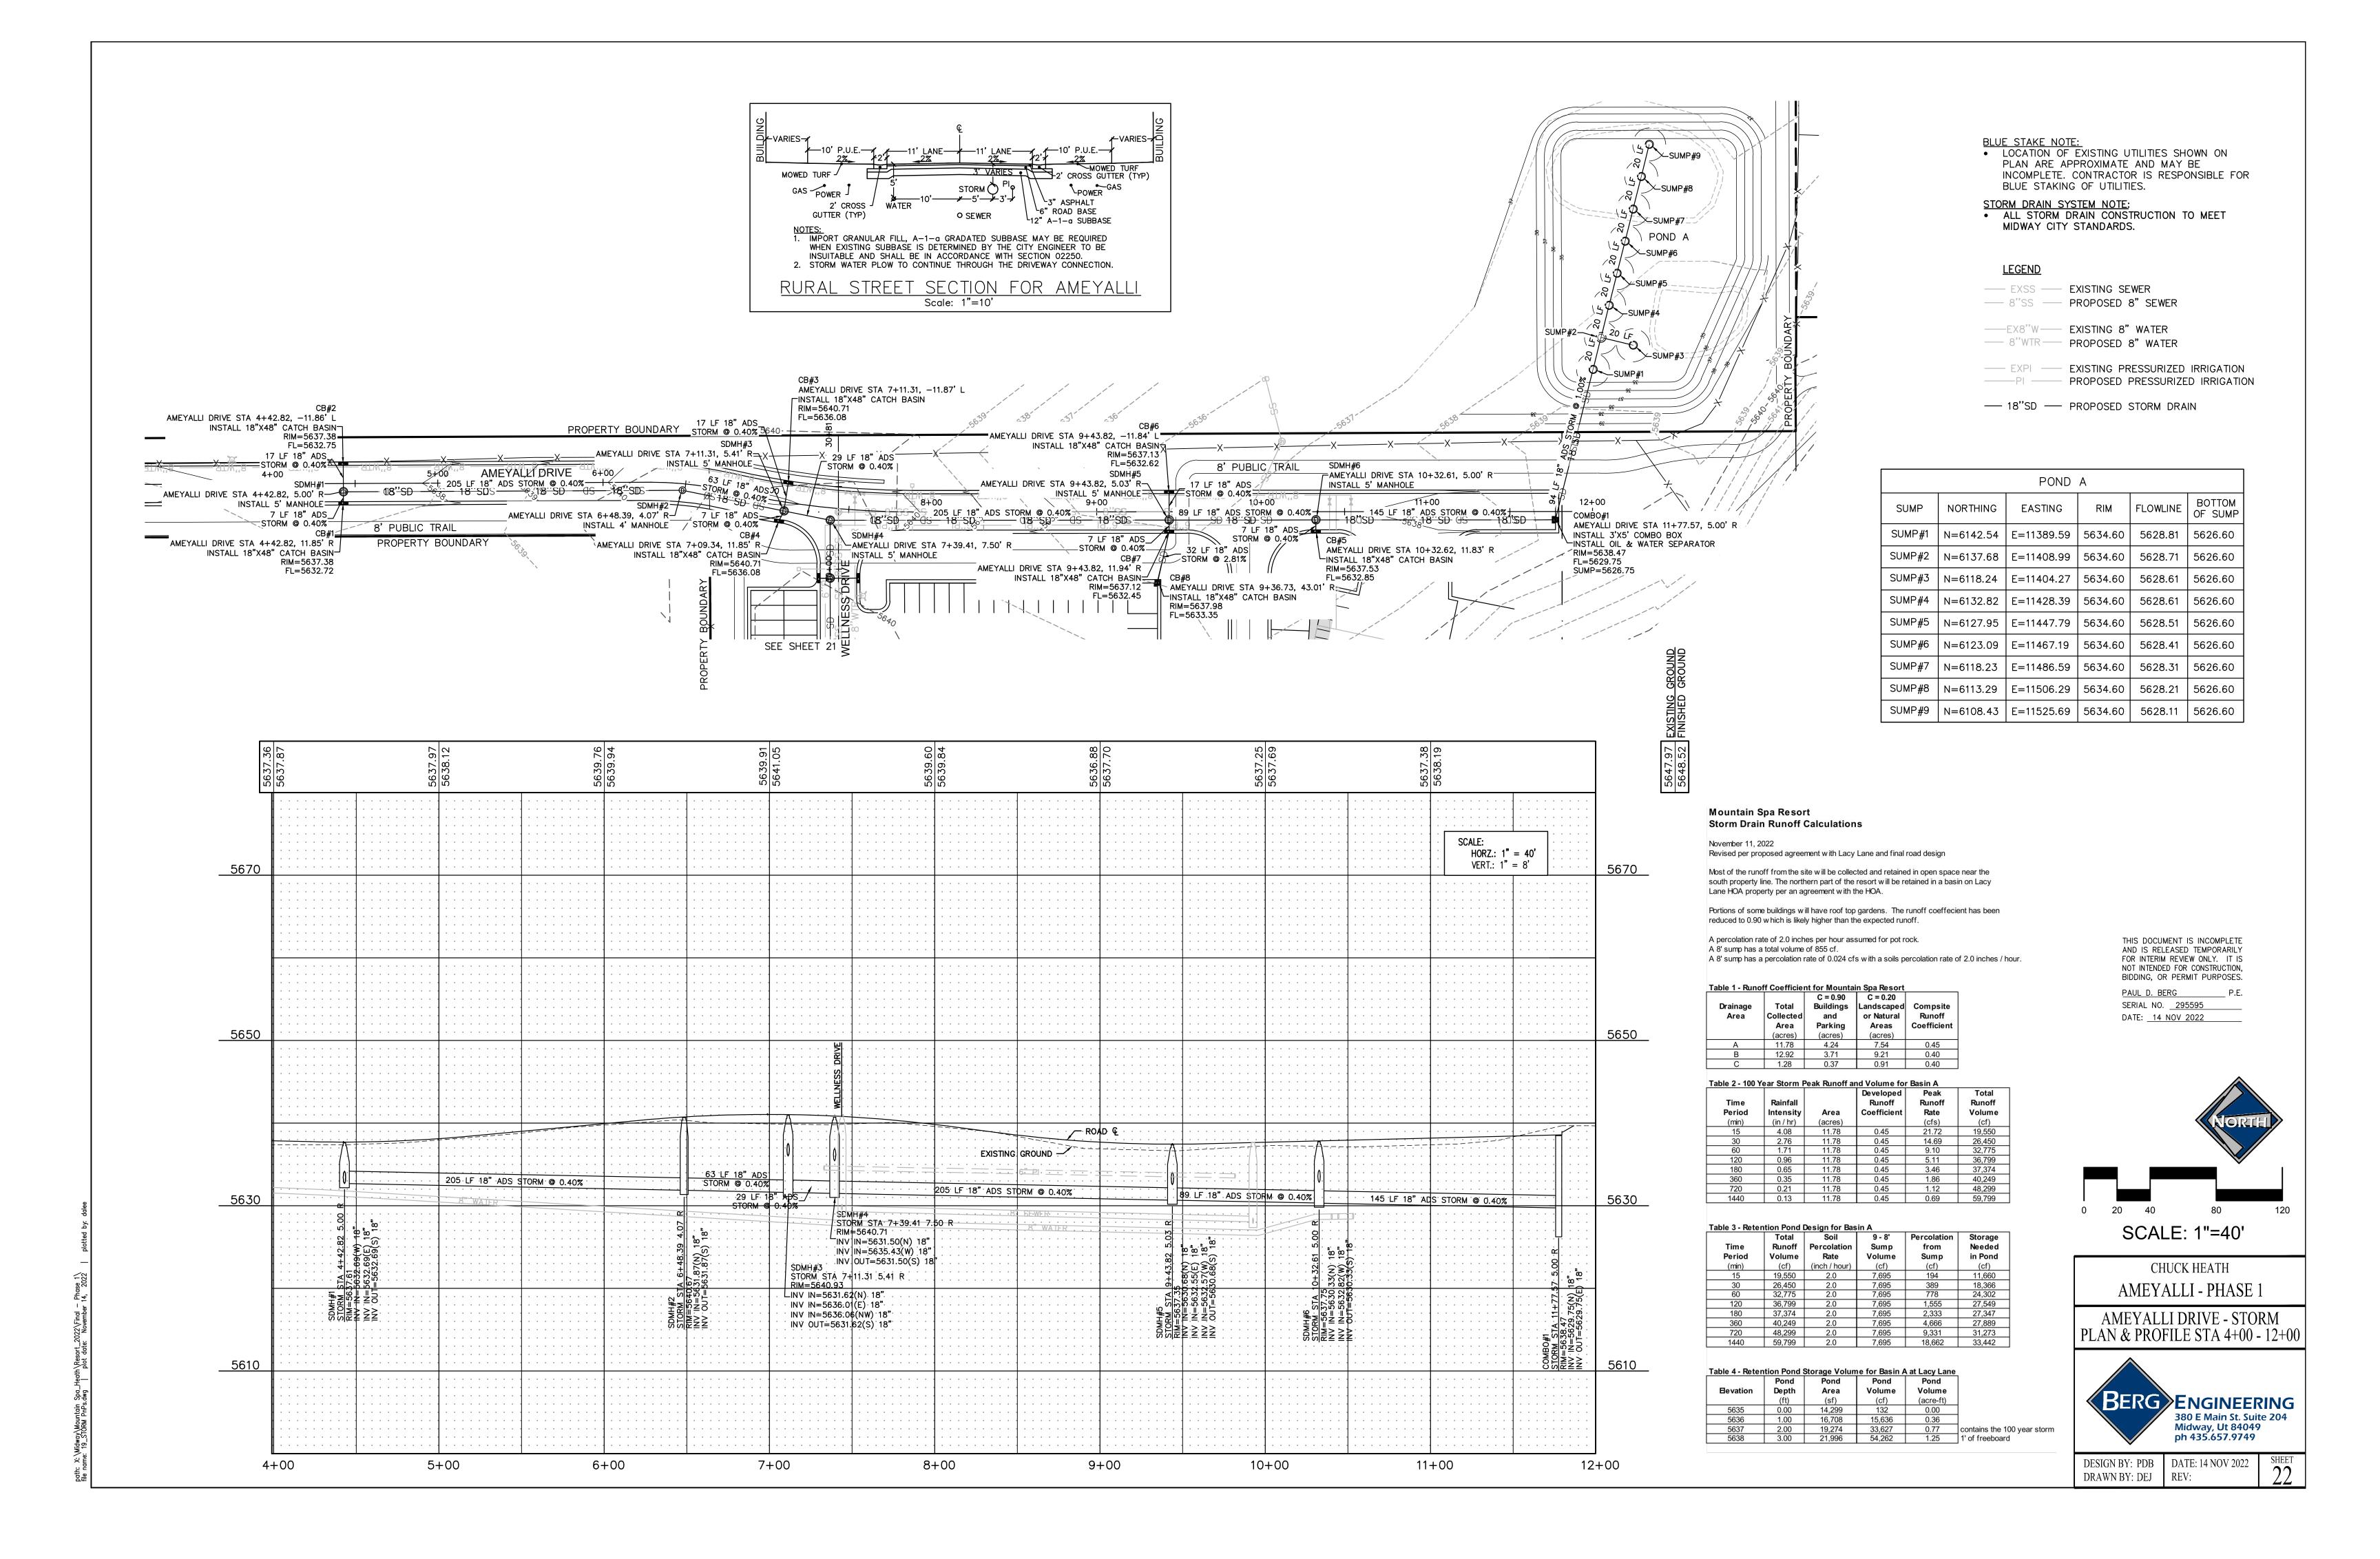

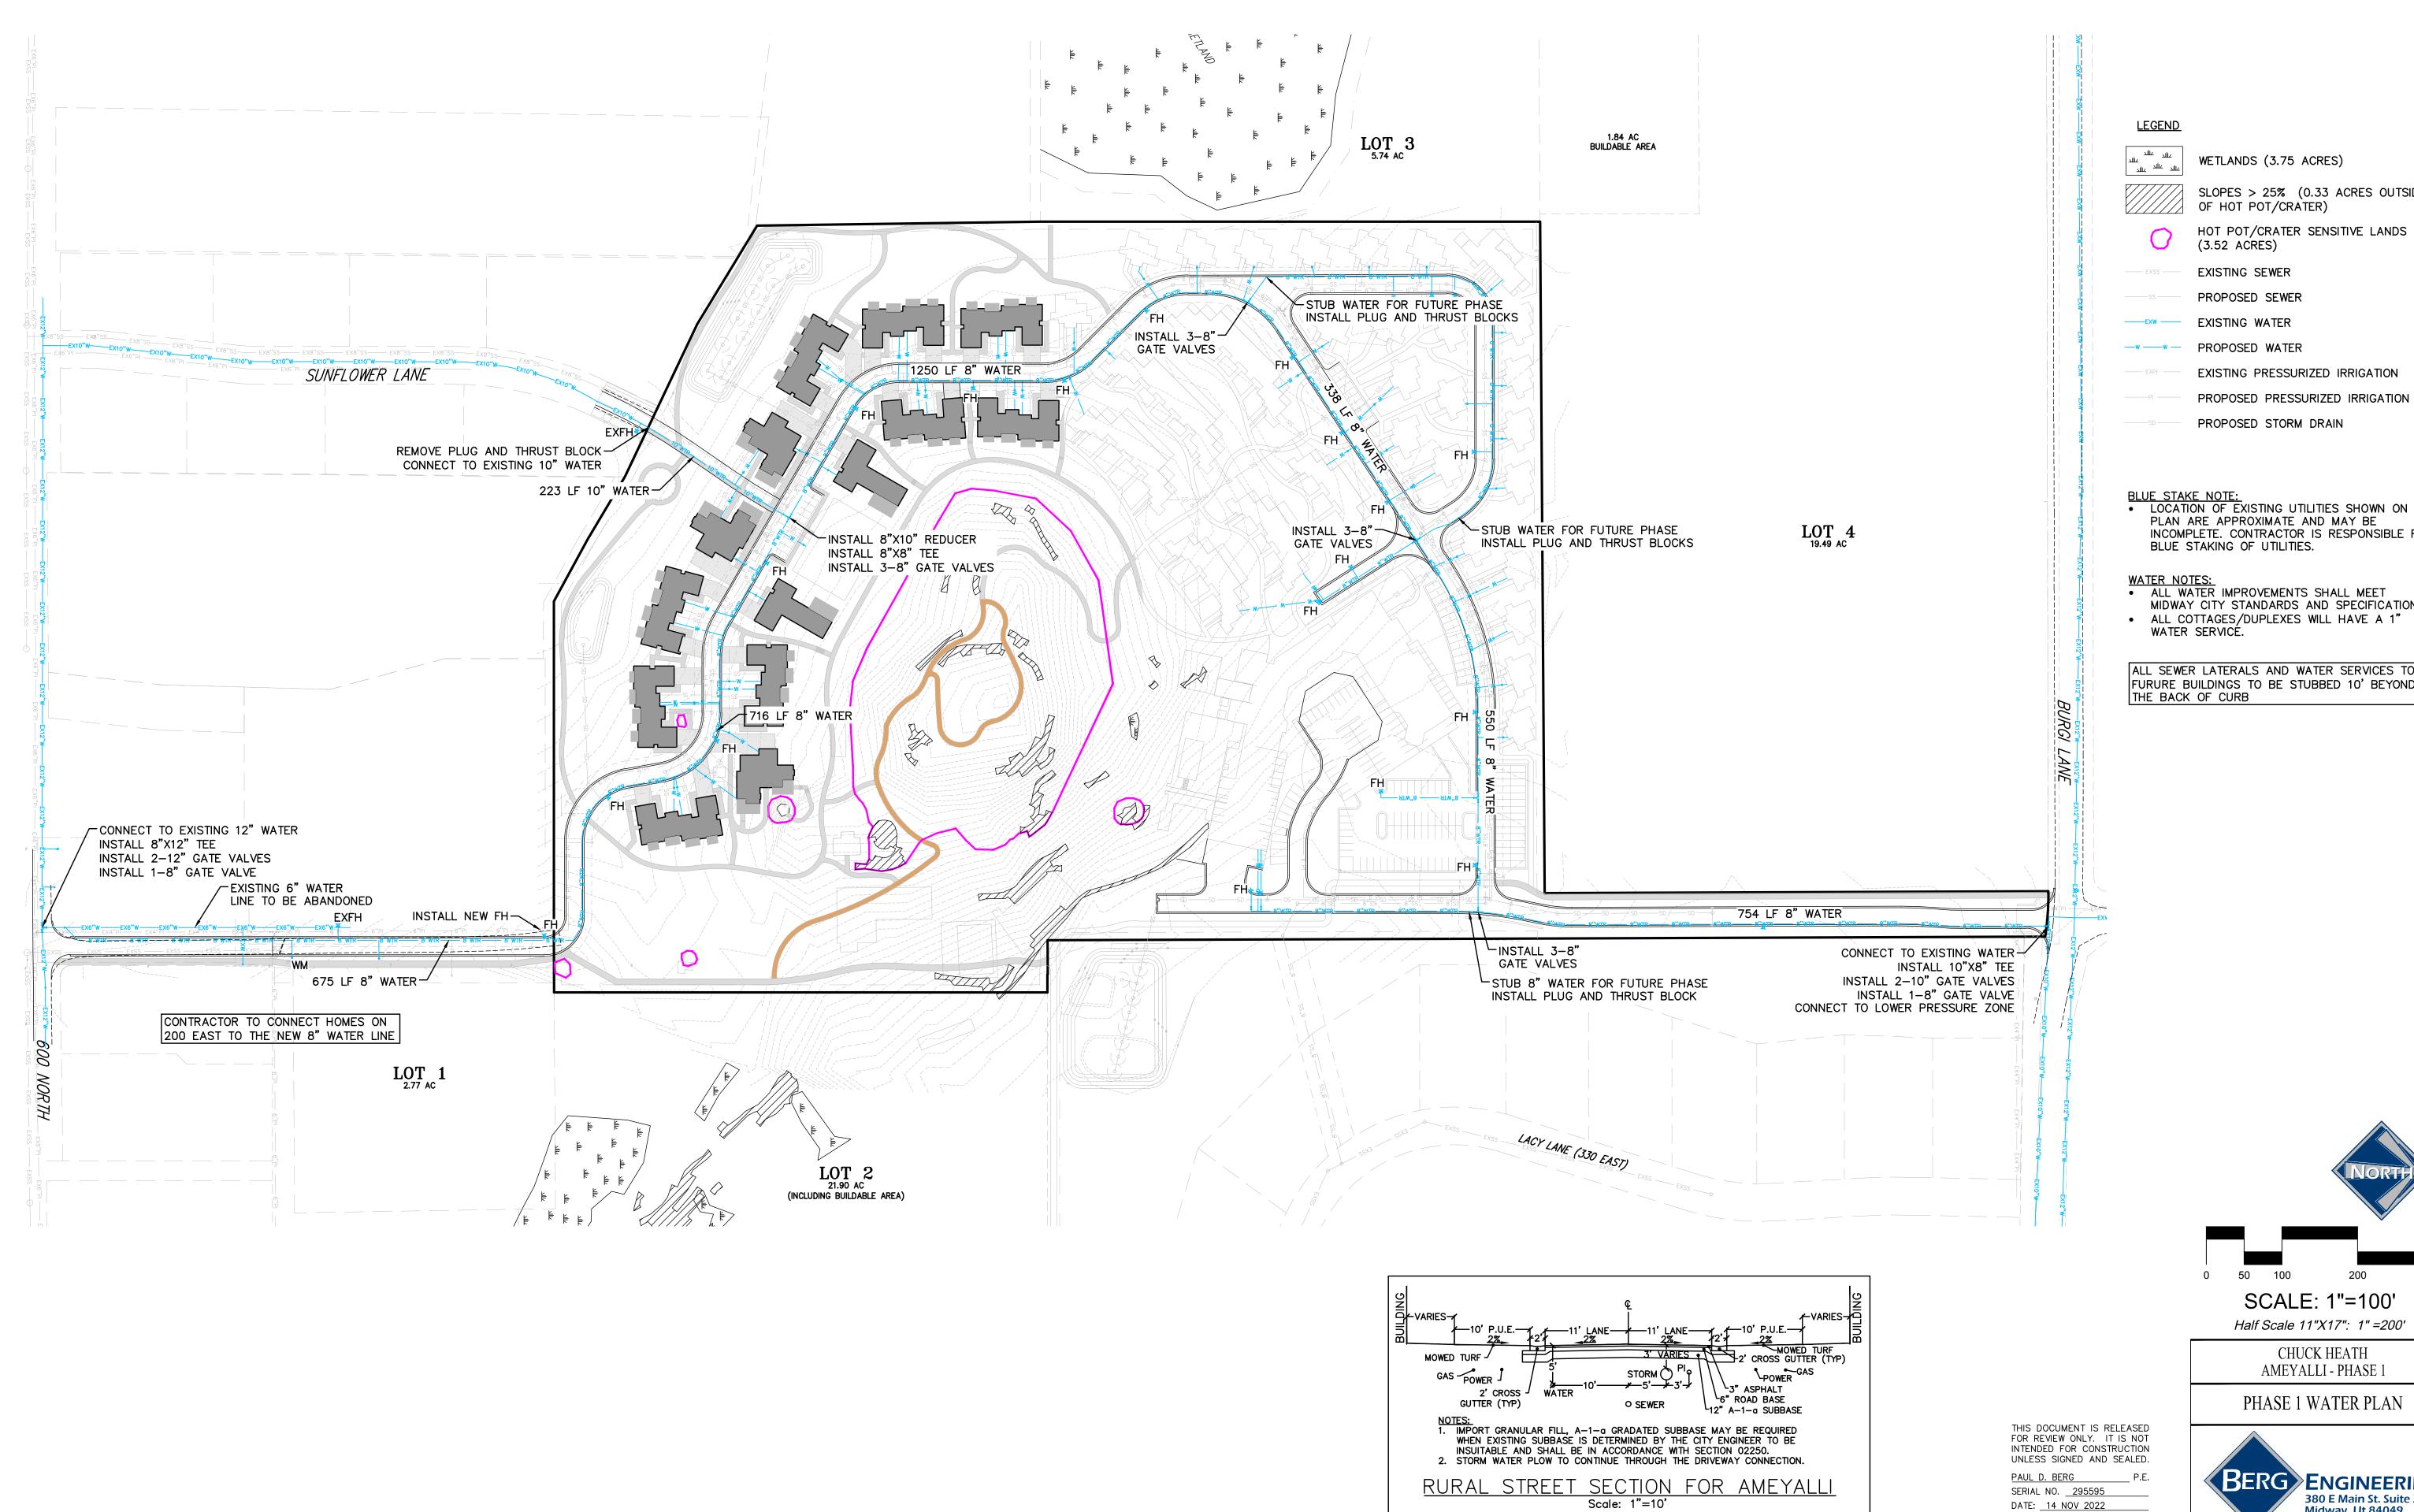

WETLANDS (3.75 ACRES)

SLOPES > 25% (0.33 ACRES OUTSIDE OF HOT POT/CRATER)

EXISTING PRESSURIZED IRRIGATION

PROPOSED STORM DRAIN

BLUE STAKE NOTE:

• LOCATION OF EXISTING UTILITIES SHOWN ON PLAN ARE APPROXIMATE AND MAY BE INCOMPLETE. CONTRACTOR IS RESPONSIBLE FOR

 ALL WATER IMPROVEMENTS SHALL MEET MIDWAY CITY STANDARDS AND SPECIFICATIONS.

ALL COTTAGES/DUPLEXES WILL HAVE A 1"

ALL SEWER LATERALS AND WATER SERVICES TO FURURE BUILDINGS TO BE STUBBED 10' BEYOND

SCALE: 1"=100' Half Scale 11"X17": 1" =200'


> CHUCK HEATH AMEYALLI - PHASE 1

PHASE 1 WATER PLAN

BERG ENGINEERING 380 E Main St. Suite 204 Midway, Ut 84049 ph 435.657.9749

DESIGN BY: PDB DATE: 14 NOV 2022

DRAWN BY: DEJ REV:

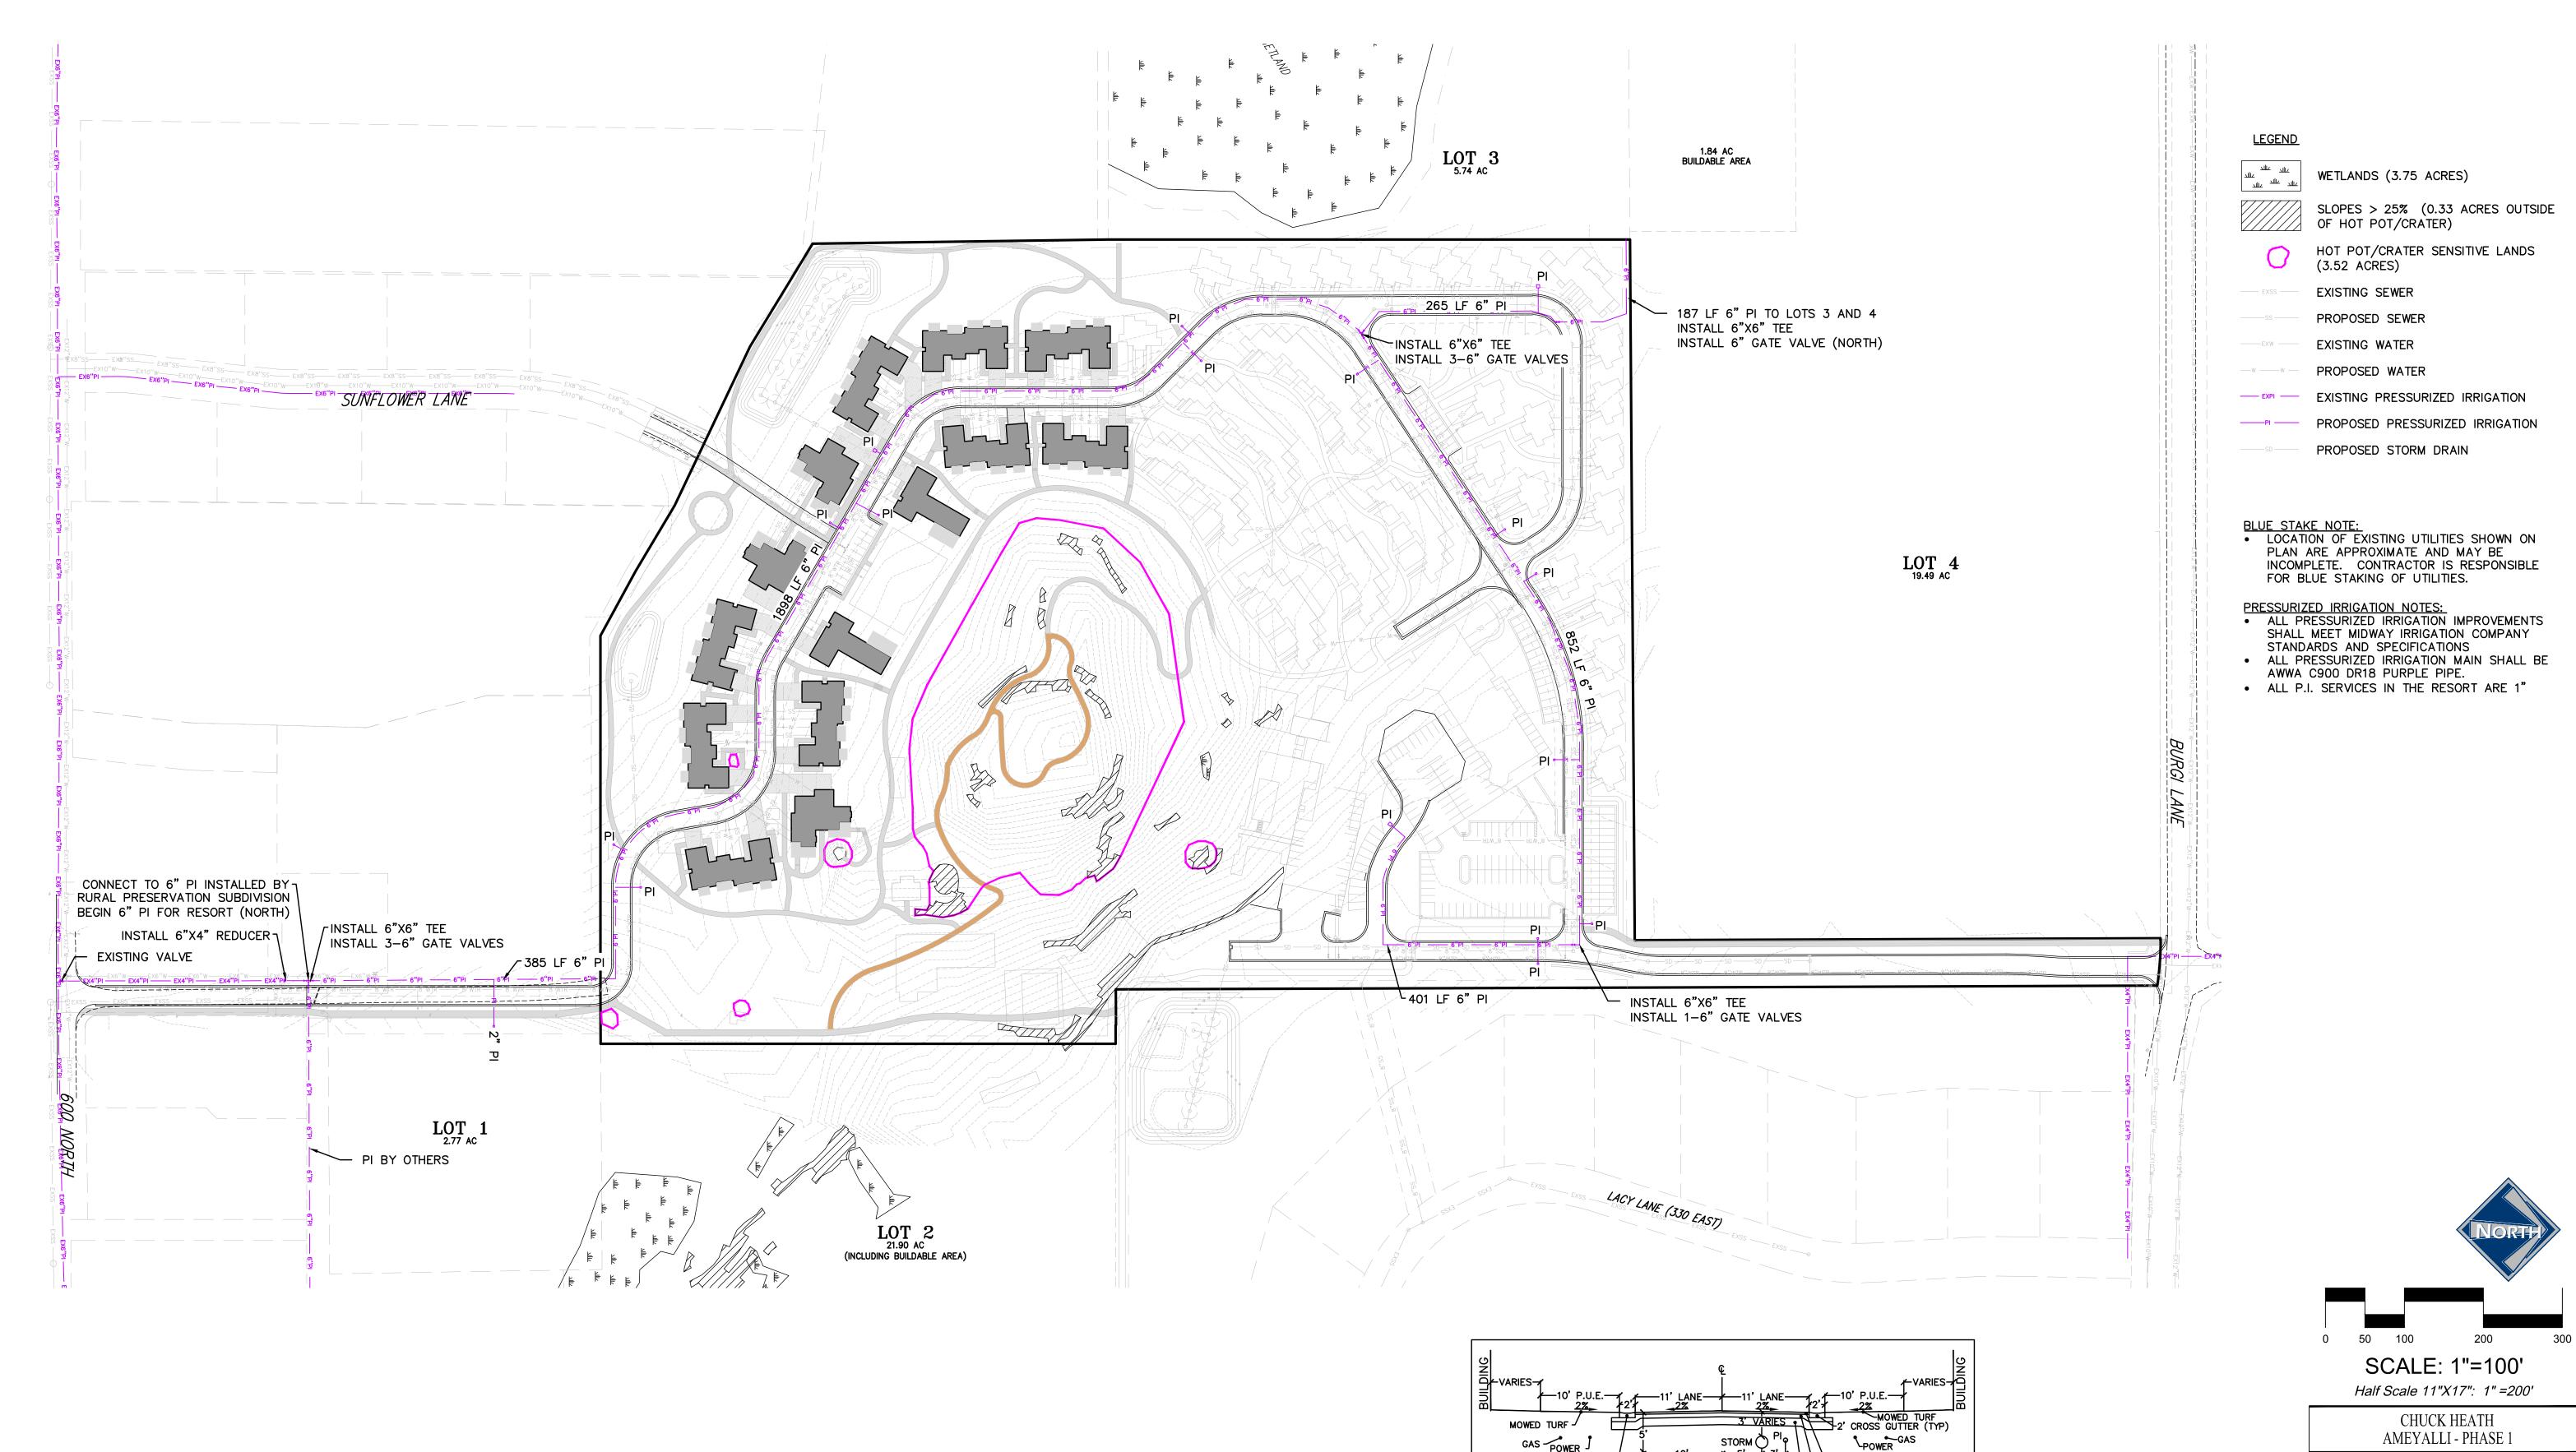

THIS DOCUMENT IS RELEASED FOR REVIEW ONLY. IT IS NOT INTENDED FOR CONSTRUCTION UNLESS SIGNED AND SEALED. PAUL D. BERG P.E. SERIAL NO. <u>295595</u> DATE: 14 NOV 2022

3" ASPHALT 6" ROAD BASE 12" A-1-a SUBBASE

O SEWER

NOTES:

1. IMPORT GRANULAR FILL, A-1-a GRADATED SUBBASE MAY BE REQUIRED WHEN EXISTING SUBBASE IS DETERMINED BY THE CITY ENGINEER TO BE INSUITABLE AND SHALL BE IN ACCORDANCE WITH SECTION 02250.

2. STORM WATER PLOW TO CONTINUE THROUGH THE DRIVEWAY CONNECTION.

RURAL STREET SECTION FOR AMEYALLI


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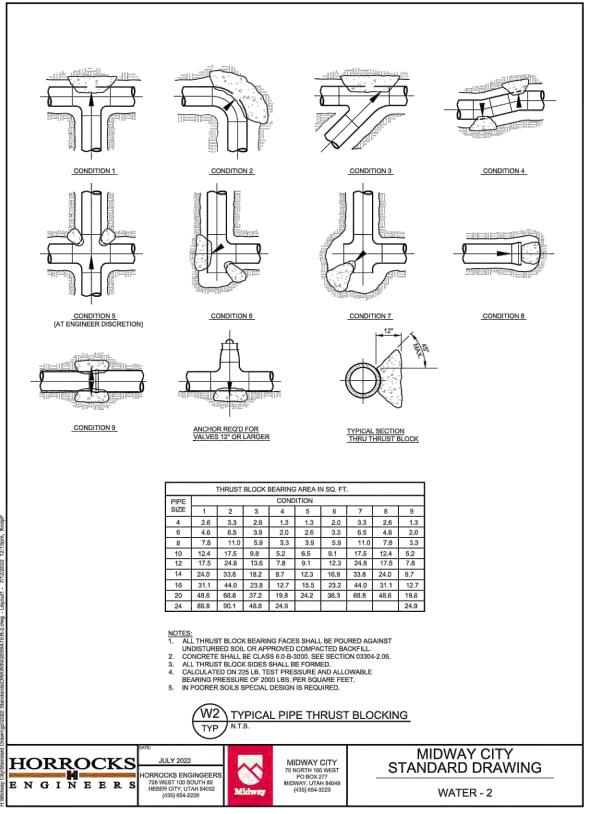
2' CROSS J GUTTER (TYP)


PHASE 1 PRESSURIZED IRRIGATION PLAN BERG ENGINEERING 380 E Main St. Suite 204 Midway, Ut 84049 ph 435.657.9749


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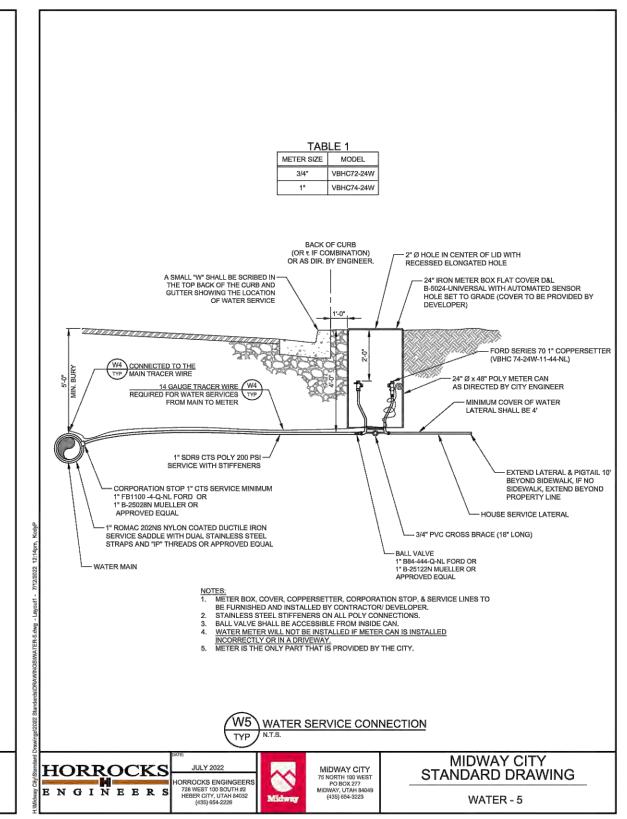
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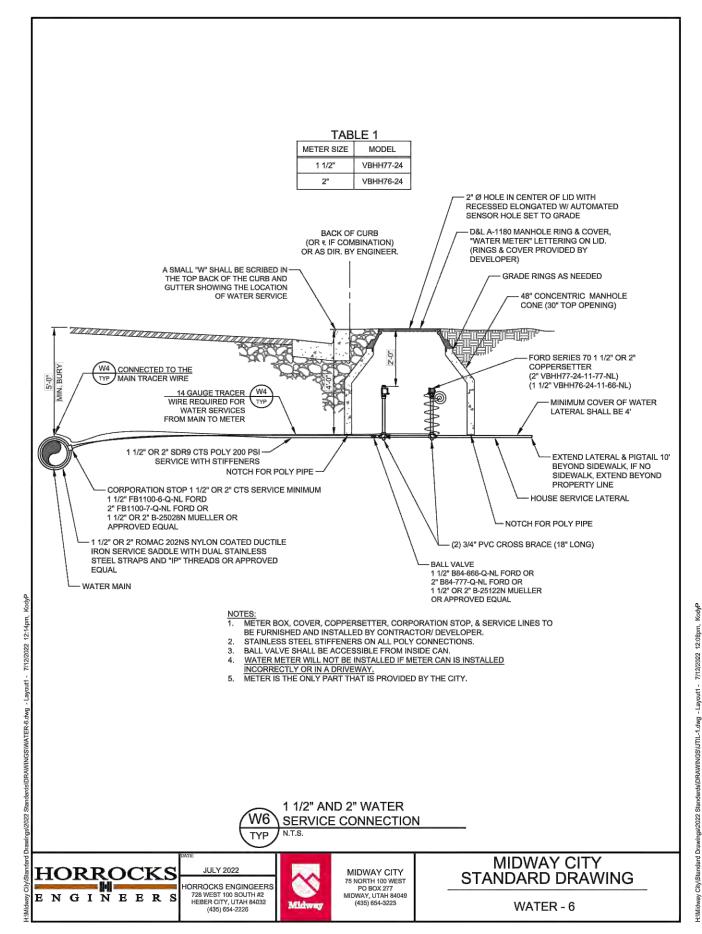








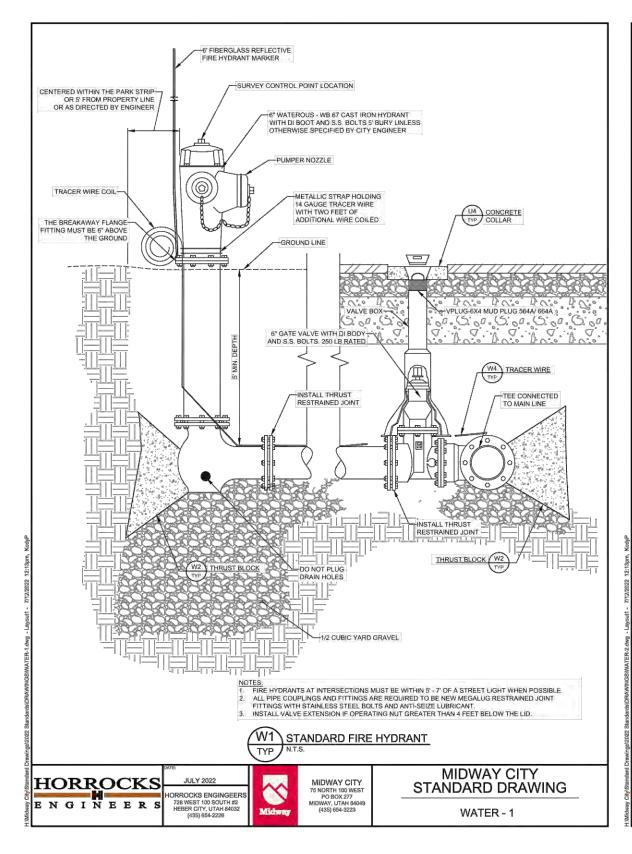


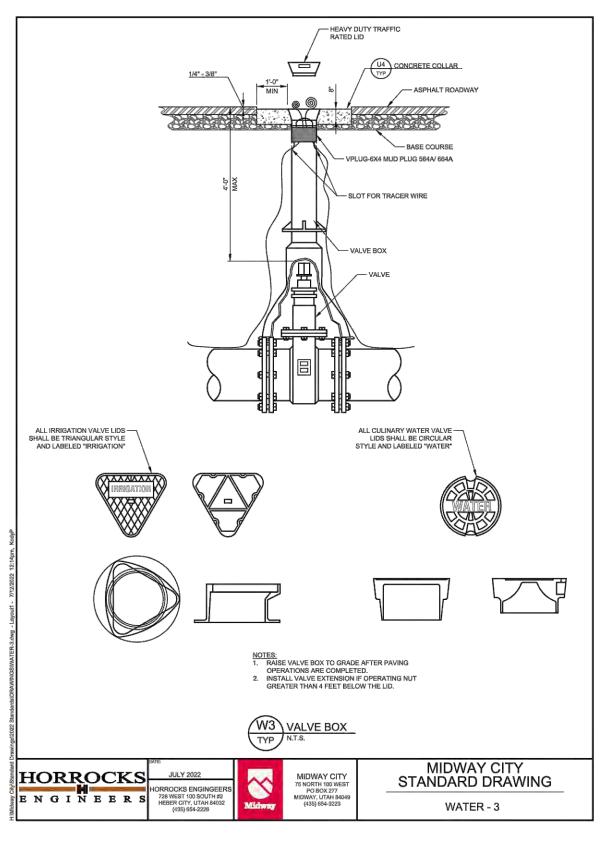


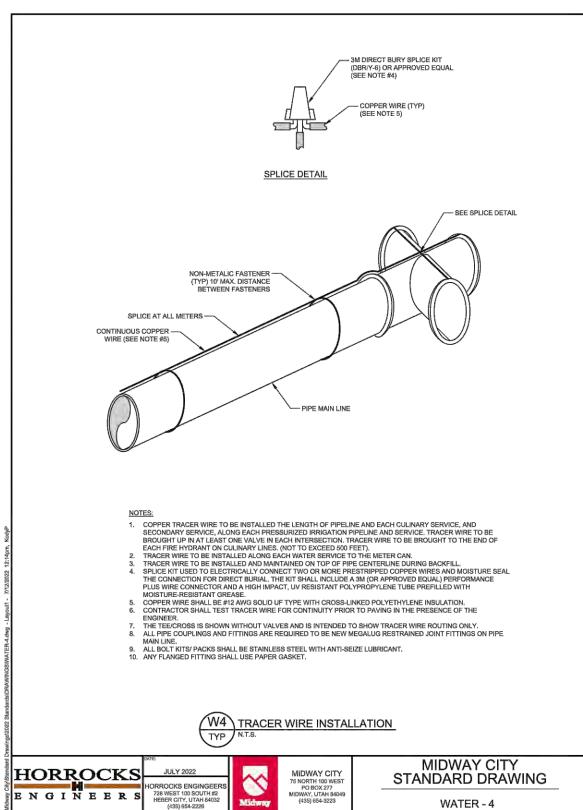

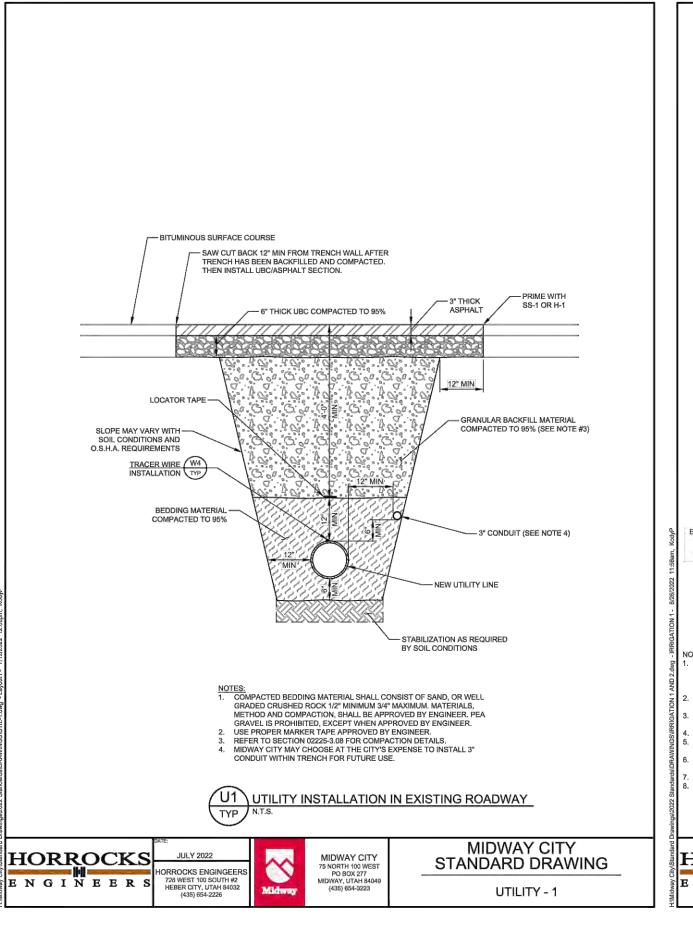

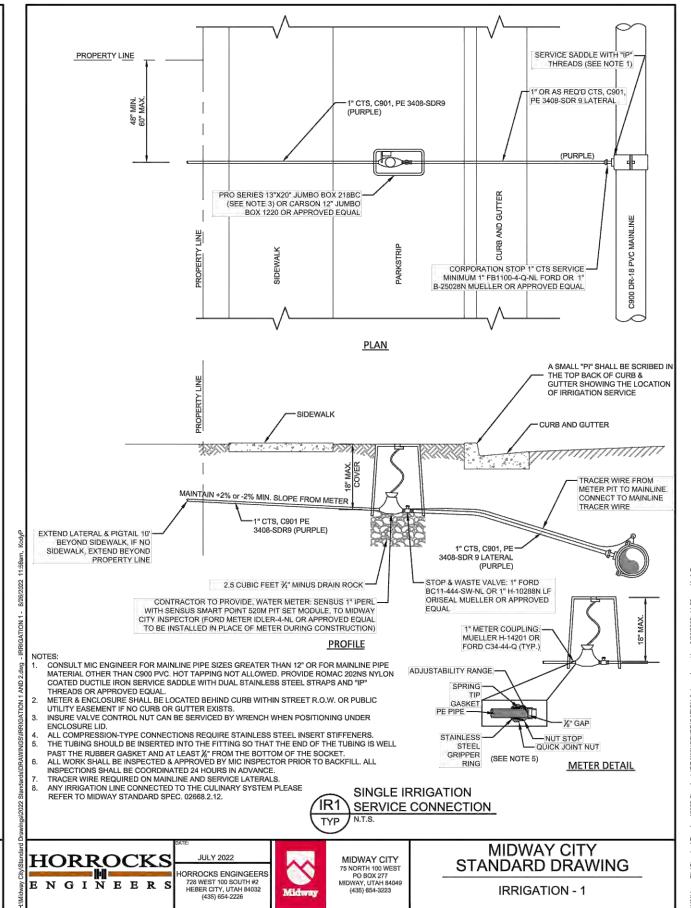


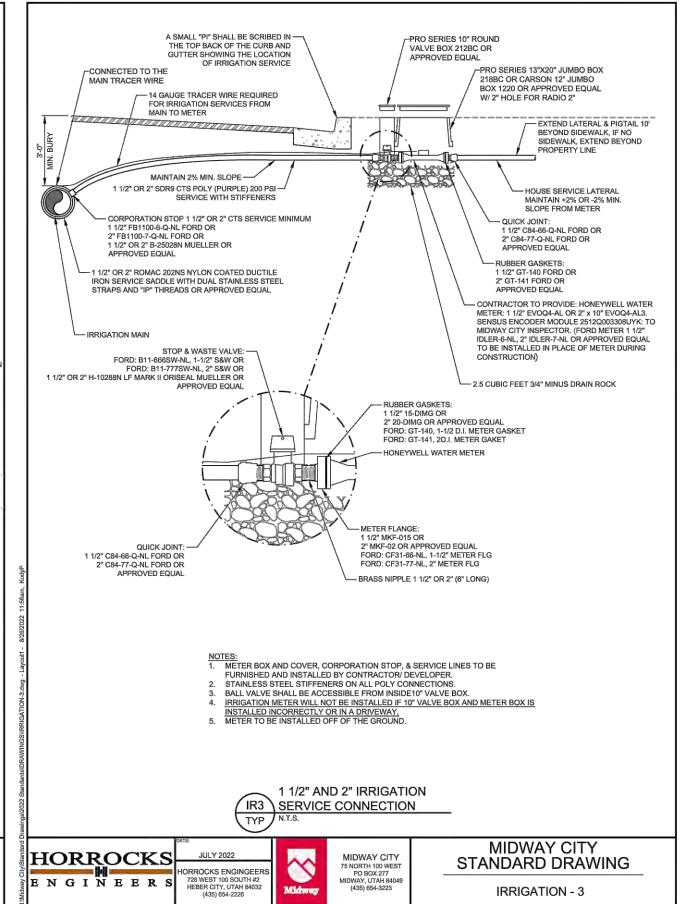

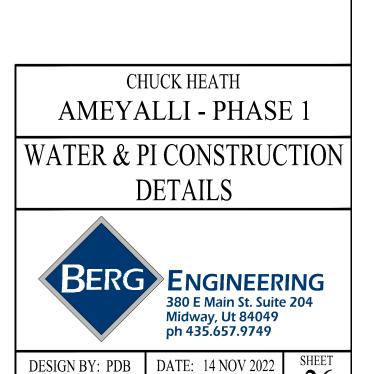

REV:

DRAWN BY: DEJ

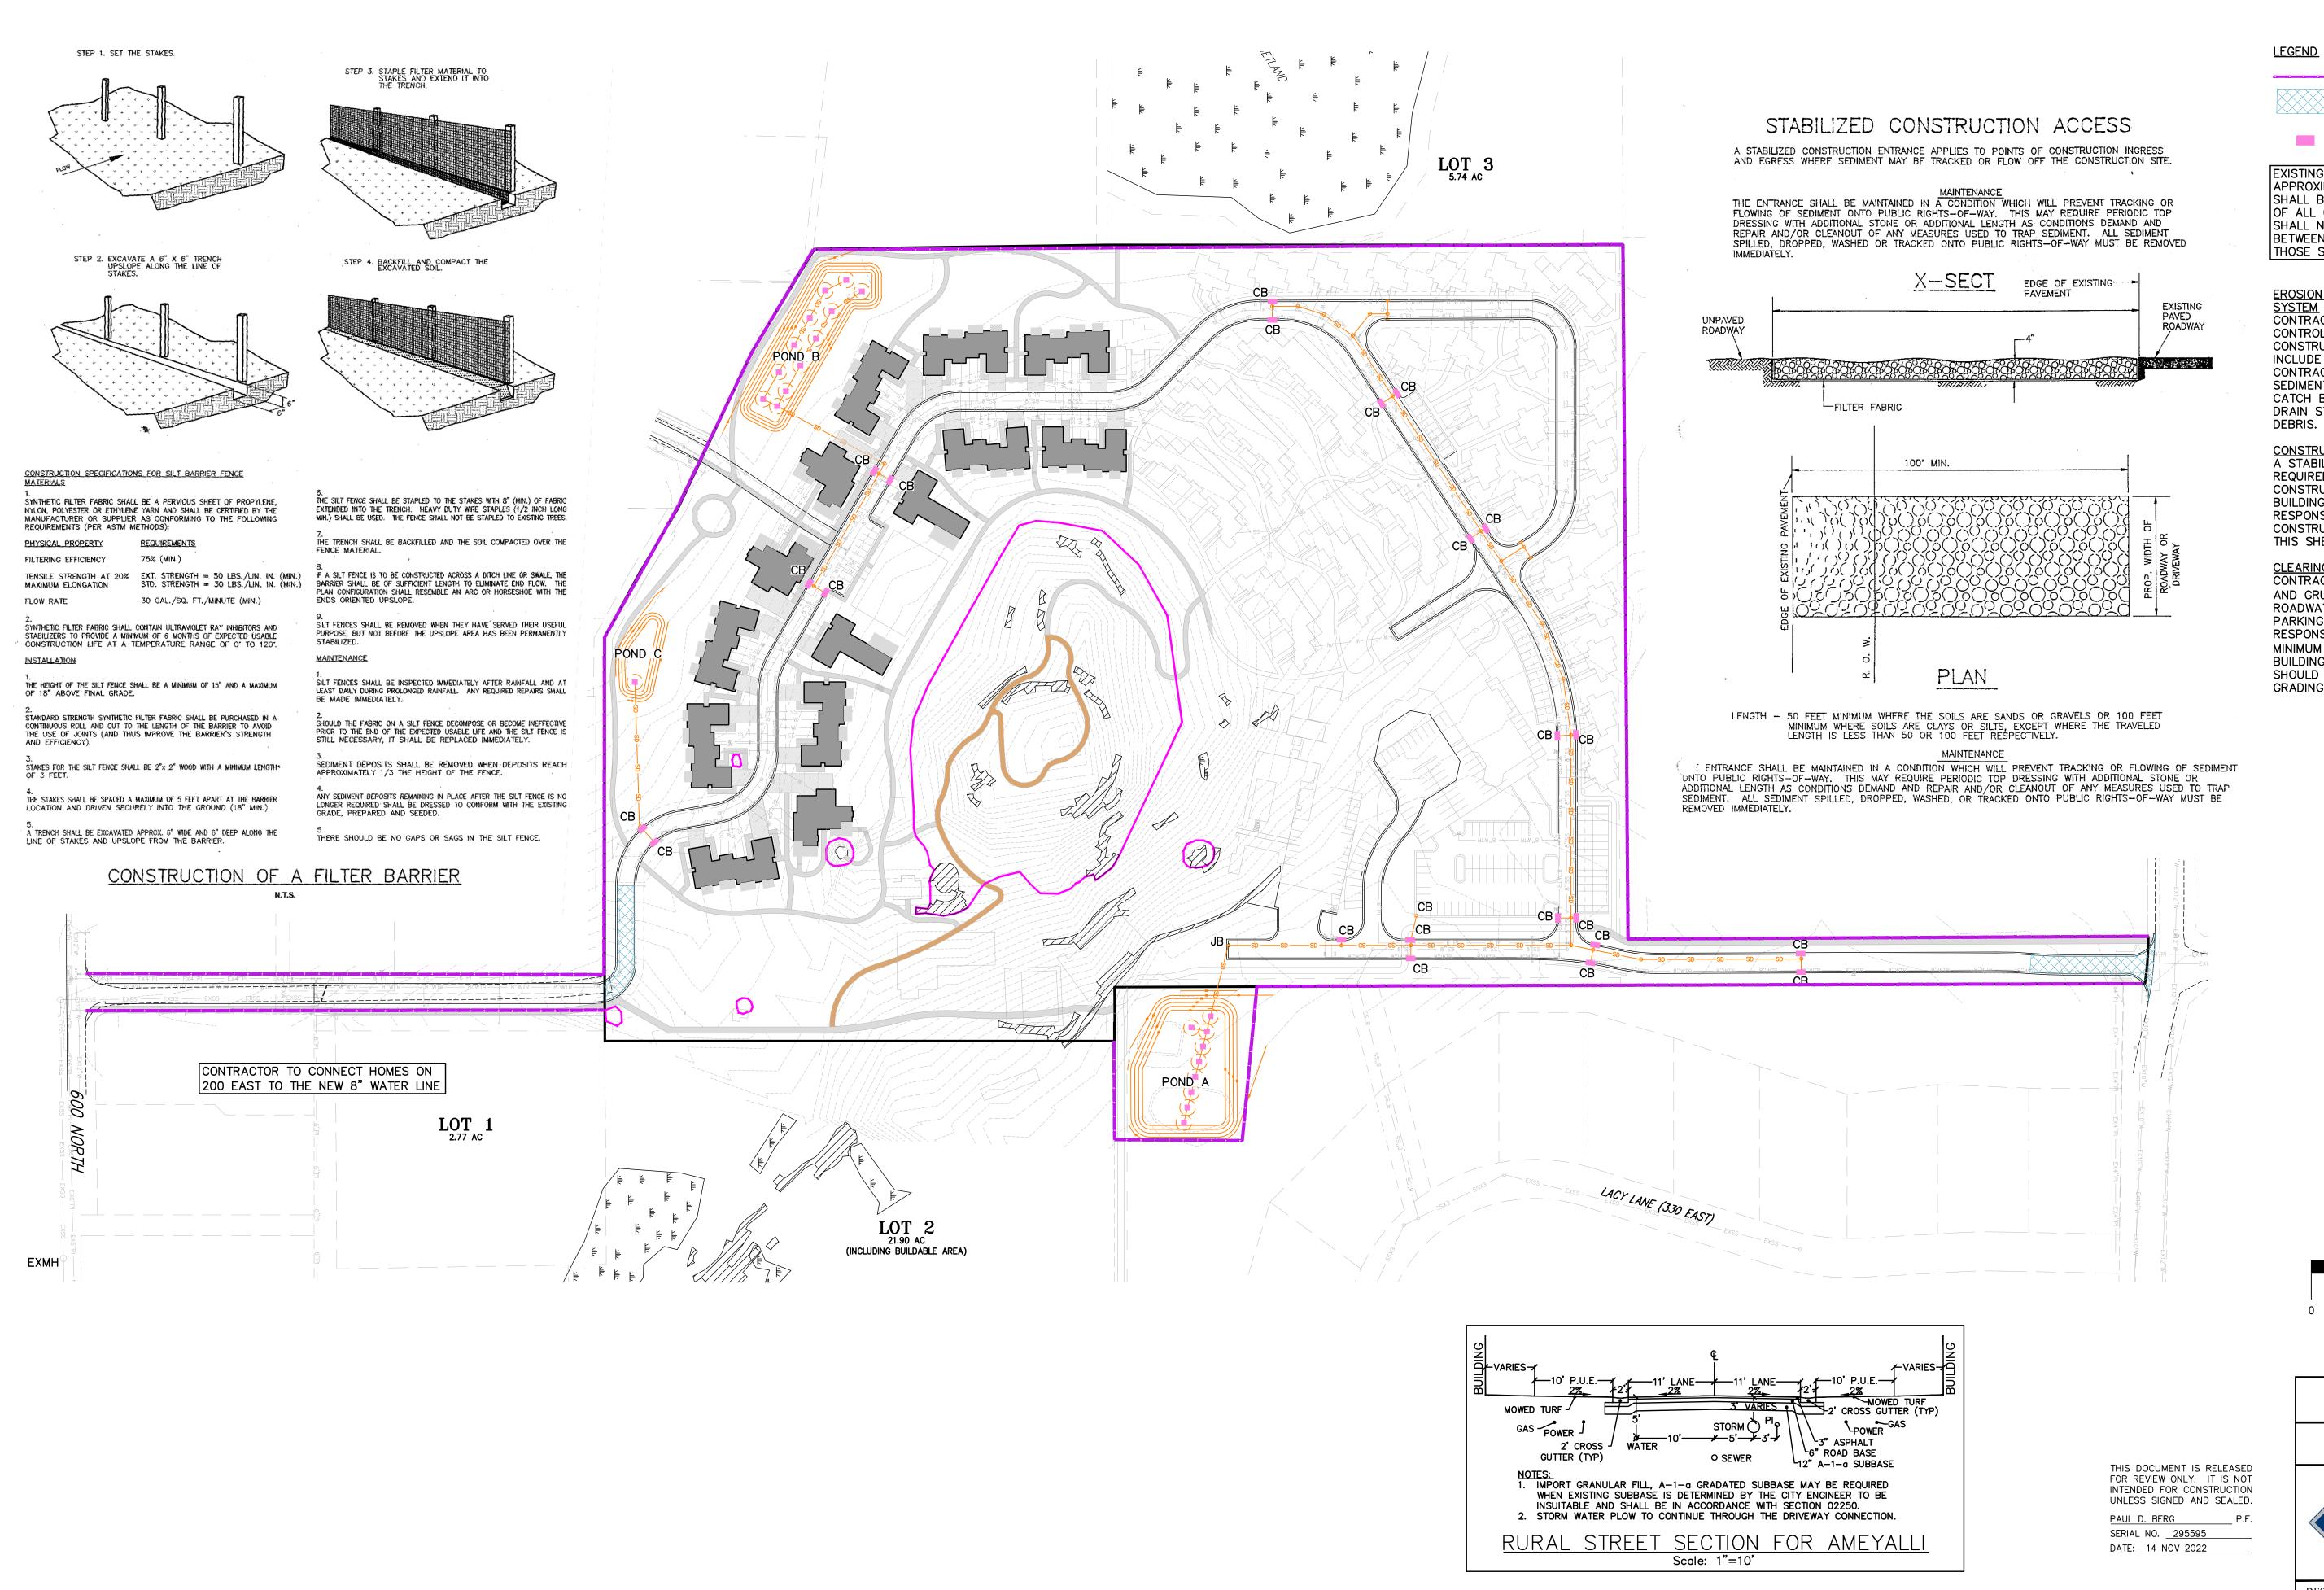

SILT FENCE

STABILIZED CONSTRUCTION ACCESS

INLET PROTECTION

EXISTING UTILITIES SHOWN ON PLANS ARE APPROXIMATE LOCATIONS. CONTRACTOR SHALL BE RESPONSIBLE FOR BLUE STAKING OF ALL ONSITE UTILITIES. CONTRACTOR SHALL NOTIFY ENGINEER OF DIFFERENCES BETWEEN BLUE STAKED LOCATIONS AND THOSE SHOWN ON THIS PLAN.

EROSION CONTROL FOR STORM DRAIN SYSTEM CONTRACTOR SHALL INSTALL EROSION CONTROL AT ALL CATCH BASINS DURING CONSTRUCTION. EROSION CONTROL TO INCLUDE FILTER FABRIC AND HAY BALES. CONTRACTOR SHALL PERIODICALLY REMOVE SEDIMENT THAT COLLECTS AROUND THE CATCH BASINS AND SHALL KEEP THE STORM DRAIN SYSTEM FREE OF SEDIMENT AND

CONSTRUCTION ENTRANCE
A STABILIZED CONSTRUCTION ACCESS IS REQUIRED FOR THIS PROJECT DURING CONSTRUCTION OF THE DEVELOPMENT AND BUILDINGS. THE CONTRACTOR IS RESPONSIBLE FOR INSTALLING A STABILIZED CONSTRUCTION ACCESS. SEE DETAIL ON THIS SHEET FOR ADDITIONAL INFORMATION.

CLEARING AND GRUBBING
CONTRACTOR IS RESPONSIBLE TO CLEAR AND GRUB A MINIMUM OF 12" FROM THE ROADWAY AREA FOR THE STREET AND PARKING AREAS. CONTRACTOR IS RESPONSIBLE TO CLEAR AND GRUB A MINIMUM OF 12" FROM THE PROPOSED BUILDING PADS AND DRIVEWAYS. GRUBBINGS SHOULD REMAIN ON SITE FOR USE IN SITE GRADING FOR LANDSCAPED AREAS.

SCALE: 1"=100'

Half Scale 11"X17": 1" =200'

CHUCK HEATH AMEYALLI - PHASE 1

PHASE 1 SWPPP

BERG ENGINEERING 380 E Main St. Suite 204 Midway, Ut 84049 ph 435.657.9749

DRAWN BY: DEJ REV:

DESIGN BY: PDB DATE: 14 NOV 2022

GENERAL LANDSCAPE NOTES:

- CODES, LAWS, REGULATIONS & PERMITS BY FEDERAL, STATE, COUNTY AND CITY AGENCIES FOR DESIGN CONCEPT, MATERIALS AND WORKMANSHIP MUST BE RESEARCHED AND SATISFIED BY THE CONTRACTOR. REPORT ANY PROBLEMS OR REQUIREMENTS TO THE LANDSCAPE ARCHITECT. THE CONTRACTOR MUST VERIFY THE REGULATIONS FOR AND SECURE ANY PERMITS BEFORE BEGINNING CONSTRUCTION. THE COST FOR THE PERMIT FEES MAY BE SUBMITTED TO THE OWNER FOR REIMBURSEMENT. CALL BLUE STAKES AND REFER TO DRAINAGE AND CIVIL PLANS BEFORE ANY TRENCHING OR EXCAVATION.
- CONSTRUCTION SAFETY & CLEANUP MUST MEET OSHA STANDARDS AT ALL TIMES. ALL CONTRACTORS MUST HAVE ADEQUATE LIABILITY, PERSONNEL INJURY AND PROPERTY DAMAGE INSURANCE. CLEAN UP MUST BE PERFORMED DAILY, AND ALL HARDSCAPE ELEMENTS MUST BE WASHED FREE OF DIRT AND MUD ON FINAL CLEAN UP. CONSTRUCTION MUST OCCUR IN A TIMELY MANNER.
- LANDSCAPE PLANS AND DETAIL DRAWINGS ARE SCHEMATIC ONLY, DISCREPANCIES MAY EXIST, INCLUDING BUT NOT LIMITED TO BUILDING LOCATION, PROPERTY LINES, ANY DIMENSIONS SPECIFIED OR IMPLIED. THE CONTRACTOR WILL BE REQUIRED TO ADJUST PLANS AS NECESSARY TO RETAIN CONCEPT INTEGRITY. CONTRACTOR TO CONTACT LANDSCAPE ARCHITECT IF DISCREPANCIES EXIST.
- PLANT MATERIAL EXCAVATION. CONTRACTOR TO CALL BLUE STAKE AND MAKE REFERENCE TO DRAINAGE AND CIVIL PLANS BEFORE EXCAVATION FOR PLANT MATERIAL. ALL HOLES MUST ALLOW FOR A MINIMUM OF SIX (6) INCHES OF SPECIFIED PLANTING MIX BACKFILL MATERIAL ON ALL SIDES OF ROOT BALL FOR SHRUBS, AND 3X BALL DIAMETER FOR TREES.
- ALL WORK IS TO BE PERFORMED BY AN EXPERIENCED LANDSCAPE CONTRACTOR WITH NO LESS THAN FIVE(5) YEARS OF EXPERIENCE OF PROJECTS SIMILAR IN SCOPE AND SIZE.
- THE LANDSCAPE CONTRACTOR IS TO VERIFY THE LOCATION OF ALL UNDERGROUND UTILITIES PRIOR TO INSTALLATION. ALL UTILITIES MUST BE CLEARLY MARKED. BEFORE EXCAVATION ALL UTILITIES ARE TO BE POT-HOLED BY HAND OR EQUIPMENT IN A MANNER THAT DOES NOT CAUSE DAMAGE.

UTILITY SETBACKS:

WATER & SEWER LINES - 10 FEET GAS LINES - 4 FEET

- FIRE HYDRANTS- 5 FEET (LIMIT PLANT HEIGHT TO 8")
- CONTRACTOR TO VERIFY ALL PLANT LOCATIONS AND QUANTITY BEFORE INSTALLATION. IF DISCREPANCIES BETWEEN PLAN AND PLANTING SCHEDULE EXIST, PLAN TAKES PRECEDENCE OVER PLANTING SCHEDULE.
- ANY FIELD ADJUSTMENTS TO PLANT LOCATIONS SHALL BE MADE UNDER THE DIRECTION OF THE LANDSCAPE ARCHITECT OR OWNER'S REPRESENTATIVE. ANY PLANT LOCATION ADJUSTMENTS OR SUBSTITUTIONS SHALL BE APPROVED BY OWNER PRIOR TO ANY CHANGE FROM THE APPROVED LANDSCAPE PLAN.
- THE WARRANTY PERIOD UNLESS STATED OTHERWISE WILL BE ONE YEAR AFTER SUBSTANTIAL COMPLETION. ALL LANDSCAPE MATERIAL DAMAGED OR DEAD DUE TO INSTALLATION METHODS WILL BE REPLACED AT OWNER'S DISCRETION.
- **PLANTING** 10. TOP SOIL MUST BE A PREMIUM QUALITY DARK SANDY LOAM, FREE OF ROCKS, CLODS, ROOTS, AND PLANT MATTER. THE TOPSOIL WILL BE EVENLY SPREAD AND SMOOTH GRADED ON A CAREFULLY PREPARED SUBGRADE TO A DEPTH
- OF SIX (6) INCHES IN SHRUB AREAS, SIX (6) INCHES UNDER SOD AREAS. 11. ALL TREES IN TURF AREAS ARE TO BE PLANTED WITH SHREDDED CEDAR MULCH AT A DEPTH OF 4". NO WEED
- BARRIER FABRIC UNDER CEDAR MULCH. 12. STAKE ALL TREES WITH 6' TREATED WOOD POSTS. USE GUY WIRES WITH NON-STRETCH NYLON PROTECTIVE STRAPS AROUND TRUNK.
- 2 STAKES PER DECIDUOUS TREE
- 2 STAKES PER EVERGREEN TREE 13. ALL PLANTING PITS ARE TO BE CLEARED OF ALL ROCK, SUB BASE MATERIAL, AND DEBRIS. AMENDED TOPSOIL TO BE
- INSTALLED WITHIN. PER DETAIL. 14. NO FINAL GRADES CAUSING DRAINAGE AWAY FROM CURBS, DESIGNATED DRAINAGE INLETS, OR STAGNATE WATER WILL BE ALLOWED.
- 15. ALL TREES TO BE BALLED & BURLAP WITH SIZES AND SPECIES TRUE TO THE PLANT LEGEND.
- 16. TREE WRAPPING MAY BE USED TO PROTECT YOUNG TREES FROM WINTER DAMAGE. TREE WRAPS SHALL BE INSTALLED IN THE FALL. IF THE CONTRACTOR INSTALLS WRAPS FOR TREE PROTECTION IT SHALL BE THE
- CONTRACTORS RESPONSIBILITY TO PROMPTLY REMOVE WRAPS THE FOLLOWING SPRING. 17. PLANT SUBSTITUTIONS SHALL BE REQUESTED IN WRITING AND APPROVED BY THE OWNER PRIOR TO CONSTRUCTION. 18. ALL PLANTING MATERIAL SHALL BE APPROVED AND INSPECTED BY OWNER'S REPRESENTATIVE PRIOR TO
- INSTALLATION. TREE AND SHRUB TAGS SHALL BE LEFT ON PLANTS UNTIL INSPECTED. 19. LANDSCAPE CONTRACTOR IS TO COORDINATE SCHEDULE IN A MANNER THAT ALLOWS PLANTING MATERIAL TO BE INSTALLED IN A TIMELY MANNER. IF TEMPORARY STORAGE IS NECESSARY, CONTRACTOR SHALL PROVIDE

ADEQUATE PROTECTION FROM WEATHER AND HEAT. REGULAR WATERING IS REQUIRED UNTIL INSTALLATION.

- 20. NO OPEN PLANTING PITS SHALL BE LEFT OPEN OR UNATTENDED. 21. THE PLANT SCHEDULE IS FOR REFERENCE ONLY, CONTRACTOR TO VERIFY ALL QUANTITIES AND LOCATIONS SHOWN ON THE LANDSCAPE PLAN.
- 22. ALL PLANTING MATERIAL SHALL COMPLY TO THE STANDARDS OF ANSI FOR NURSERY STOCK.

GROUND COVERS/MULCHES

- 23. THE FINAL GRADE IN SOD AREAS ARE TO BE 1" BELOW ANY PAVED SURFACE OR EDGING IN ORDER TO RETAIN SOD. 24. INSTALL PLASTIC COMPOSITE EDGING BETWEEN SOD/NATIVE GRASS & PLANTING BEDS.
- 25. NO EDGING IS TO BE PLACED BETWEEN SOD & NATIVE GRASS AREAS. CONTRACTOR TO CUT SOD TO REFLECT THE PLANS. EDGING TO BE CLEAN, AVOID TEARS AND JAGGED CUTTING.
- 26. THE FINAL GRADE IN ALL MULCHED AREAS ARE TO BE 3" BELOW ANY PAVED SURFACE OR EDGING IN ORDER TO RETAIN MULCH.
- 27. ROCK MULCH AREAS ARE TO HAVE WEED BARRIER FABRIC INSTALLED UNDERNEATH. DEPTH OF ROCK MULCH SHALL BE 3" MINIMUM & OBTAINED FROM A LOCAL SUPPLIER, OWNER TO APPROVE PROVIDED SAMPLE BEFORE
- 28. WEED BARRIER FABRIC IS TO BE POLYSPUN 300, DEWITT PRO 5.5 OR APPROVED EQUAL. SECURE FABRIC WITH COMMERCIAL GRADE FABRIC PINS, 6" LONG BY 1" WIDE. LAY FABRIC PARALLEL TO FINAL GRADE WITH 6" OVERLAPS **BETWEEN SECTIONS.**
- 29. CEDAR MULCH AREAS DO NOT REQUIRE WEED BARRIER FABRIC. DEPTH OF CEDAR MULCH SHALL BE 3" MINIMUM & OBTAINED FROM A LOCAL SUPPLIER, OWNER TO APPROVE PROVIDED SAMPLE BEFORE INSTALLATION.
- 30. SOD MUST BE PREMIUM QUALITY, ULTRA GREEN, EVENLY CUT, ESTABLISHED, HEALTHY, WEED AND DISEASE FREE, AND FROM AN APPROVED SOURCE. SOD MUST BE DELIVERED AND LAID IMMEDIATELY AFTER CUTTING. SOD MUST BE LAID WITHOUT GAPS BETWEEN PIECES ON A CAREFULLY PREPARED TOPSOIL LAYER. THE LAID SOD MUST BE IMMEDIATELY WATERED AFTER INSTALLATION. ANY BURNED AREAS WILL REQUIRE REPLACEMENT. ADJUST SPRINKLER SYSTEM TO ASSURE HEALTHY GREEN SURVIVAL OF THE SOD WITHOUT WATER WASTE
- 31. REFER TO LANDSCAPE PLAN AND SCHEDULE FOR ALL TURF AREAS. TURF SHALL BE AN IMPROVED KENTUCKY BLUEGRASS VARIETY WITH AT LEAST THREE VARIETIES.
- 32. CONTRACTOR TO SUBMIT PRODUCT INFORMATION TO OWNER'S REPRESENTATIVE PRIOR TO INSTALLATION.
- 33. LAY TURF WITHIN 24 HOURS OF DELIVERY, PRIOR TO INSTALLATION THE CONTRACTOR SHALL HAVE THE IRRIGATION
- 34. TURF SHALL BE FREE OF NOXIOUS WEEDS AND IN HEALTHY CONDITION. ALL DEBRIS 1 INCH OR GREATER SHALL BE REMOVED. 35. ON FINAL GRADES 3:1 OR GREATER, CONTRACTOR TO STABILIZE ROLLS WITH WOOD PEGS OR SOD STAPLES. TURF
- TO BE LAID PARALLEL TO SLOPE, STAGGER ROLLS WITH NO OVERLAPPING OR GAPS. 36. AFTER TURF IS INSTALLED, ALL AREAS ARE TO BE IMMEDIATELY IRRIGATED.
- 37. CONTRACTOR TO ERECT FENCING OR WARNING TAP AROUND TURF AREAS TO DETER FOOT TRAFFIC DURING THE
- ENTIRETY OF THE WARRANTY PERIOD OR UNTIL SOD IS COMPLETELY ESTABLISHED.
- SOIL PREPARATION & EROSION CONTROL
- 38. AREAS RECEIVING PLANT MATERIAL SHALL BE AMENDED WITH GOOD GRADE TOPSOIL 39. TOP DRESS ALL SHRUB BED AREAS AND OTHER AREAS LABELED ROCK MULCH WITH 4" DEPTH SIZE CRUSHED ROCK
- OVER DEWITT PRO-4 WEED BARRIER FABRIC. 40. FABRIC SHALL BE INSTALLED AFTER PRE-EMERGENT HAS BEEN APPLIED.
- 41. COMPOST SHALL BE SPREAD AT A RATE OF 3 CY / 1000 SQ FT IN PLANTING BEDS AND SOD AREAS, 2 CY / 1000 SQ FT IN
- SEEDED AREAS. TILL COMPOST INTO TOPSOIL AT A DEPTH OF 6 INCHES.
- 42. CLEAR SOIL OF ALL ROCK, BRANCHES OR MISC. DEBRIS OVER 1 INCH IN SIZE. FERTILIZER
- 43. SOD COMMERCIAL GRADE (NPK: 18-46-0) APPLICATION RATE: 10LBS / 1000 SQ FT
- SEED COMMERCIAL GRADE (NPK:18-46-0) APPLICATION RATE: 10LBS / 1000 SQ FT
- PLANTS BIOSOLE FORTE (NPK: 7-2-1)
- 46. ALL AREAS DISTURBED DURING CONSTRUCTION SHALL BE SEEDED UNLESS STATED OTHERWISE.
- 47. APPLY 4" INCHES OF NATIVE TOPSOIL FROM THE LOCAL AREA. NO SUBSURFACE SOIL SHALL BE USED. 48. IT IS IMPORTANT TO SUE SOIL THAT HAS MINIMAL AMOUNT OF WEED SEED.
- 49. SEEDING SHALL TAKE PLACE IN LATE SUMMER OR FALL.
- 50. ALL SEEDED AREAS SHALL BE RIPPED AND TILLED AT A DEPTH OF 4" WITH FINAL GRADE ESTABLISHED PRIOR TO
- 51. CONTRACTOR TO USE A BRILLION TYPE SEEDER WITH ROWS NOT EXCEEDING 8 INCHES. IN AREAS WHERE
- EQUIPMENT IS NOT PRACTICAL, HAND BROADCAST AT TWICE THE RATE. 52. NO SEEDING SHALL OCCUR DURING TIMES OF EXCESSIVE WIND OR FREEZING TEMPERATURES.
- 53. STRAW MULCH OR HYDRO-MULCH NEEDS TO BE INSTALLED WITHIN 24 HOURS AFTER SEEDING. STRAW MULCH IS TO BE SPREAD AT A RATE OF 2 TONS/ACRE. HYDRO-MULCH IS TO BE SPREAD A T A RATE OF 1 TON/ACRE UNIFORMLY. NO OPEN OR BARE AREAS SHALL BE ALLOWED.
- 54. SEED SHALL BE 95% PURE LIVE SEED:
- 55. NATIVE SEED MIXTURE: APPLY SEED AT A RATE 20LBS / ACRE BY HYDRO-SEEDING

GENERAL IRRIGATION NOTES:

- THE DRAWINGS ARE TO BE CONSIDERED DIAGRAMMATIC, AS IT MAY NOT BE POSSIBLE TO ACCURATELY DEPICT THE EXACT LOCATIONS FOR ALL MATERIAL, OR ANTICIPATE THOSE IN-FIELD VARIATIONS WHICH MAY REQUIRE ADJUSTMENT ON SITE. THE INSTALLER SHALL BE EXPECTED TO MAKE MINOR MODIFICATIONS WHICH MAY BE NECESSARY TO MAINTAIN COMPLETE AND ACCURATE COVERAGE, WITHOUT DEVIATION FROM THE DESIGN CONCEPTS OR INTENT. THE FINAL LOCATIONS OF ALL MAJOR EQUIPMENT, SUCH AS CONTROLLERS, VALVES, SUPPLY CONNECTIONS, MAINLINES, ETC. SHALL BE DETERMINED IN THE FIELD. USING THE DRAWINGS AS A GUIDE, AND APPROVED PRIOR TO INSTALLATION.
- ALL WORK SHALL BE DONE IN ACCORDANCE WITH PREVAILING CODES AND REGULATIONS. ALTHOUGH DUE DILIGENCE HAS BE EXERCISED IN THE PREPARATION OF THE DOCUMENTS TO AVOID CONFLICTS. THE RESPONSIBILITY FOR VERIFICATION AND CONFORMANCE TO THE PARTICULAR CODES FOR THIS LOCATION SHALL REMAIN SOLELY THAT OF THE INSTALLER, THE INSTALLER SHALL OBTAIN ANY NECESSARY LOCATES, PERMITS AND INSPECTIONS.
- ALL WORK SHALL BE CLOSELY COORDINATED WITH THAT OF OTHER TRADES, IN ORDER TO AVOID CONFLICTS. THE INSTALLATION SHALL BE COORDINATED WITH ALL NEW AND EXISTING IMPROVEMENTS, AND WITH THE ACTUAL BEDLINES, SOD LIMITS AND PLANT LOCATIONS.
- ALL MATERIAL AND LABOR REQUIRED TO PROVIDE A COMPLETE, OPERATIONAL, AND FULLY GUARANTEED SYSTEM SHALL BE CONSIDERED PART OF THE WORK, WHETHER OR NOT THEY ARE SPECIFICALLY INDICATED IN THE DOCUMENTS. LANDSCAPE CONTRACTOR SHALL CHANGE NOZZLES AS NECESSARY TO ASSURE PROPERTY COVERAGE, TAKING INTO CONSIDERATION ON SITE OBSTRUCTIONS, PREVAILING WINDS, ETC. ANY MATERIAL NECESSARY FOR COMPLETE COVERAGE SHALL BE ADDED BY THE LANDSCAPE CONTRACTOR AT NO EXTRA COST TO THE OWNER (I.E. HEADS, PIPE, FITTINGS).
- UNLESS SPECIFICALLY STATED IN THE DOCUMENTS, ALL MAINLINE PIPING AND WIRING PASSING UNDER PAVED SURFACES SHALL BE SLEEVED WITH SCH. 40 PVC SIZED TWO SIZES LARGER THAN THE CONTAINED PIPE, OR 1" OR LARGER AS NEEDED FOR CONTROL WIRING. LATERAL PIPING PASSING UNDER TRAFFIC-BEARING PAVEMENT OF ANY WIDTH. OR UNDER SIDEWALKS 4' IN WIDTH OR GREATER, SHALL BE SLEEVED IN A SIMILAR MANNER. IT SHALL BE ASSUMED THAT ALL SLEEVING IS TO BE PART OF THIS WORK. UNLESS SPECIFICALLY EXCEPTED IN THE DOCUMENTS. ANY NEEDED SLEEVES WHICH ARE UNUSABLE OR CANNOT BE FOUND SHALL BE REPORTED IMMEDIATELY TO THE PROJECT MANAGER. ROADWAY/DRIVEWAY SLEEVES ARE CALLED OUT ON THIS DRAWING. ALL SIDEWALK SLEEVES ARE NOT SHOWN, BUT ARE UNDERSTOOD.
- CONTROL WIRING SHALL BE ROUTED WITH THE MAINLINE WHEREVER POSSIBLE.
- ALL HEADS SHALL BE OF THE PROPER TYPE FOR THE PLANT MATERIAL WHERE LOCATED, AND SHALL BE INSTALLED IN THE PRESCRIBED MANNER, PLUMB, AND WITH THE PROPER HEIGHT WITH RESPECT TO GRADE AND PLANT HEIGHT. ALL HEADS AND OTHER EQUIPMENT SHALL BE INSTALLED WITH ADEQUATE AND UNIFORM CLEARANCES FORM ALL PAVING, CURBS, SIDEWALKS, WALLS, AND OTHER OBSTACLES, SO THAT DAMAGE TO EQUIPMENT DOES NOT OCCUR DURING LANDSCAPE MAINTENANCE OPERATIONS. ALL SPRINKLERS SHALL BE ADJUSTED TO OBTAIN MAXIMUM COVERAGE OF PLANT MATERIAL. WHILE MINIMIZING OVERSPRAY ONTO WINDOWS OR WALLS, OR OTHER IMPERVIOUS SURFACES, PARTICULARLY WOODWORK AND/OR TRIM. THE INSTALLER SHALL UTILIZE SUITABLE PRESSURE-COMPENSTING SCREENS OR ADJUSTABLE-ARC NOZZLES WHERE REQUIRED TO ACHIEVE MAXIMUM COVERAGE CONTROL.
- EACH CONTROLLER SHALL REQUIRE A STANDARD 120-VAC POWER FEED, WHICH SHALL BE COORDINATED AND HOOKED UP BY THE INSTALLER OR HIS DESIGNATED ELECTRICIAN. A 3-WIRE POWER INPUT SURGE ARRESTOR SHALL BE PROVIDED ON THE POWER FEED, AND A DEDICATED GROUND ROD OR RODS SHALL BE INSTALLED, WHICH PROVIDE A RESISTANCE OF NO GREATER THAN 10 OHMS TO EARTH.
- LATERAL LINES SHALL BE NO SMALLER THAN 1". PIPES SHALL CARRY NO MORE THAN THE FOLLOWING.

1" PIPE MAX.	12GPM
1 ¹ " PIPE MAX.	22GPM
1 ½" PIPE MAX.	30GPM
2" PIPE MAX.	50GPM
2 ½" PIPE MAX.	75GPM
3" PIPE MAX.	110GPM
4" PIPE MAX.	190GPM

- 10. INSTALL MANUAL DRAINS AT ALL LOW POINTS ON THE MAINLINE PIPE WITH ADEQUATELY SIZED SUMPS.
- 11. THE INSTALLER SHALL BE EXPECTED TO BE FAMILIAR WITH AND FOLLOW THE INSTRUCTIONS CONTAINED HEREIN, ON THE DRAWINGS, IN THE CONSTRUCTION DETAILS, AND IN THE WRITTEN SPECIFICATIONS. SHOULD A CONFLICT BE DISCOVERED WITHIN THE DOCUMENTS, IMMEDIATELY NOTIFY THE PROJECT MANAGER AND REQUEST CLARIFICATION.
- PROVIDE A REPRODUCIBLE IRRIGATION PLAN TO ARCHITECT AND OWNER SHOWING ALL PIPE, HEADS, VALVES, DRAINS, CLOCKS, ETC. AFTER CONSTRUCTION. PROVIDE INSTRUCTIONS TO MAINTENANCE PERSONNEL FOR WINTERIZATION. PROVIDE A COLOR CODED PLAN AT THE CONTROLLER LOCATION.

PLANT SCHEDULE

PLANT SCH	<u>EDULE</u>				
TREES	CODE	QTY	BOTANICAL NAME	COMMON NAME	CONT
	ACE AMU	36	Acer ginnala	Amur Maple (Multi-trunk)	B&B
	ACE BA2	10	Acer ginnala `Flame`	Flame Amur Maple	B&B
•	AG	8	Acer tataricum 'GarAnn'	Hot Wings® Tatarian Maple	B&B
	AA	6	Amelanchier alnifolia 'Altaglow'	Altaglow Serviceberry	B & B
	AME GRA	3	Amelanchier x grandiflora `Autumn Brilliance` Multi Stem	`Autumn Brilliance` Serviceberry	5 gal
	BET FAR	21	Betula platyphylla `Fargo` TM	Dakota Pinnacle Asian White Birch	B&B
•	CAT SPE	11	Catalpa speciosa	Northern Catalpa	B&B
	CEL OCC	3	Celtis occidentalis	Common Hackberry	B&B
	CL2	24	Cercocarpus ledifolius	Curl-leaf Mountain Mahogany	B&B
	СС	15	Cotinus obovatus 'Northstar' 18' T x15'W	Cotton Candy™ American Smoke Tree	B&B
2	FH	8	Forestiera neomexicana 'Happy Boy'	Happy Boy New Mexico Privet	B&B
	MAL SPR	11	Malus x `Spring Snow`	Spring Snow Crab Apple	B&B
	PRU CAN	17	Prunus virginiana `Canada Red`	Canada Red Chokecherry	B&B
	TC	2	Tilia cordata 'Corzam'	Corinthian® Littleleaf Linden	B & B
EVERGREEN TREES	CODE	QTY	BOTANICAL NAME	COMMON NAME	CONT
	ABI COR	2	Abies concolor	White Fir	B&B
	JS	14	Juniperus scopulorum	Rocky Mountain Juniper	B&B
	JUN B15	40	Juniperus Scopulorum `Blue Arrow`	Blue Arrow Juniper	B&B
The state of the s	PIC ENG	2	Picea englemannii	Englemann Spruce	B&B
Marine Marine Company of the Company	PIC BAB	15	Picea pungens glauca `Baby Blue Eyes` TM	Baby Blue Eyes Spruce	B & B
	PIC BAK	8	Picea pungens glauca `Bakeri`	Bakeri Blue Spruce	B&B
	PSE BLU	1	Pseudotsuga menziesii `Blue Bird`	Blue Bird Douglas Fir	B & B
<u>SHRUBS</u>	CODE	QTY	BOTANICAL NAME	COMMON NAME	CONT
	AME STA	16	Amelanchier alnifolia `Standing Ovation` TM	Serviceberry	5 gal
	AW	42	Artemisia absinthium	Wormwood	2 gal
	CAR DAR	67	Caryopteris x clandonensis `Dark Knight`	Blue Mist Shrub	1 gal
	CM	10	Chamaebatiaria millefolium	Fernbush	5 gal
	CR	13	Chrysothamnus nauseosus	Rubber Rabbitbrush	5 gal
	CA VAR	31	Cornus alba `Variegata`	Dwarf Variegated Dogwood	5 gal
	cs	7	Cotinus x 'Dusky Maiden' 6-8' x 6-8'	Dusky Maiden Smoke Tree	5 gal
\odot	JB	54	Juniperus sabina 'Blue Forest'	Blue Forest Juniper	5 gal
	PA	3	Pennisetum alopecuroides `Desert Plains` 42"h x 3`w	Desert Plains Fountian Grass	1 gal
	PHY DI2	36	Physocarpus opulifolius `Diablo`	Diablo Ninebark	5 gal
	PP	92	Prunus besseyi 'P011S'	Pawnee Buttes® Sand Cherry	2 gal
	PT	19	Purshia tridentata	Antelope Bitterbrush	2 gal
	SOR SOR	143	Sorbaria sorbifolia	Ash Leaf Spirea	5 gal
	SPI WAT	210	Spiraea japonica `Anthony Waterer`	Japanese Spirea	5 gal
	SYM ALB	27	Symphoricarpos albus	Common White Snowberry	5 gal
	SYR MEY	94	Syringa meyeri `Palibin`	Dwarf Korean Lilac	5 gal

EVERGREEN SHRUBS	CODE	<u>QIT</u>	BUTANICAL NAME	COMMON NAME	CONT
	PIC NID	18	Picea abies 'Nidiformis'	Nest Spruce	5 gal
	PIN SLO	75	Pinus mugo `Slowmound`	Mugo Pine	5 gal
	PS	12	Pinus strobus `Blue Shag` 4`h x 4`w	Blue Shag White Pine	5 gal
PERENNIALS	CODE	<u>QTY</u>	BOTANICAL NAME	COMMON NAME	CONT
	AC	18	Achillea clavennae	Silvery Yarrow	2 gal
	ARC UVA	3	Arctostaphylos uva-ursi	Kinnikinnick	1 gal
۵	AL	14	Artemisia ludoviciana	White Sagebrush	2 gal
	CER TOM	35	Cerastium tomentosum	Snow In Summer	1 gal
\odot	DA	124	Dianthus deltoides 'Albus'	White Maiden Pink	2 gal
	ECH PUR	66	Echinacea purpurea	Purple Coneflower	1 gal
	LAV HI2	87	Lavandula angustifolia `Hidcote Blue`	Hidcote Blue Lavender	1 gal
	MON MAR	96	Monarda didyma `Marshall`s Delight`	Marshall`s Delight Bee Balm	1 gal
	PS EB	432	Phlox subulata `Emerald Blue`	Emerald Blue Moss Phlox	1 gal
\odot	RUD GO2	30	Rudbeckia fulgida sullivantii `Goldsturm`	Black-eyed Susan	1 gal
	SB2	12	Stachys byzantina	Lamb's Ear	2 gal
	TPA	17	Thymus praecox arcticus `Coccineus`	Red Creeping Thyme	1 gal
GRASSES	CODE	QTY	BOTANICAL NAME	COMMON NAME	CONT
	CAL KAR	12	Calamagrostis x acutiflora `Karl Foerster`	Feather Reed Grass	1 gal
\odot	ERA SPE	370	Eragrostis spectabilis	Purple Love Grass	1 gal
\odot	PAN SHA	15	Panicum virgatum `Shenendoah`	Burgundy Switch Grass	1 gal
GROUND COVERS	CODE	QTY	BOTANICAL NAME	COMMON NAME	CONT
	NAT N16	183,139 sf	Native Grass & Wildflower Mix	Native Grass & Wildflower Mix	Hydrose
	POA PRA	15,657 sf	Poa pratensis	Kentucky Bluegrass	sod
MULCH	CODE	<u>QTY</u>	BOTANICAL NAME	COMMON NAME	CONT
	MUL M10	25,913 sf	4" Wood Mulch	4" Wood Mulch	Mulch
	GRA GR7	27,047 sf	Decorative Landscape Rock		Mulch
		141	Landscape Boulder	3-4' Boulder	

BOTANICAL NAME

QTY

COMMON NAME

CONT

EVERGREEN SHRUBS CODE

2" Cal

CAL

SIZE

6`-7` H

6`-7` H

ATIVE SEED MIX		
COMMON NAME	SCIENTIFIC NAME	(LBS/ACRE)
WHEATGRASS, SIBERIAN	AGROPYRON FRAGILE	2 LBS
WHEATGRASS, CRESTED	AGROPYRON CRISTATUM	2 LBS
NEEDLEGRASS, COLUMBIA	ACHNATHERUM NELSONII	2 LBS
FESCUE, SHEEP	BOUTELOUA CURTIPENDULA	0.5 LBS
ALFALFA, YELLOW	MEDICAGO SATIVA FALCATA	1 LBS
KOCHIA, FORAGE-SNOWSTORM	KOCHIA PROSTRATA GRISEA	1 LBS
FLAX, BLUE	LINUM PERENNE	0.5 LBS
BEEPLANT, ROCKY MOUNTAIN	CLEOME SERRULATA	1 LBS
GLOBEMALLOW, SCARLET	SPHAERACEA COCCINEA	1 LBS
PENSTEMON, FIRECRACKER	PENSTEMON EATONII	0.25 LBS
YARROW, WESTERN	ACHILLEA MILLEFOLIUM	0.25 LBS
SUNFLOWER, ANNUAL	HELIANTHUS ANNUUS	1 LBS
BITTERBRUSH, ANTELOPE	PURSHIA TRIDENTATA	1 LBS
WINTERFAT	CERATOIDES LANATA	2 LBS
SALTBUSH, FOURWING	ATRIPLEX CANESCENS	2 LBS
SALTBRUSH, SHADSCALE	ATRIPLEX CONFERTIFOLIA	2 LBS
SAGEBRUSH, WYOMING BIG	ARTEMISIA TRIDENTATA WYOMINGENSIS	0.5 LBS

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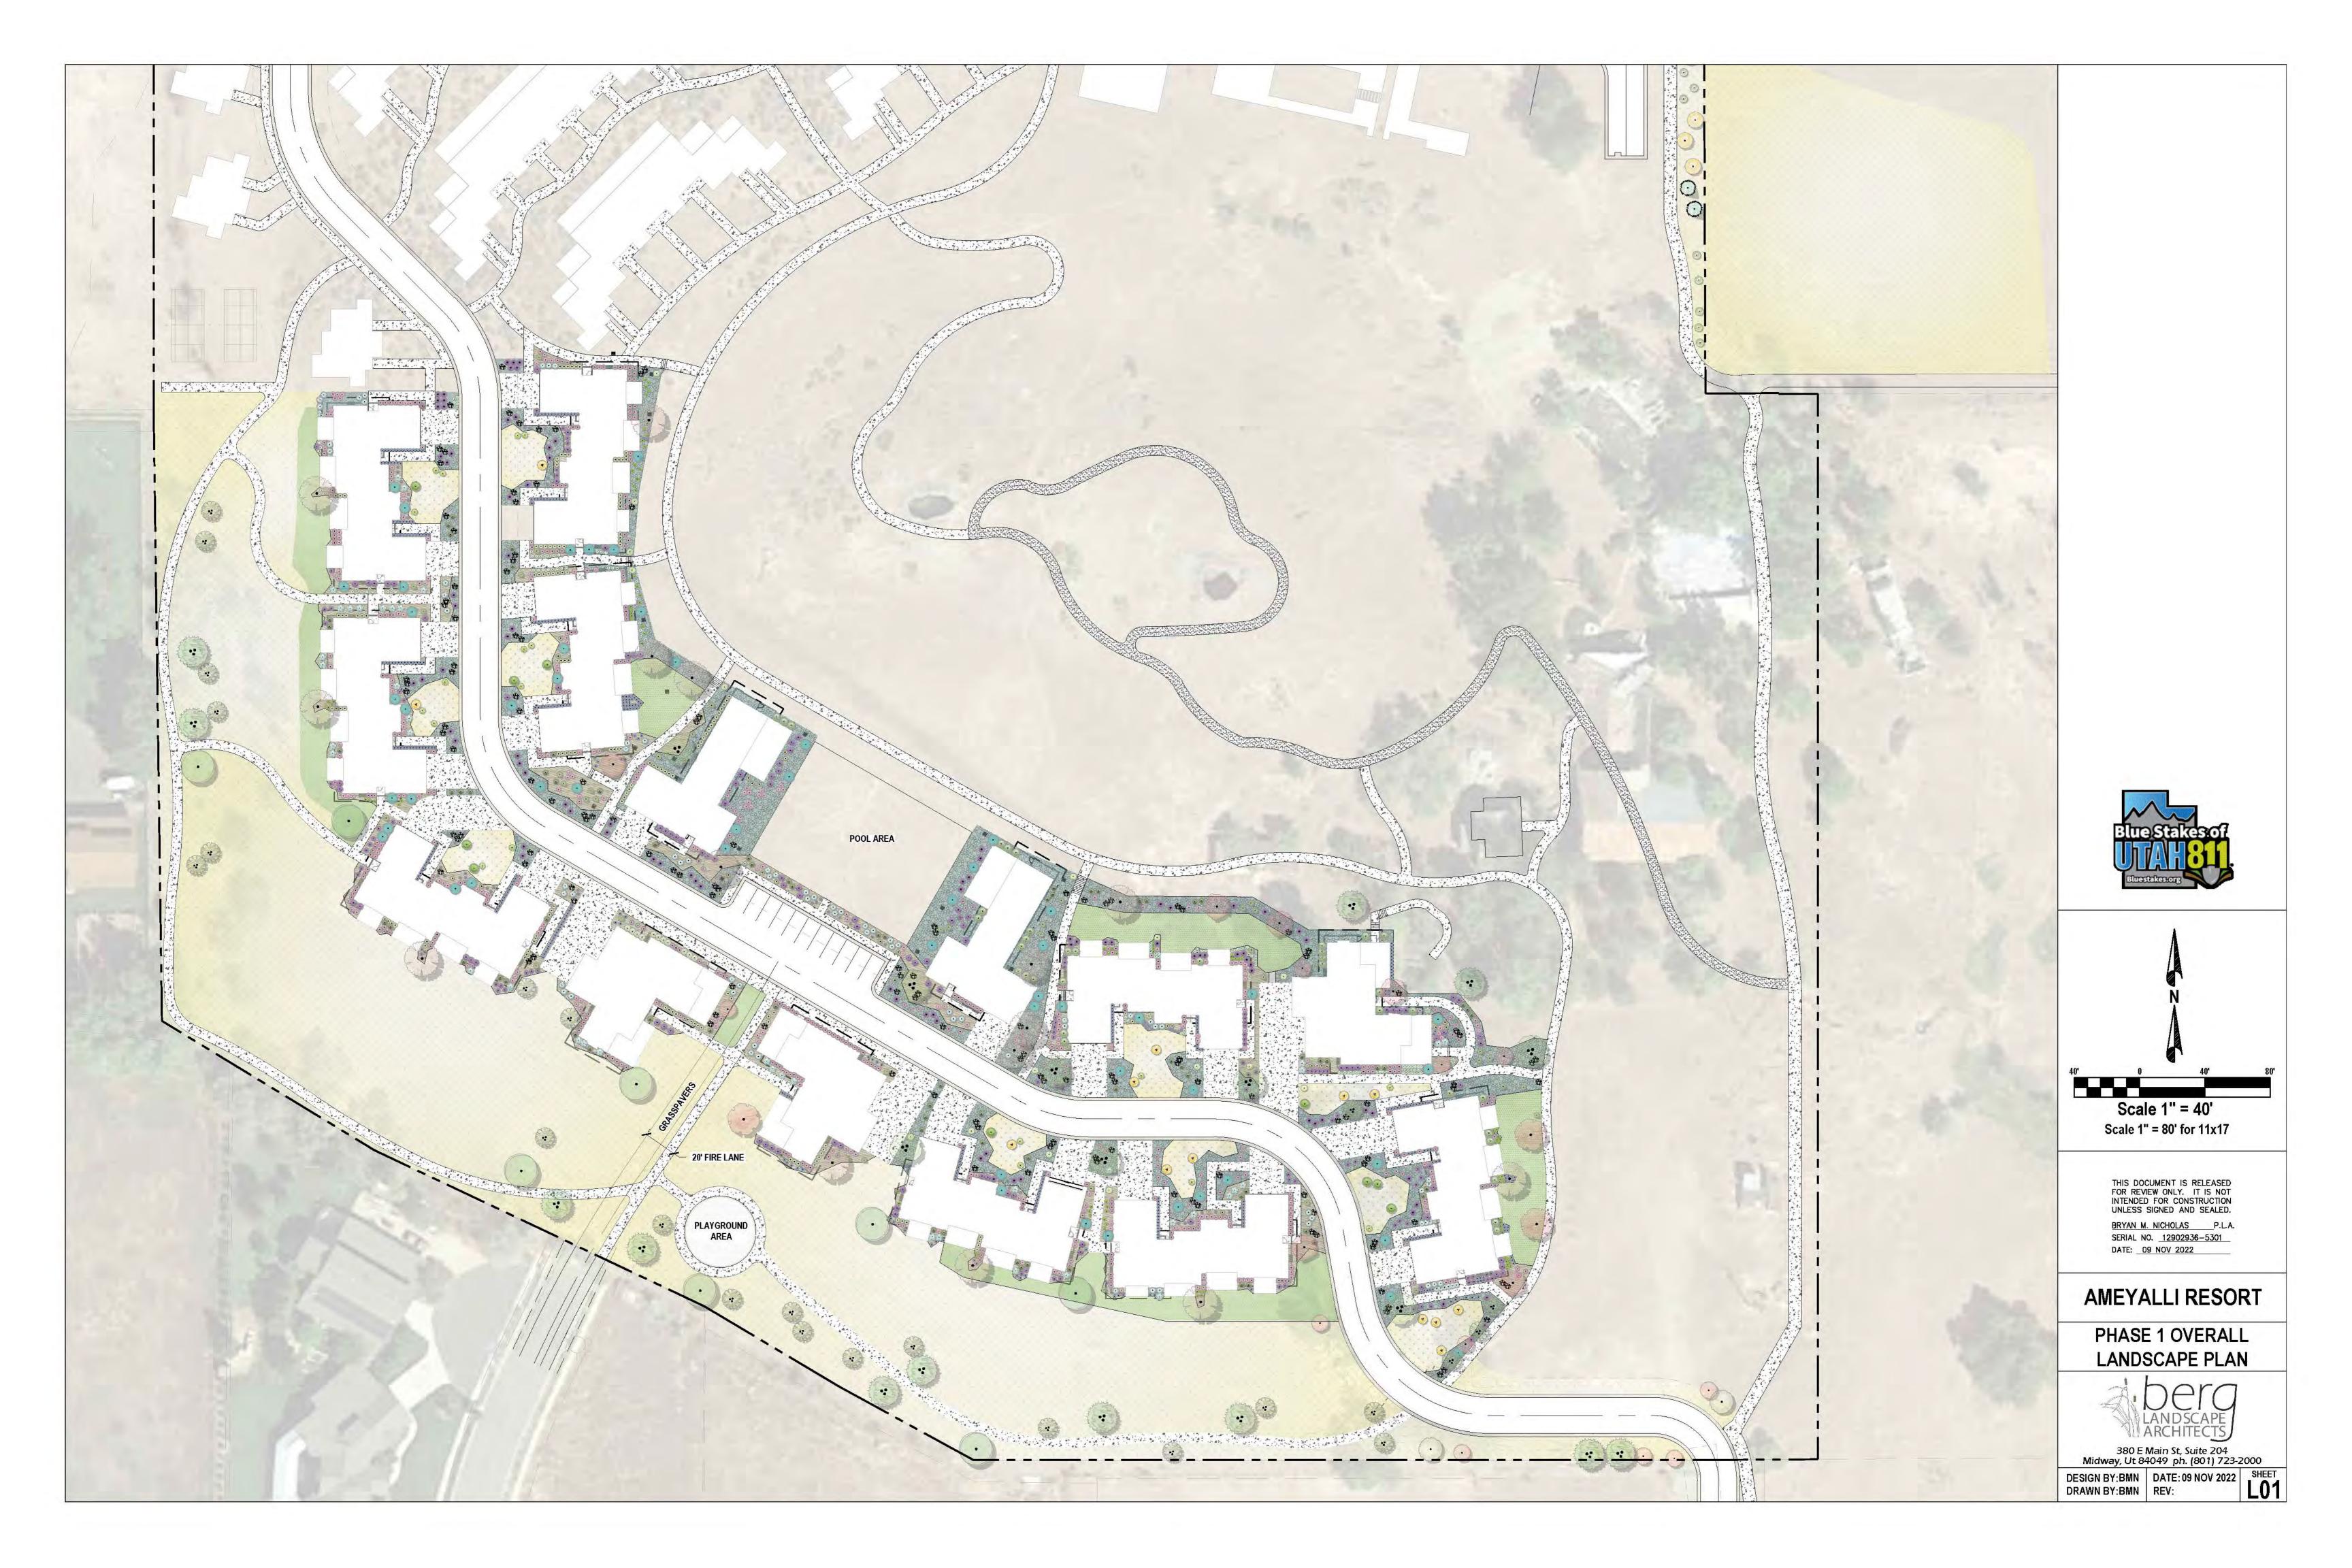
AMEYALLI RESORT

LANDSCAPE NOTES & PLANT SCHEDULE





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PLAN 01/L03

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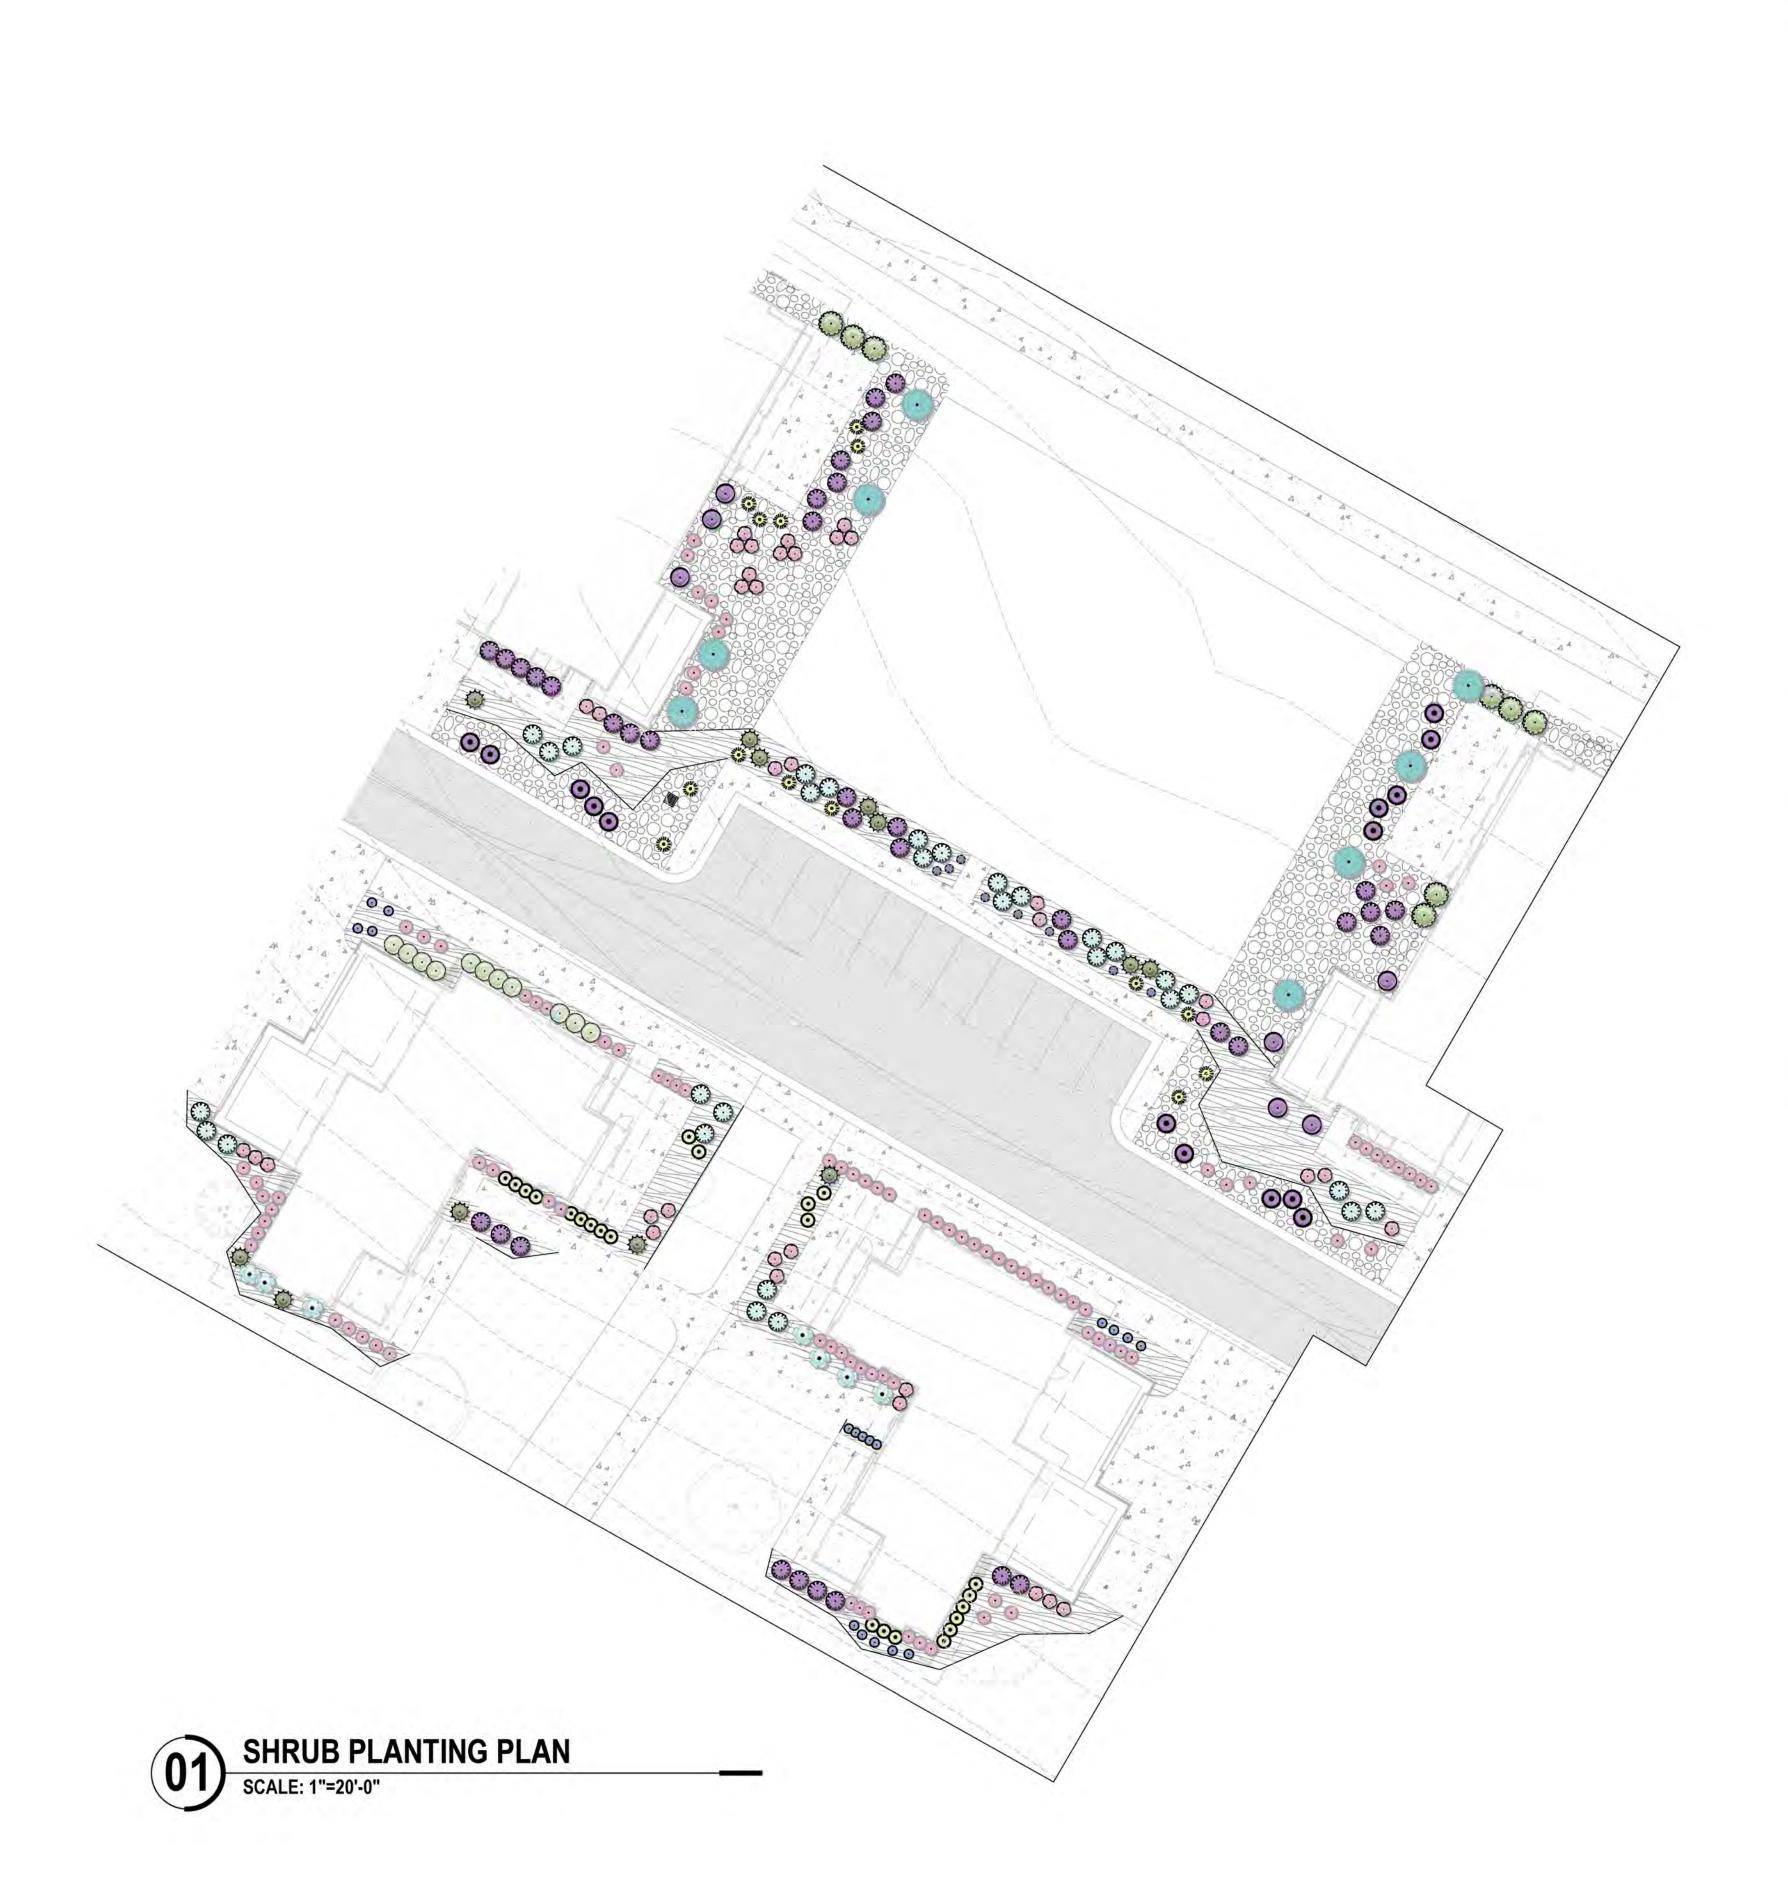
PHASE 1 TREE PLANTING PLANS





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SHRUBS	CODE	BOTANICAL NAME	COMMON NAME
0	AME STA	Amelanchier alnifolia `Standing Ovation` TM	Serviceberry
3	AW	Artemisia absinthium	Wormwood
0	CAR DAR	Caryopteris x clandonensis 'Dark Knight'	Blue Mist Shrub
(СМ	Chamaebatiaria millefolium	Fernbush
•	CR	Chrysothamnus nauseosus	Rubber Rabbitbrush
()	CA VAR	Cornus alba `Variegata`	Dwarf Variegated Dogwood
	cs	Cotinus x 'Dusky Maiden' 6-8' x 6-8'	Dusky Maiden Smoke Tree
0	JB	Juniperus sabina 'Blue Forest'	Blue Forest Juniper
8	PA	Pennisetum alopecuroides 'Desert Plains' 42"h x 3'w	Desert Plains Fountian Grass
0	PHY DI2	Physocarpus opulifolius 'Diablo'	Diablo Ninebark
•	PP	Prunus besseyi 'P011S'	Pawnee Buttes® Sand Cherry
0	PT	Purshia tridentata	Antelope Bitterbrush
•	SOR SOR	Sorbaria sorbifolia	Ash Leaf Spirea
	SPI WAT	Spiraea japonica `Anthony Waterer`	Japanese Spirea
0	SYM ALB	Symphoricarpos albus	Common White Snowberry
0	SYR MEY	Syringa meyeri 'Palibin'	Dwarf Korean Lilac
EVERGREEN SHRUBS	CODE	BOTANICAL NAME	COMMON NAME
0	PIC NID	Picea abies 'Nidiformis'	Nest Spruce
•	PIN SLO	Pinus mugo `Slowmound`	Mugo Pine
(a)	PS	Pinus strobus `Blue Shag` 4'h x 4'w	Blue Shag White Pine
PERENNIALS	CODE	BOTANICAL NAME	COMMON NAME
0	AC	Achillea clavennae	Silvery Yarrow
0	ARC UVA	Arctostaphylos uva-ursi	Kinnikinnick
(a)	AL	Artemisia ludoviciana	White Sagebrush
0	CER TOM	Cerastium tomentosum	Snow In Summer
0	DA	Dianthus deltoides 'Albus'	White Maiden Pink
	ECH PUR	Echinacea purpurea	Purple Coneflower
0	LAV HI2	Lavandula angustifolia 'Hidcote Blue'	Hidcote Blue Lavender
0	MON MAR	Monarda didyma `Marshall`s Delight`	Marshall's Delight Bee Balm
0	PS EB	Phlox subulata 'Emerald Blue'	Emerald Blue Moss Phlox
and the second	RUD GO2	Rudbeckia fulgida sullivantii 'Goldsturm'	Black-eyed Susan
0	SB2	Stachys byzantina	Lamb's Ear
*	TPA	Thymus praecox arcticus 'Coccineus'	Red Creeping Thyme
GRASSES	CODE	BOTANICAL NAME	COMMON NAME
•	CAL KAR	Calamagrostis x acutiflora 'Karl Foerster'	Feather Reed Grass
0	ERA SPE	Eragrostis spectabilis	Purple Love Grass
	PAN SHA	Panicum virgatum `Shenendoah`	Burgundy Switch Grass

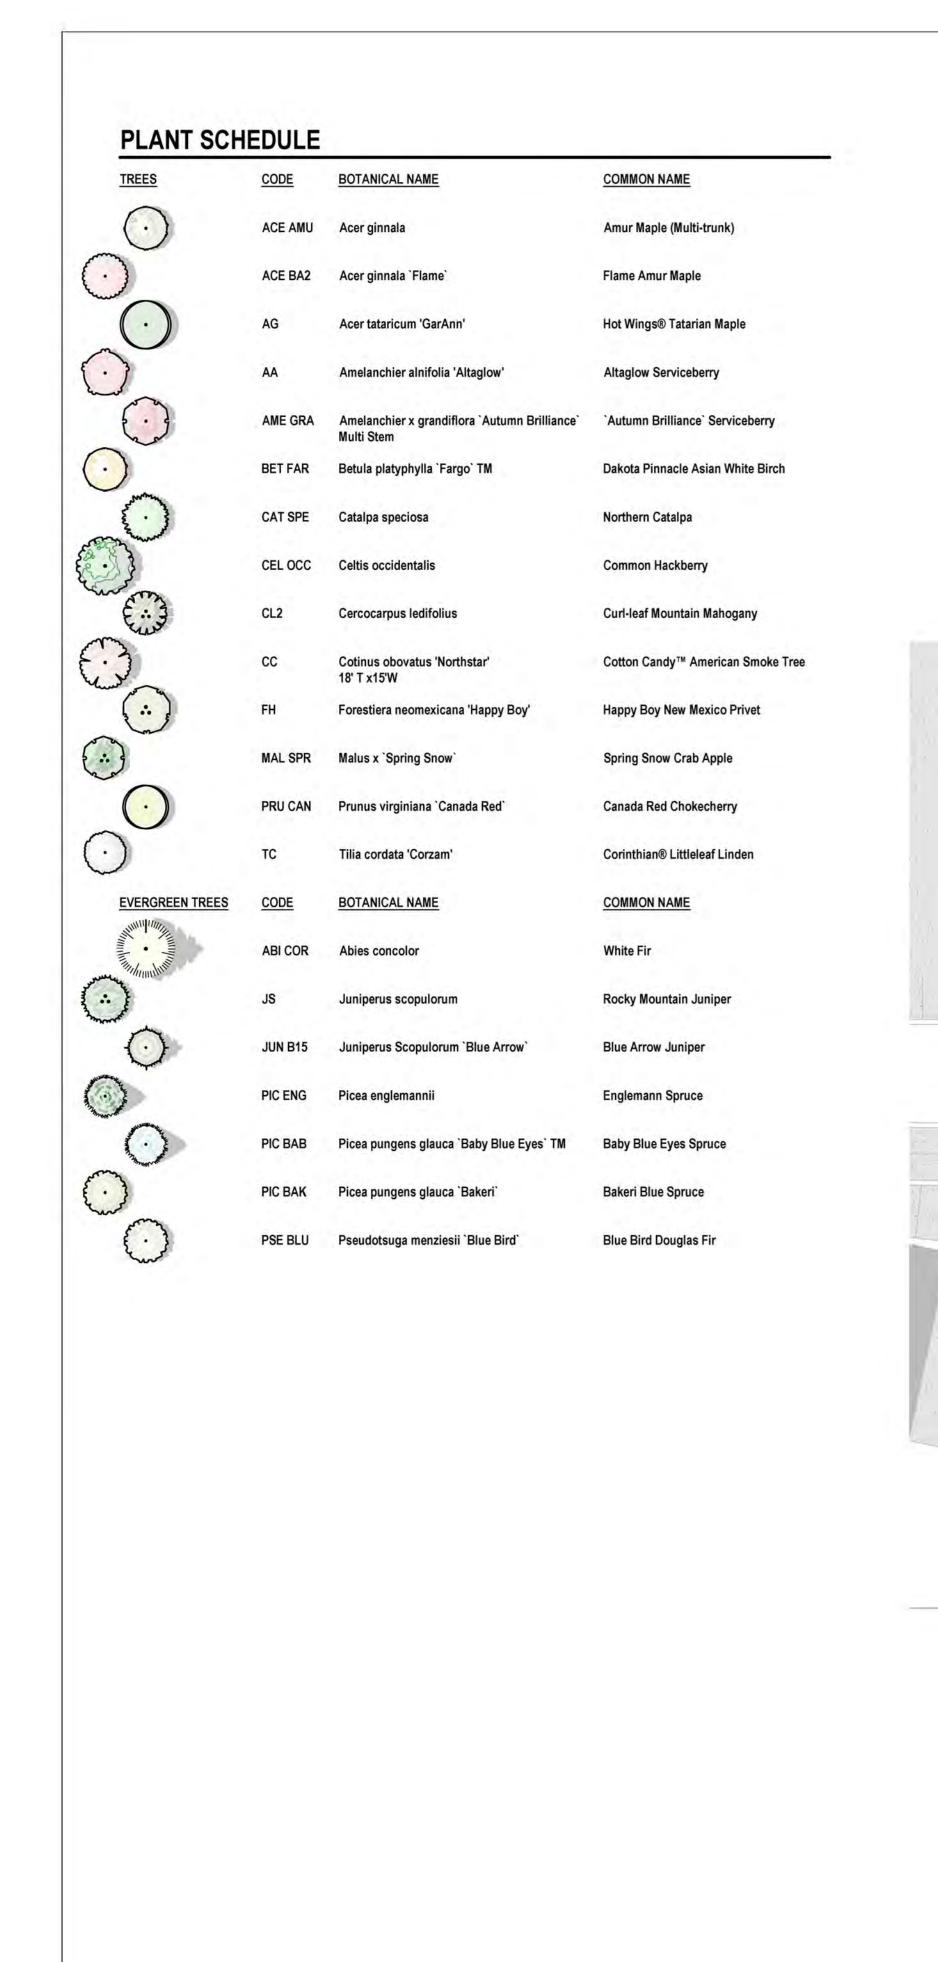

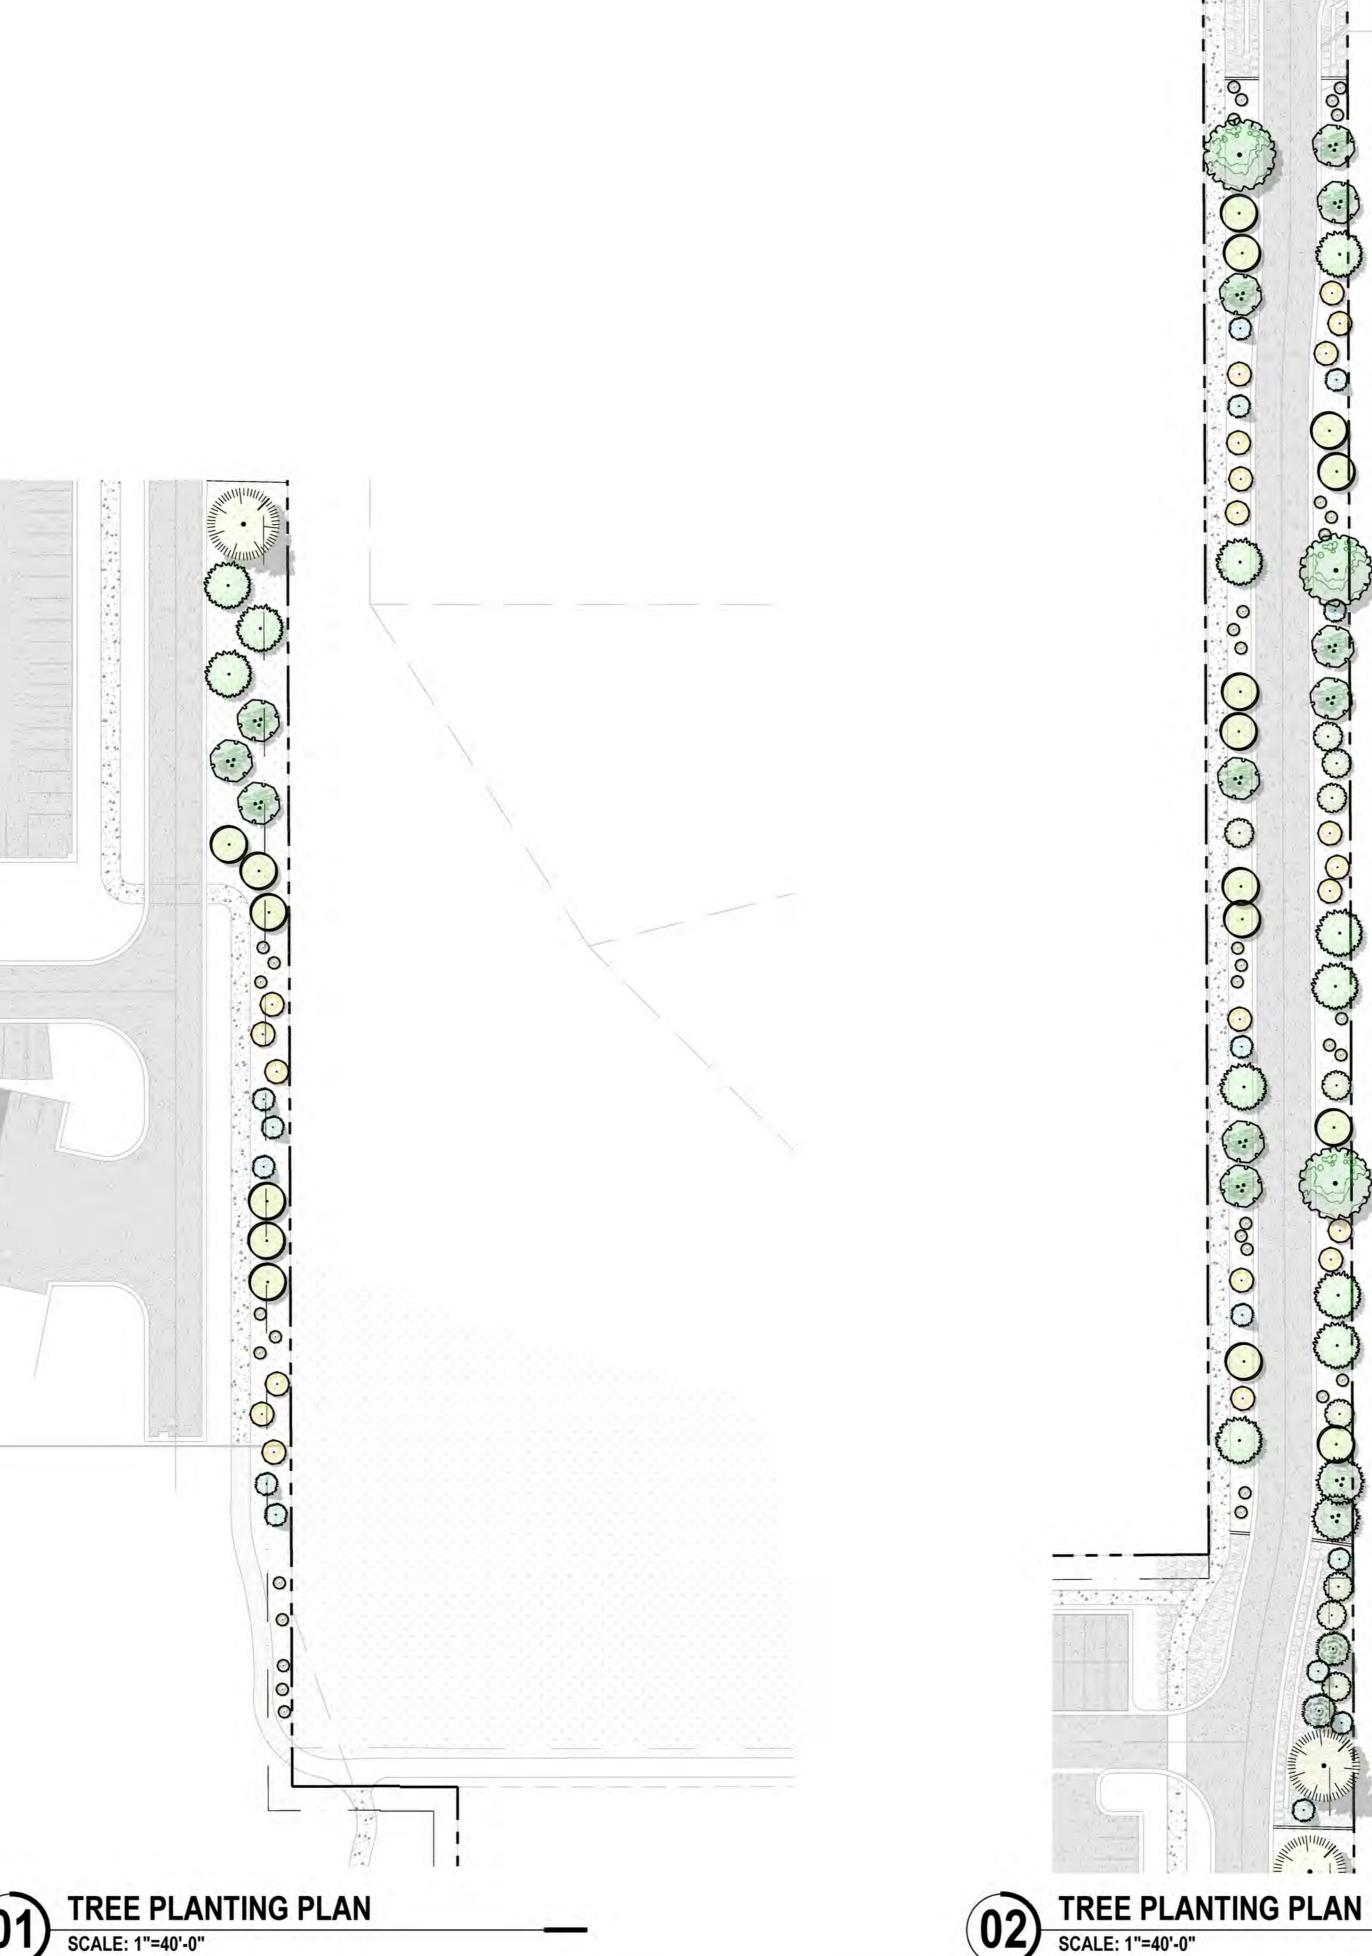

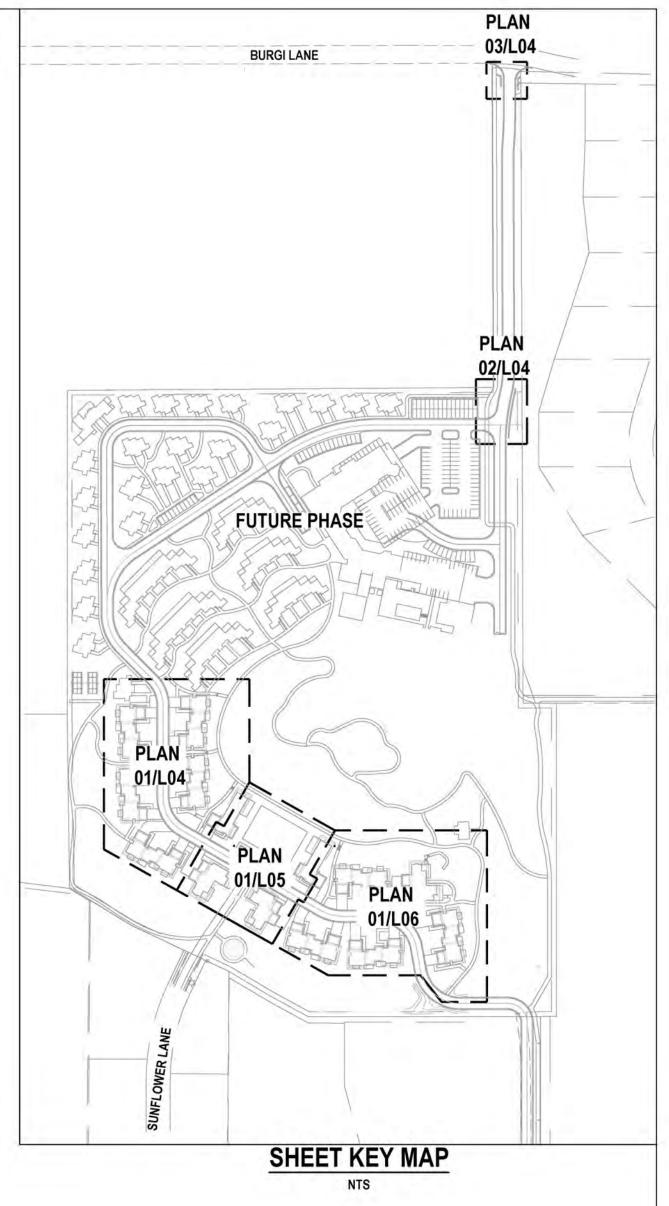

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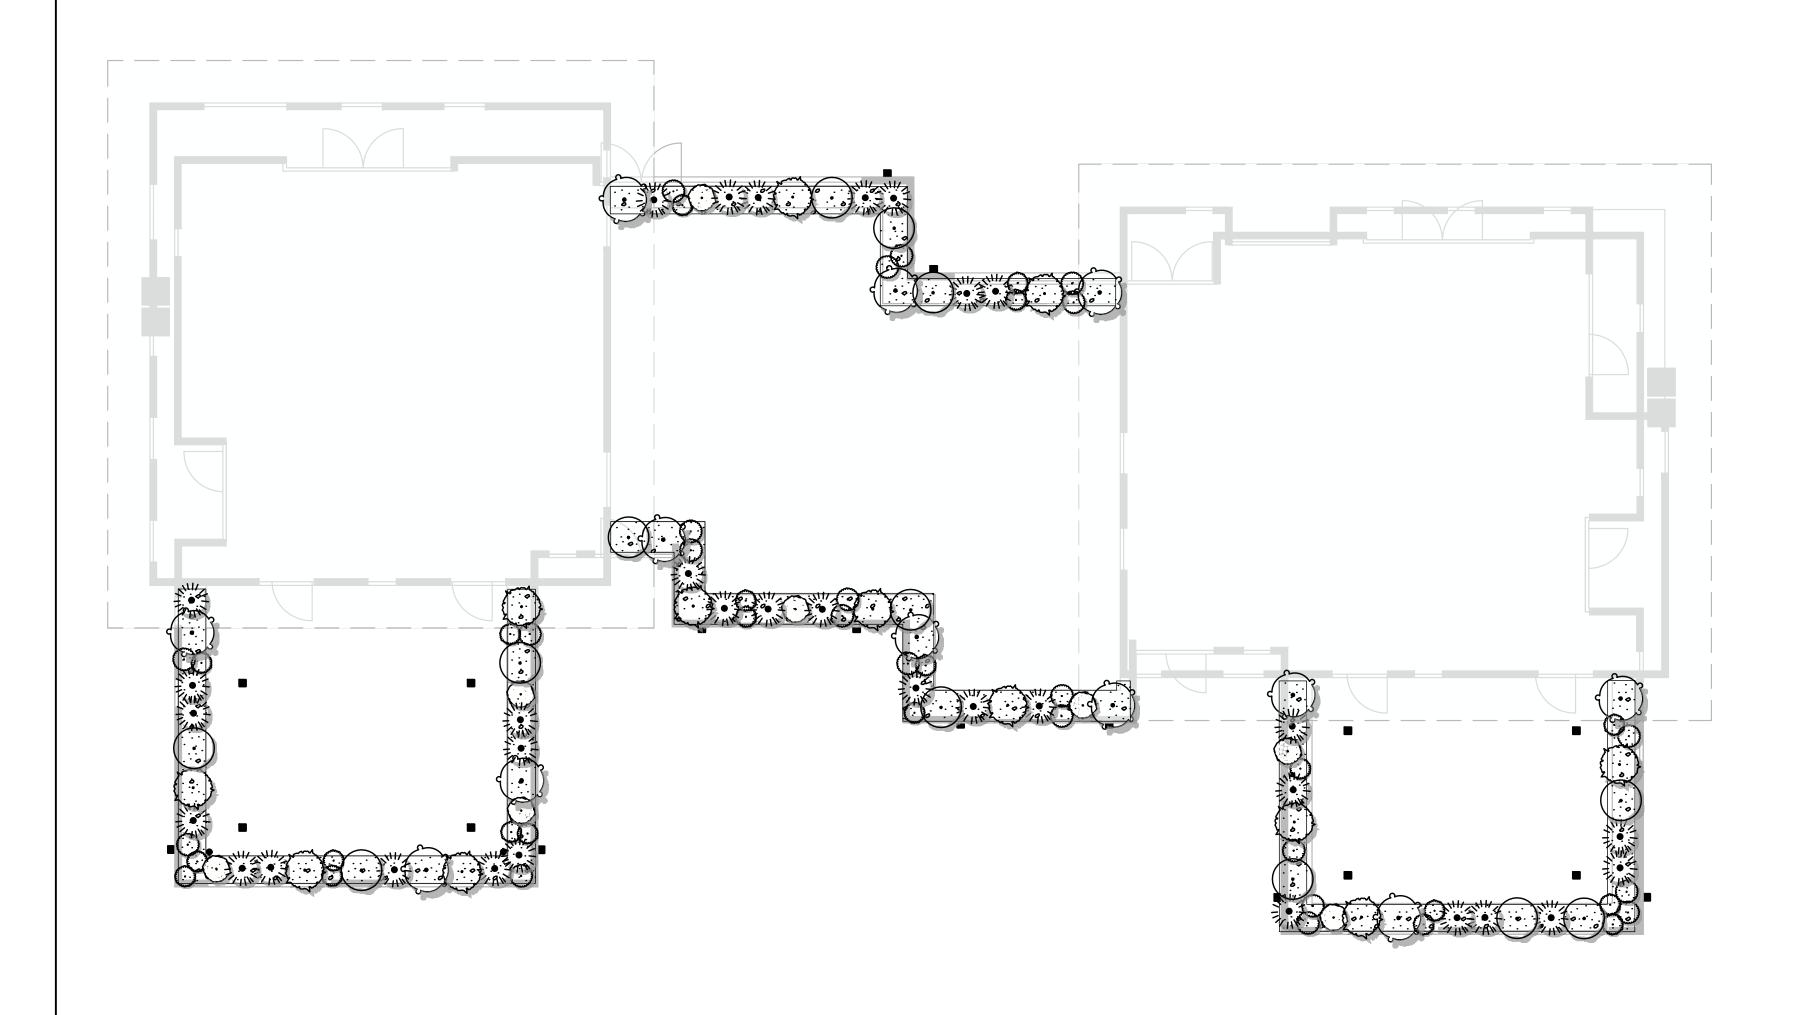
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PHASE 1 SHRUB PLANTING PLAN

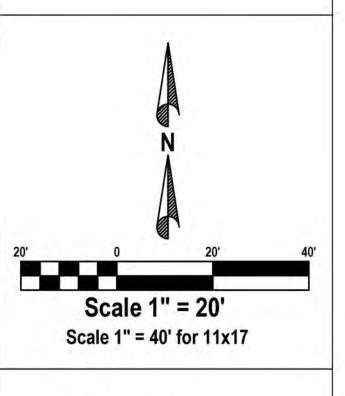

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PLANT SCHEDULE				
ORNAMENTAL GRASSES	QTY	COMMON / BOTANICAL NAME	CONT	
I THE	47	Morning Mist Prairie Dropseed / Sporobolus heterolepis 'Morning Mist'	2 gal	
PERENNIALS	QTY	COMMON / BOTANICAL NAME	CONT	
O	18	Big Time Blue English Lavender / Lavandula angustifolia `Armtipp01`	2 gal	
\odot	14	Evergreen Candytuft / Iberis sempervirens	2 gal	
\bigcirc	15	Lamb's Ear / Stachys byzantina	2 gal	
\odot	18	Walker's Low Catmint / Nepeta x faassenii 'Walker's Low'	2 gal	
PERENNIALS/GROUNDCOVERS	QTY	COMMON / BOTANICAL NAME	CONT	
0	30	Deep Pink Creeping Phlox / Phlox stolonifera `Fort Hill`	1 gal	
\odot	36	Snow In Summer / Cerastium tomentosum	2 gal	
MULCH	QTY	COMMON / BOTANICAL NAME	CONT	
	643 sf	Gravel / Gravel - 3/8" minus - 3" Depth	Gravel	















DUPLEX 'B'
NTS

BUILDING TYPES:

DUPLEX - A: 9 EACH DUPLEX - B: 3 EACH FAMILY LODGES: 2 EACH THIS DOCUMENT IS RELEASED FOR REVIEW ONLY. IT IS NOT INTENDED FOR CONSTRUCTION UNLESS SIGNED AND SEALED. BRYAN M. NICHOLAS P.L.A. SERIAL NO. <u>12902936-5301</u>

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DUPLEX A & B ROOFTOP PLANTING PLAN




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DUPLEX 'A'

NTS



PLANT SCHEDULE FAMILY L	ODGE

DRNAMENTAL GRASSES	QTY	COMMON / BOTANICAL NAME	CONT
	16	Morning Mist Prairie Dropseed / Sporobolus heterolepis 'Morning Mist'	2 gal
PERENNIALS	QTY	COMMON / BOTANICAL NAME	CONT
O	8	Big Time Blue English Lavender / Lavandula angustifolia `Armtipp01`	2 gal
\odot	4	Evergreen Candytuft / Iberis sempervirens	2 gal
\bigcirc	6	Lamb's Ear / Stachys byzantina	2 gal
\odot	5	Walker's Low Catmint / Nepeta x faassenii 'Walker's Low'	2 gal
PERENNIALS/GROUNDCOVERS	QTY	COMMON / BOTANICAL NAME	CONT
\odot	13	Deep Pink Creeping Phlox / Phlox stolonifera `Fort Hill`	1 gal
\odot	11	Snow In Summer / Cerastium tomentosum	2 gal
MULCH	QTY	COMMON / BOTANICAL NAME	CONT
	229 sf	Gravel / Gravel - 3/8" minus - 3" Depth	Gravel

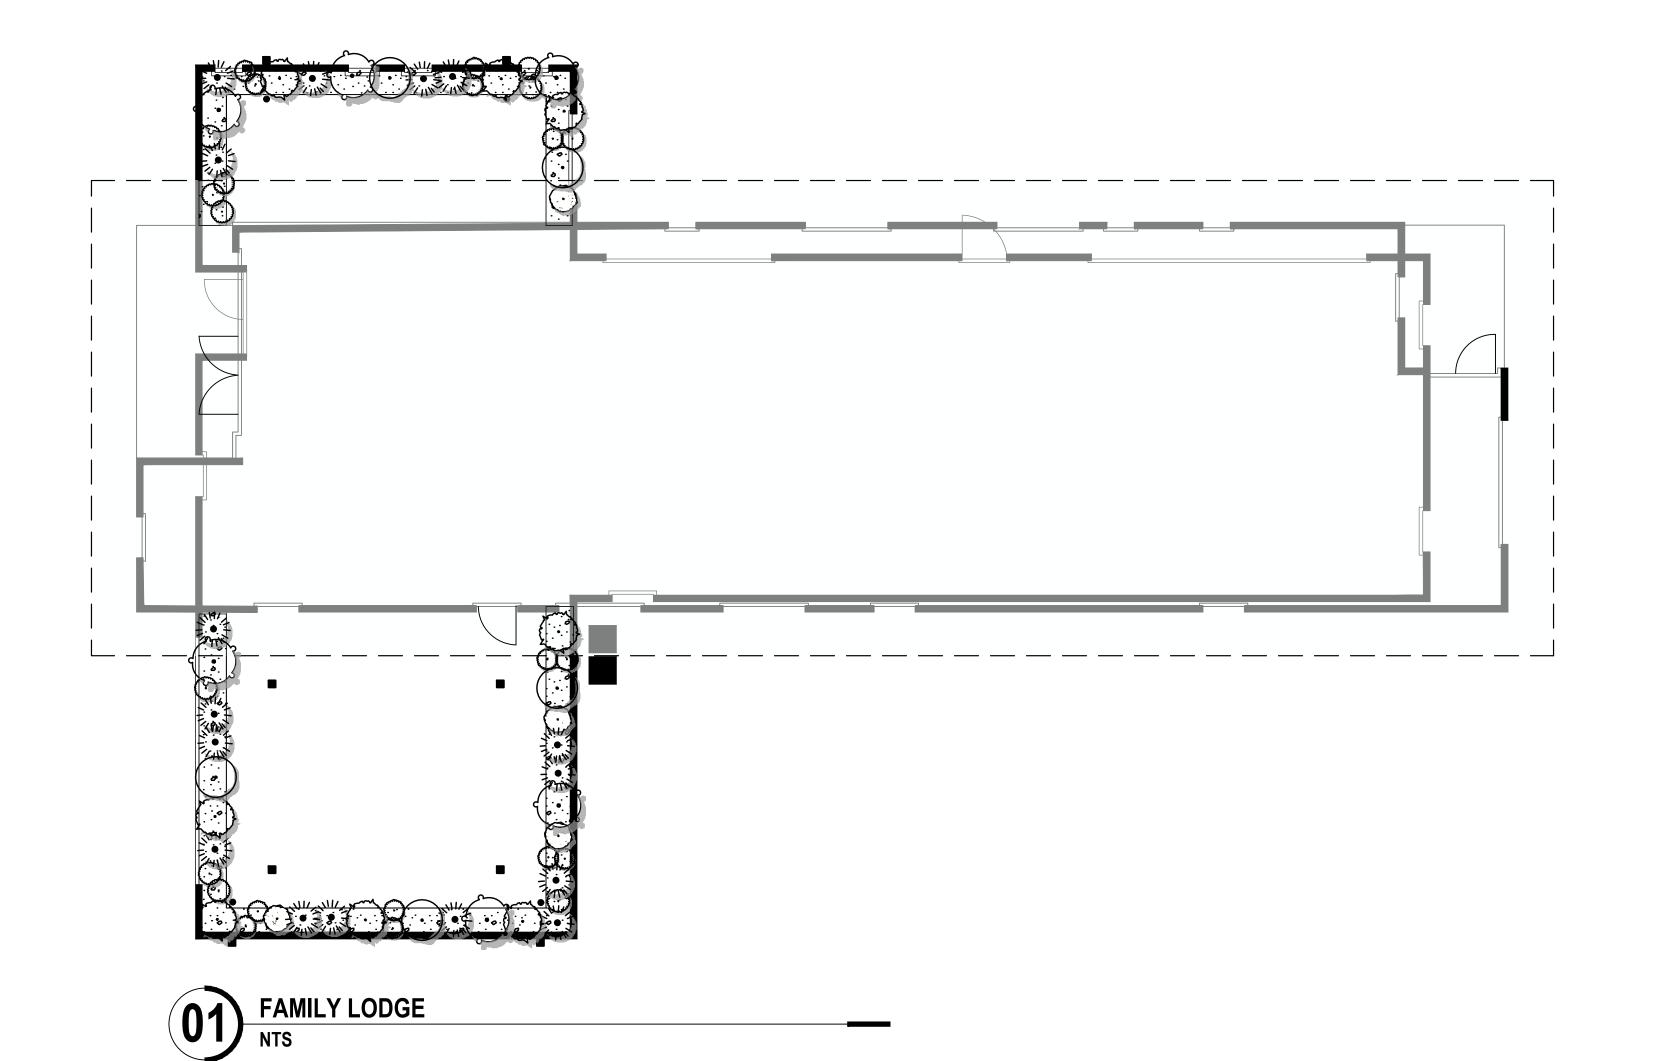













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AMEYALLI RESORT

FAMILY LODGE ROOFTOP PLANTING PLAN

BUILDING TYPES:


DUPLEX - A: 9 EACH **DUPLEX - B: 3 EACH** FAMILY LODGES: 2 EACH


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SHEET
L08






- DEWITT PRO 5 FABRIC TO HAVE 6" MIN. OVERLAY BETWEEN LAYERS.
- 2. SUBGRADE TO BE HAND COMPACTED.
- MIXTURE OF RIVER ROCK & COBBLE TO BE MIXED.
 ROCK IS TO START MINIMUM 6" ABOVE START OF DOWN SLOPE.
- 3" -1 ½" RIVER ROCK 60% OF MATERIAL

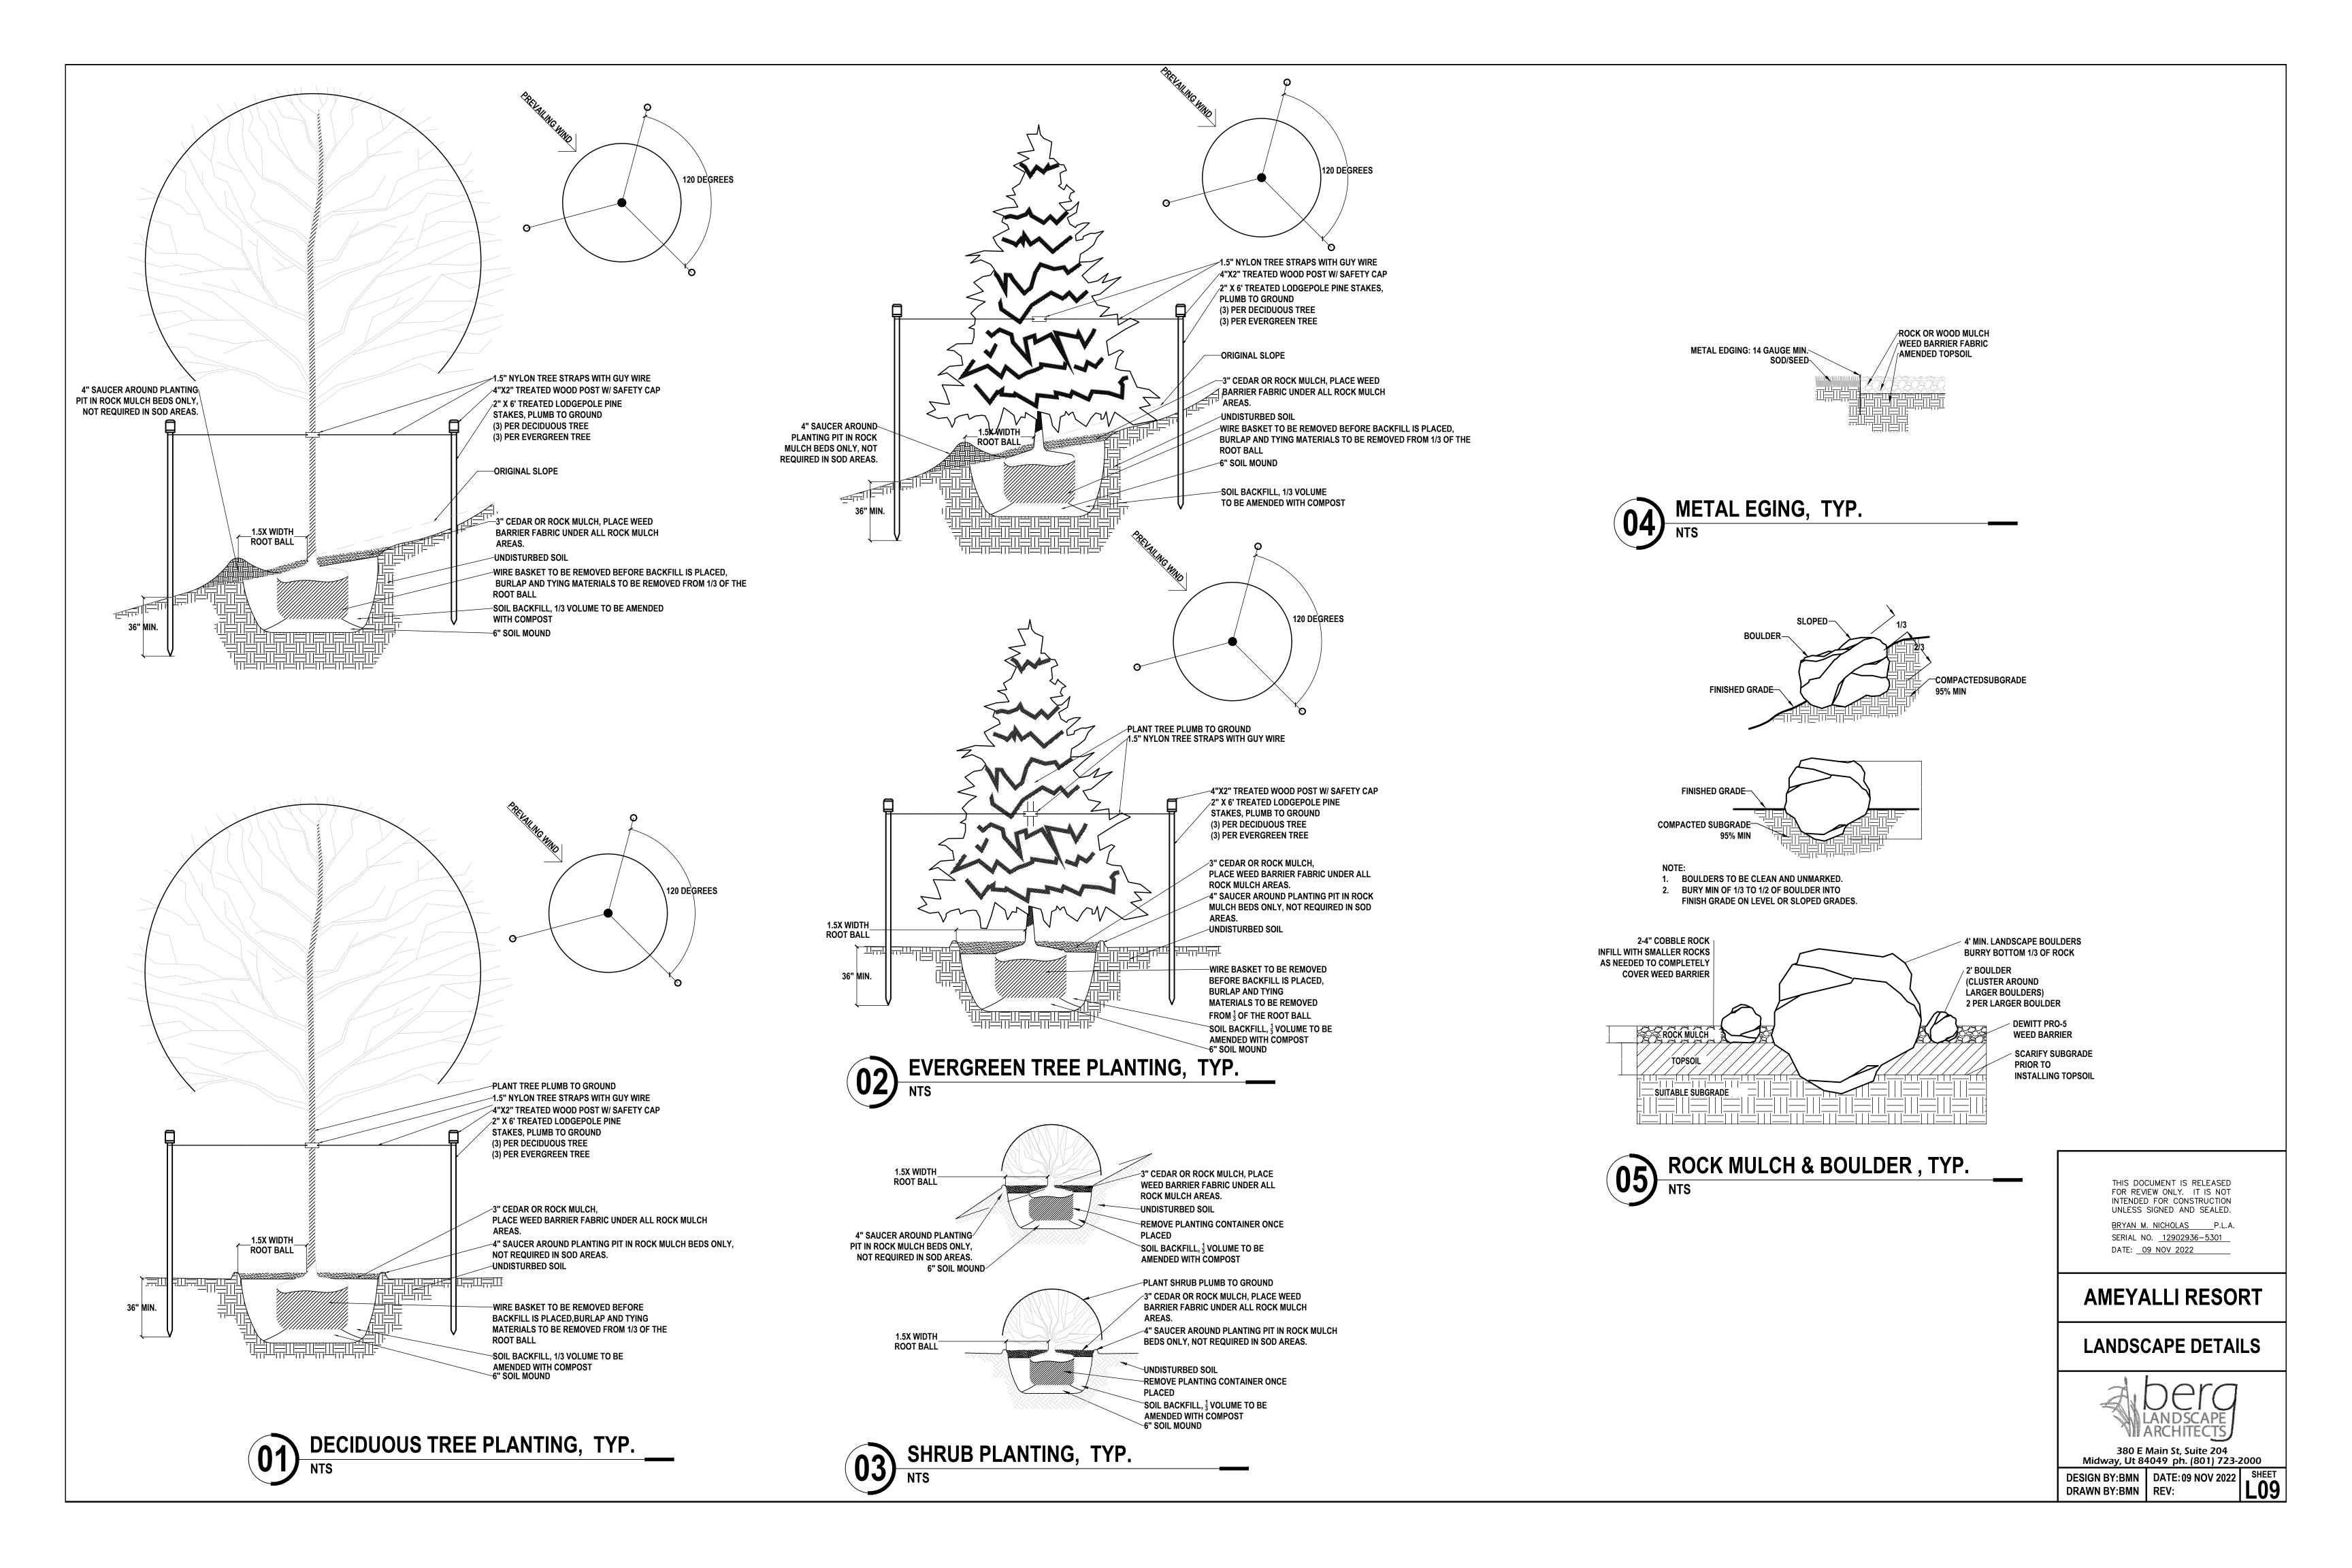
 6"-8" RIVER COBBLE 40% OF MATERIAL

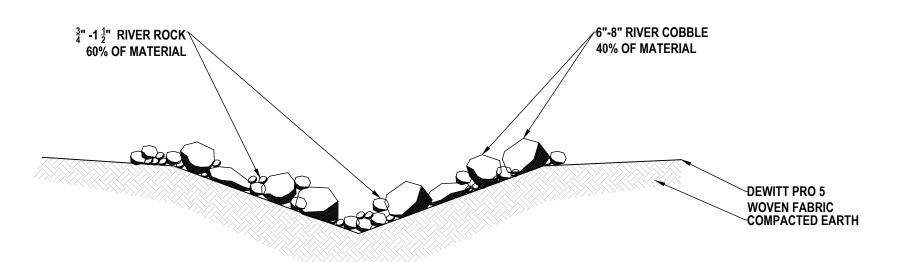 DEWITT PRO 5 WOVEN FABRIC COMPACTED EARTH
- 1. DEWITT PRO 5 FABRIC TO HAVE 6" MIN. OVERLAY BETWEEN LAYERS.
- 2. SUBGRADE TO BE HAND COMPACTED.
- 3. MIXTURE OF RIVER ROCK & COBBLE TO BE MIXED.
- 4. ROCK IS TO START MINIMUM 6" ABOVE START OF DOWN SLOPE.




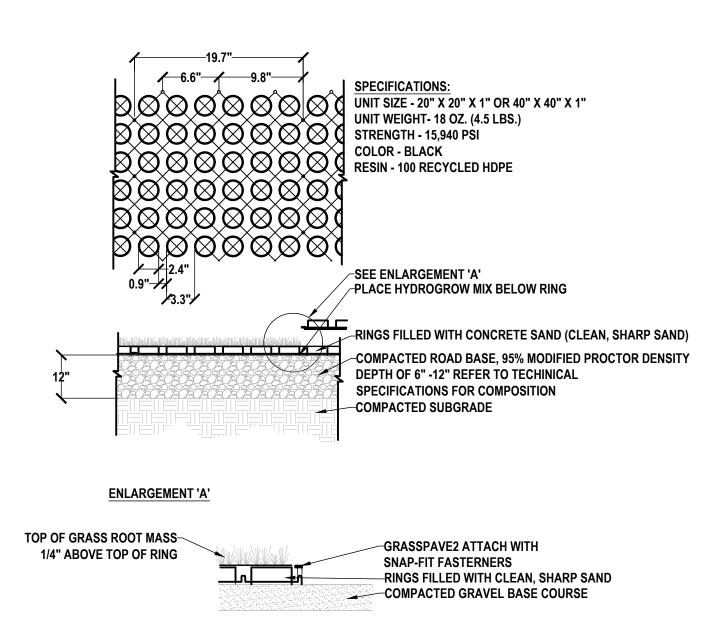




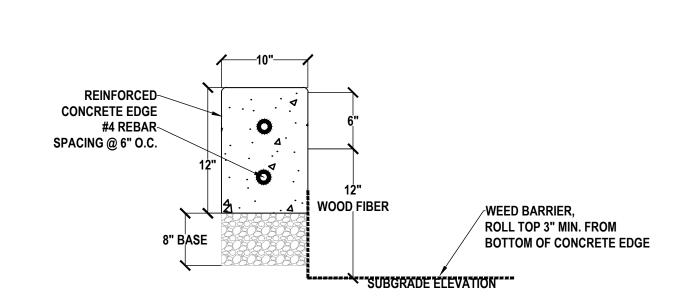




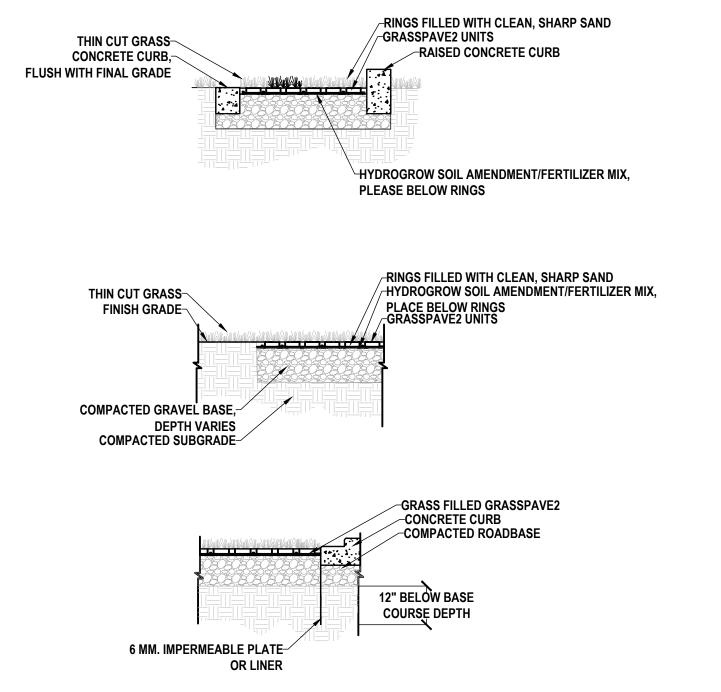



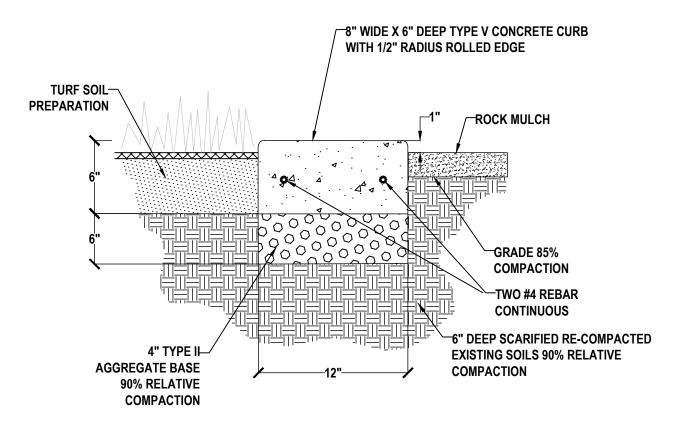



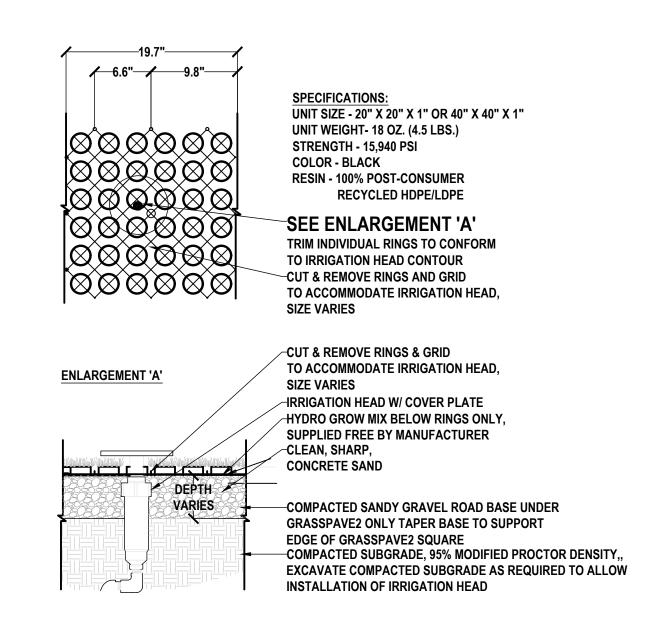



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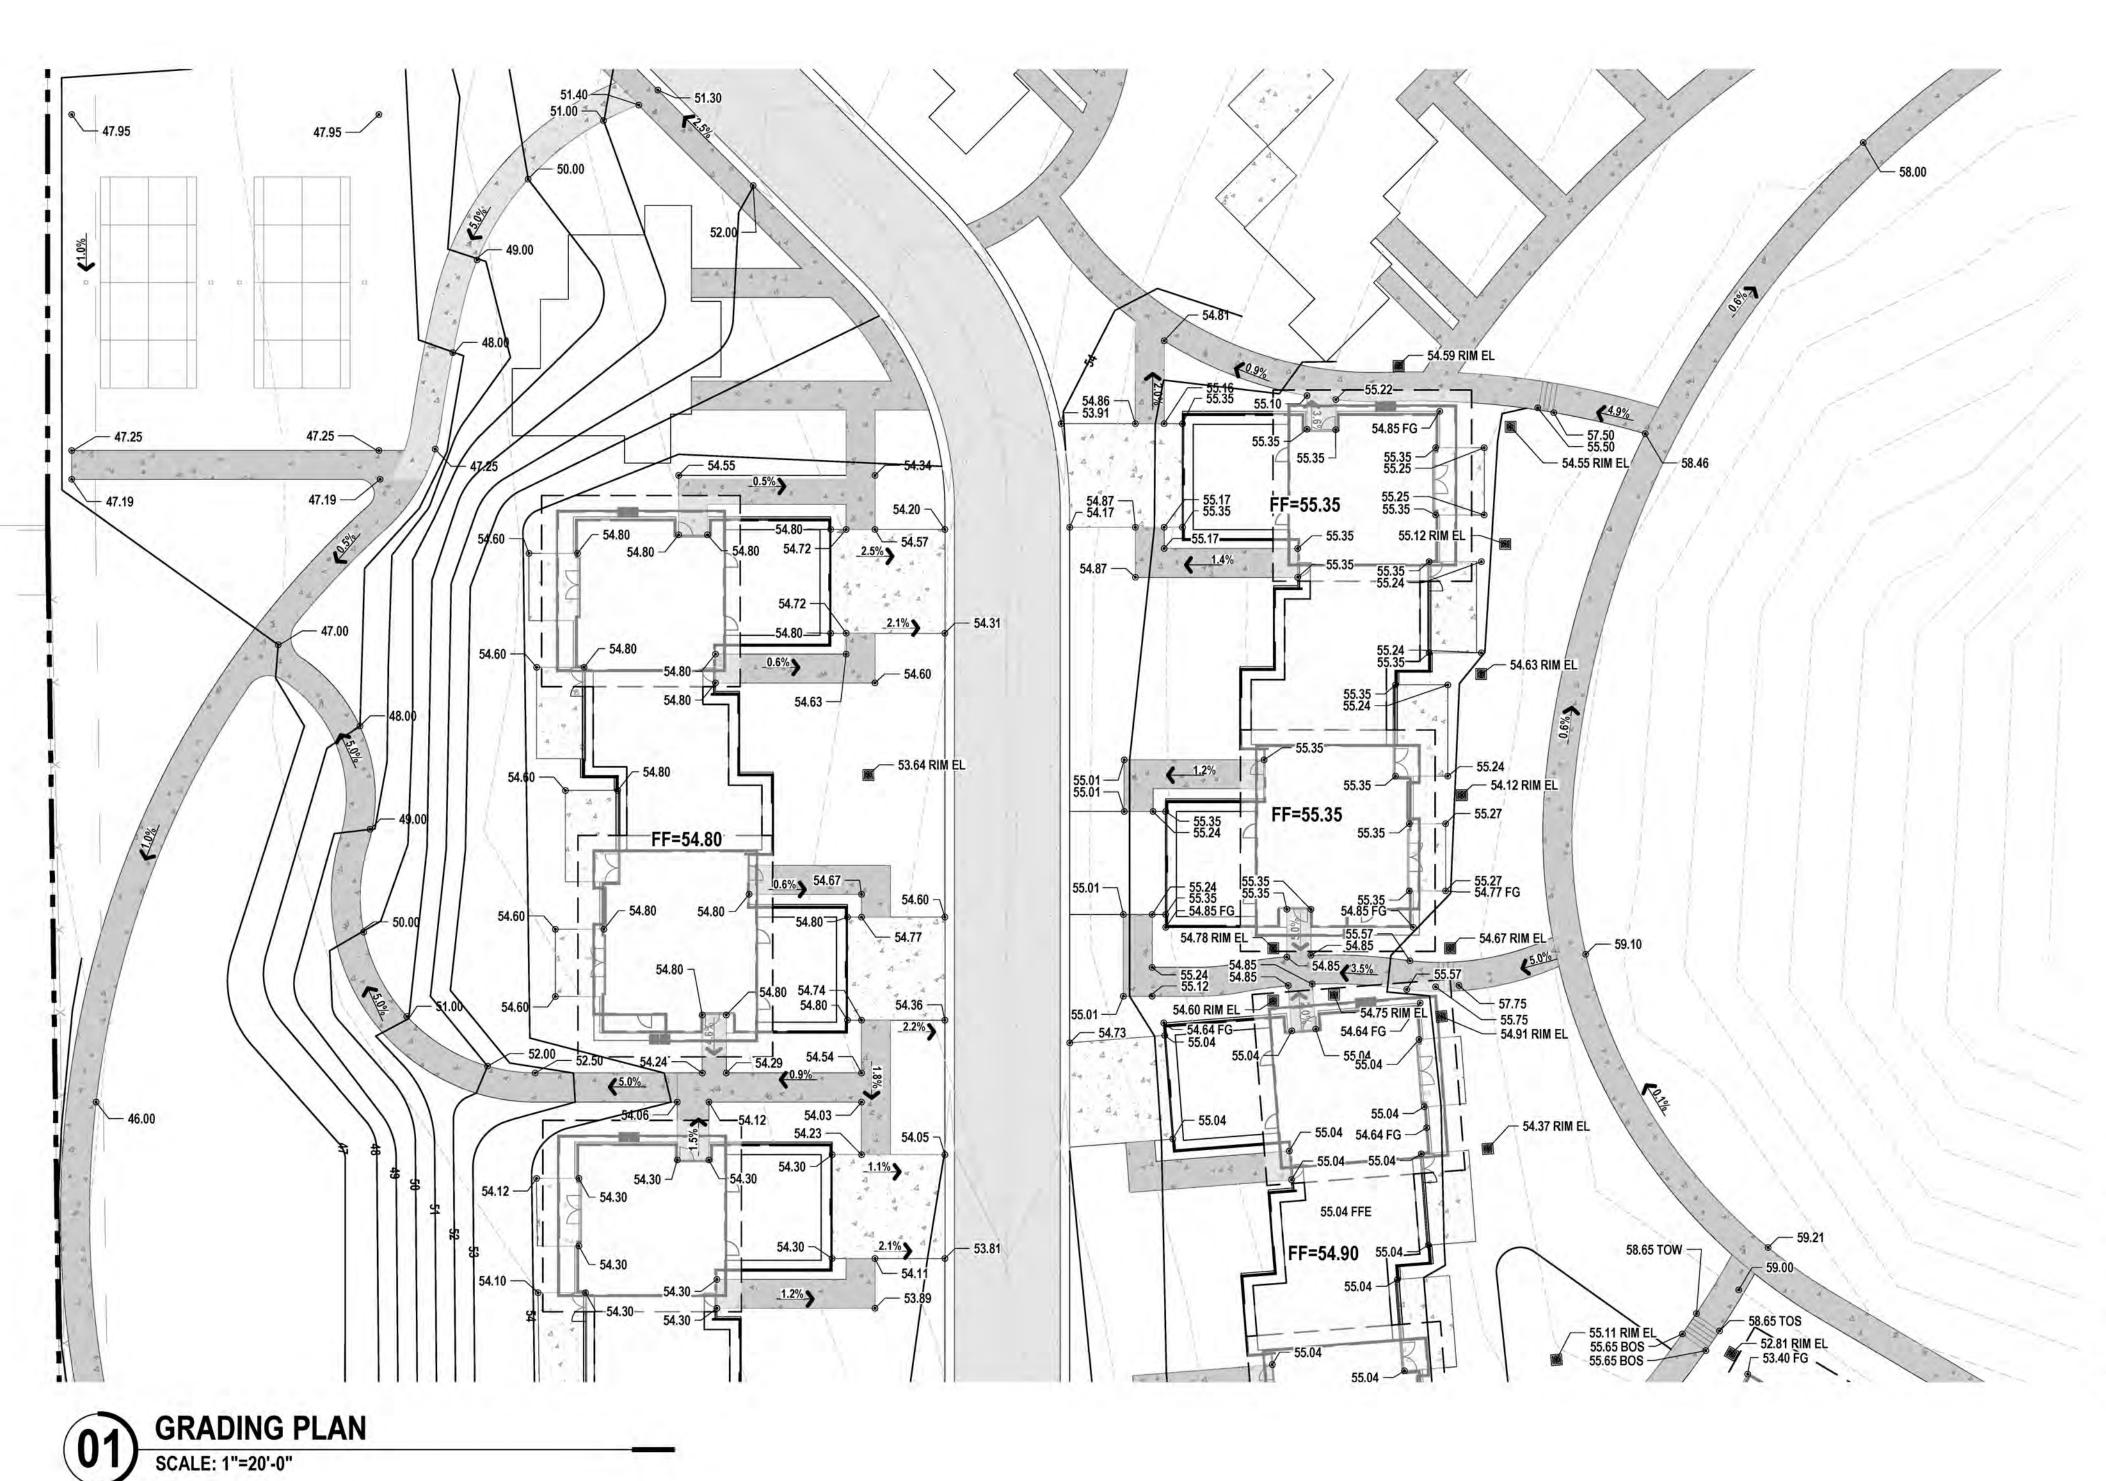
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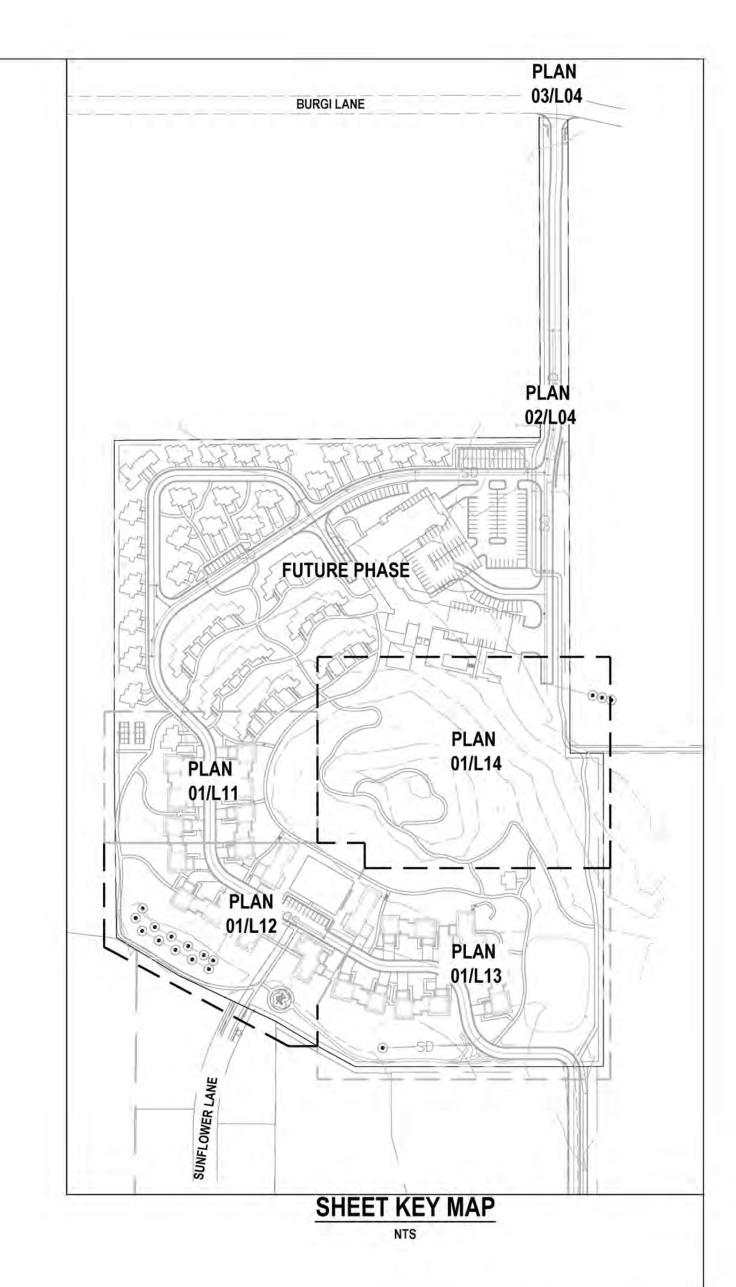
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SITE DETAILS



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LEGEND

EOP EDGE OF PAVEMENT FG FINISHED GRADE

BOW BOTTOM OF WALL

TOW TOP OF WALL BOS BOTTOM OF STAIRS

TOS TOP OF STAIRS

HP HIGH POINT

LP LOW POINT RIM EL RIM ELEVATION

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Scale 1" = 20'

Scale 1" = 40' for 11x17

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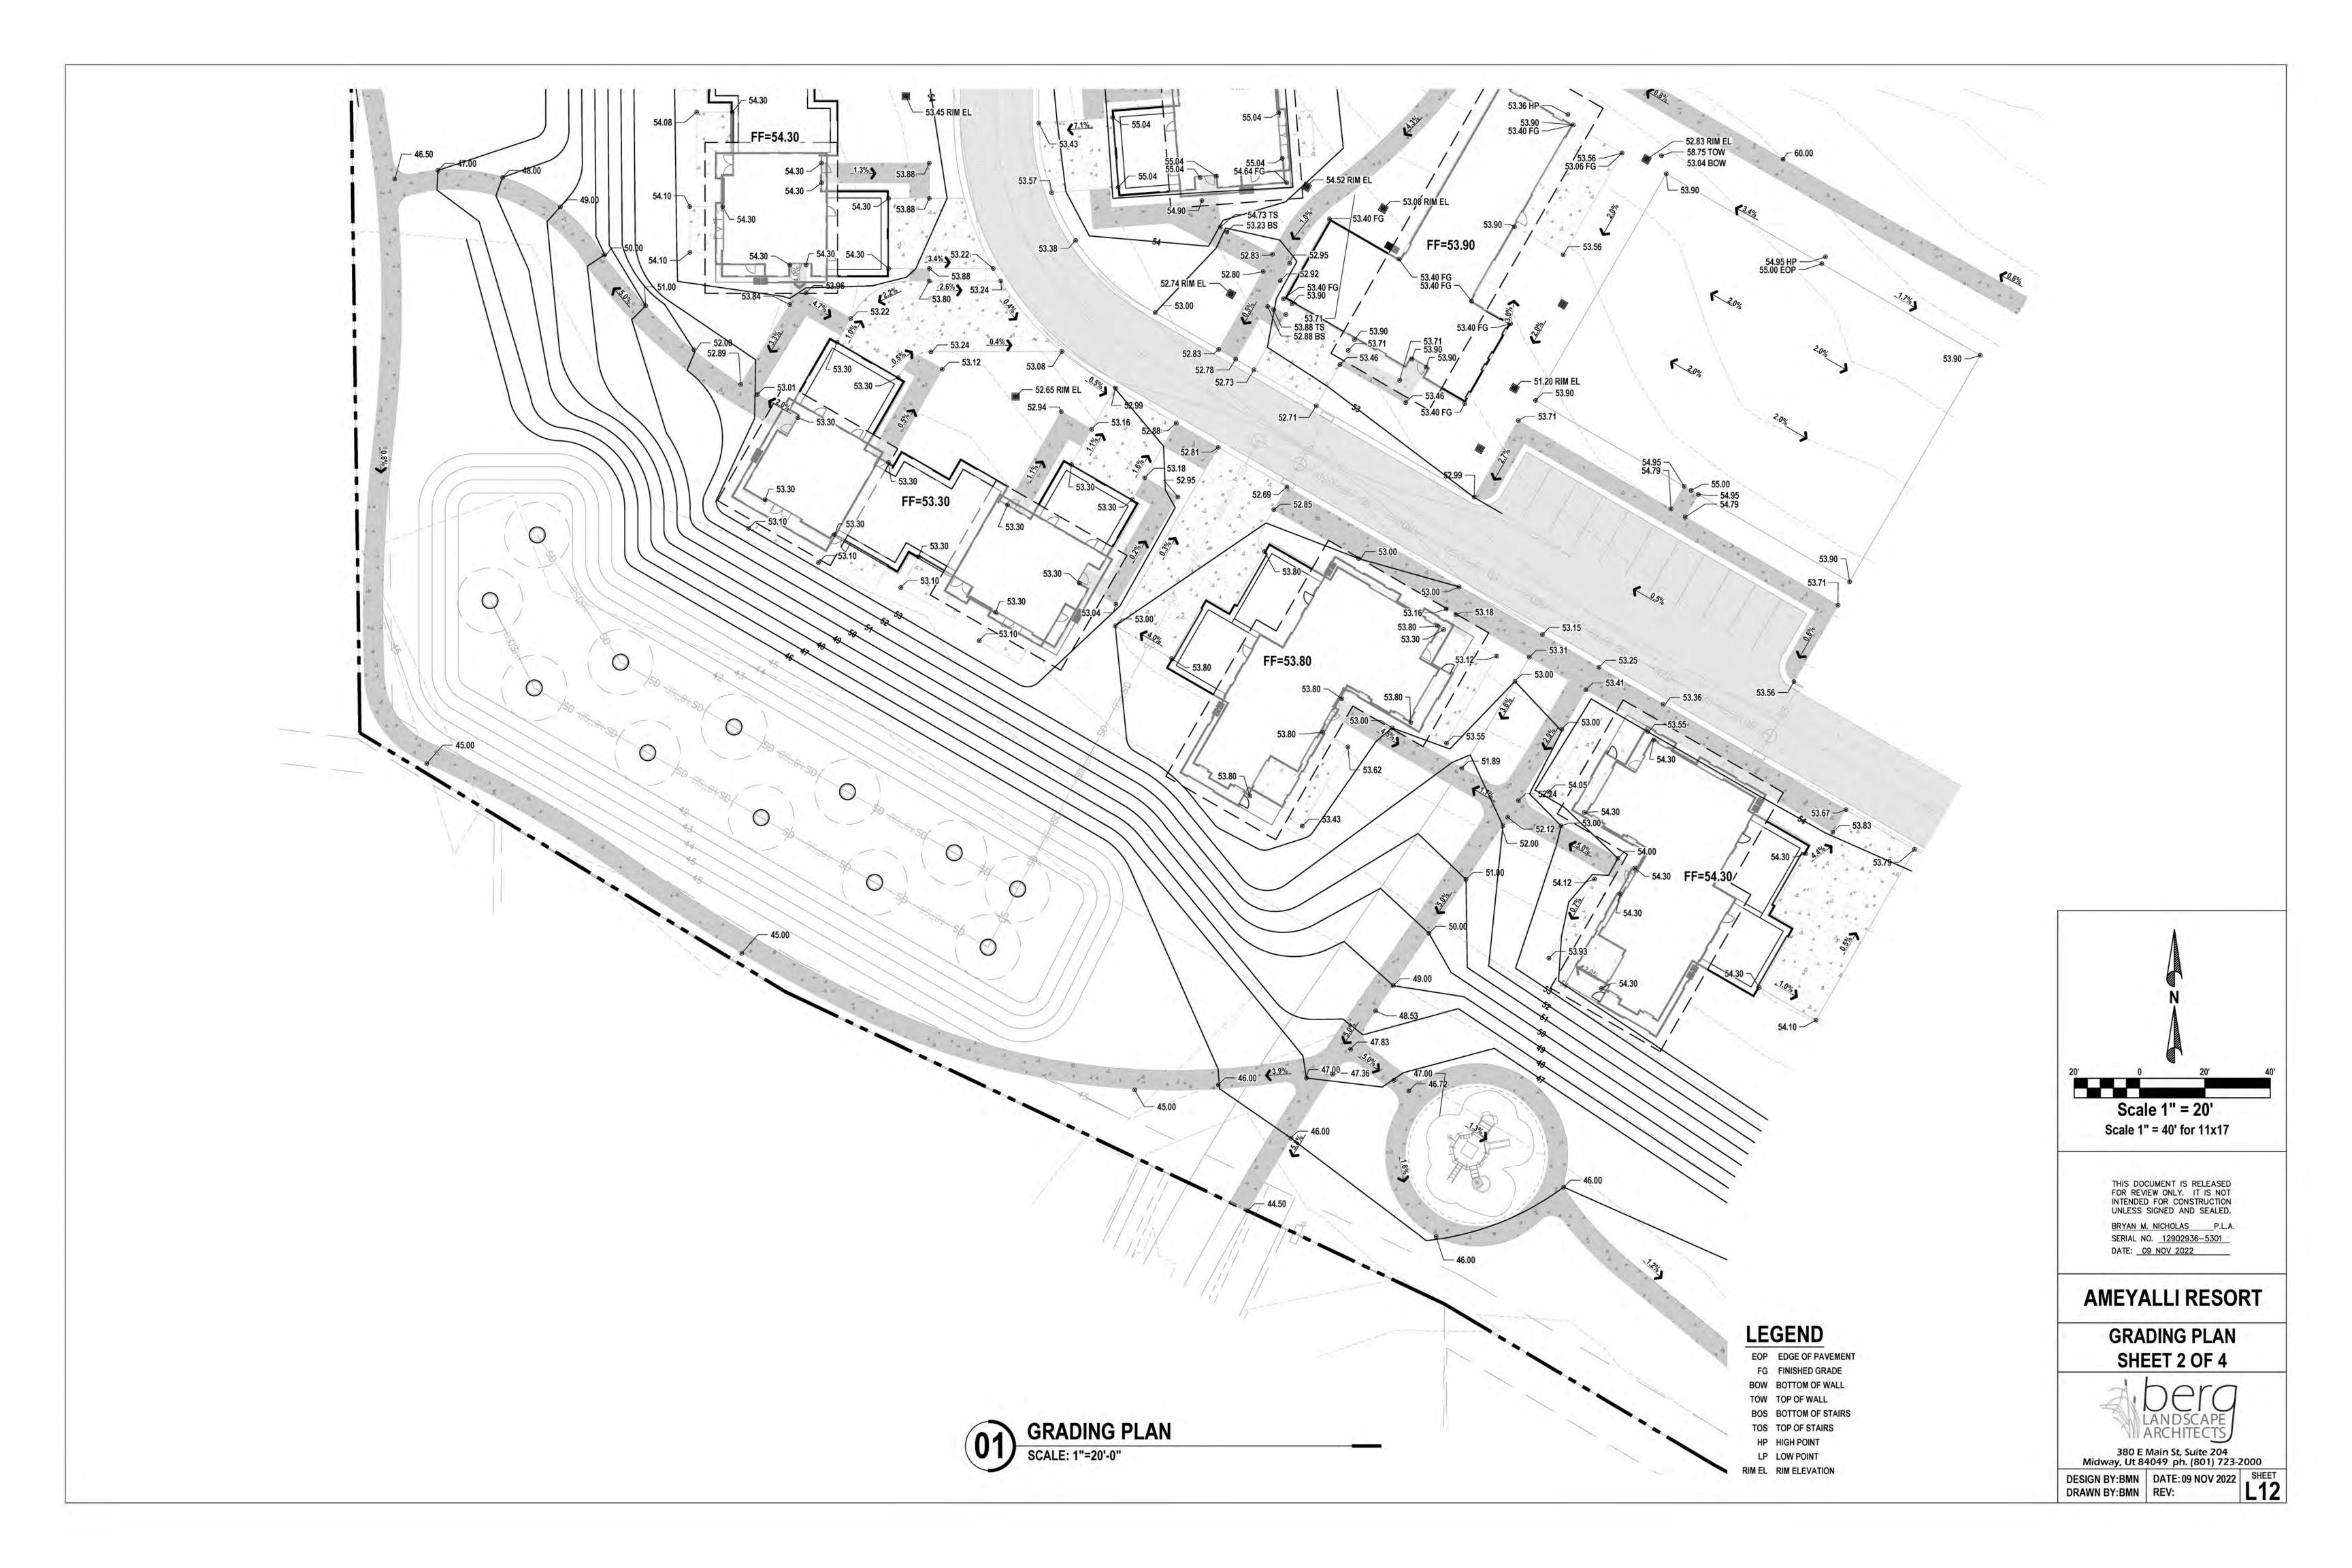
DATE: 09 NOV 2022


GRADING PLAN SHEET 1 OF 4




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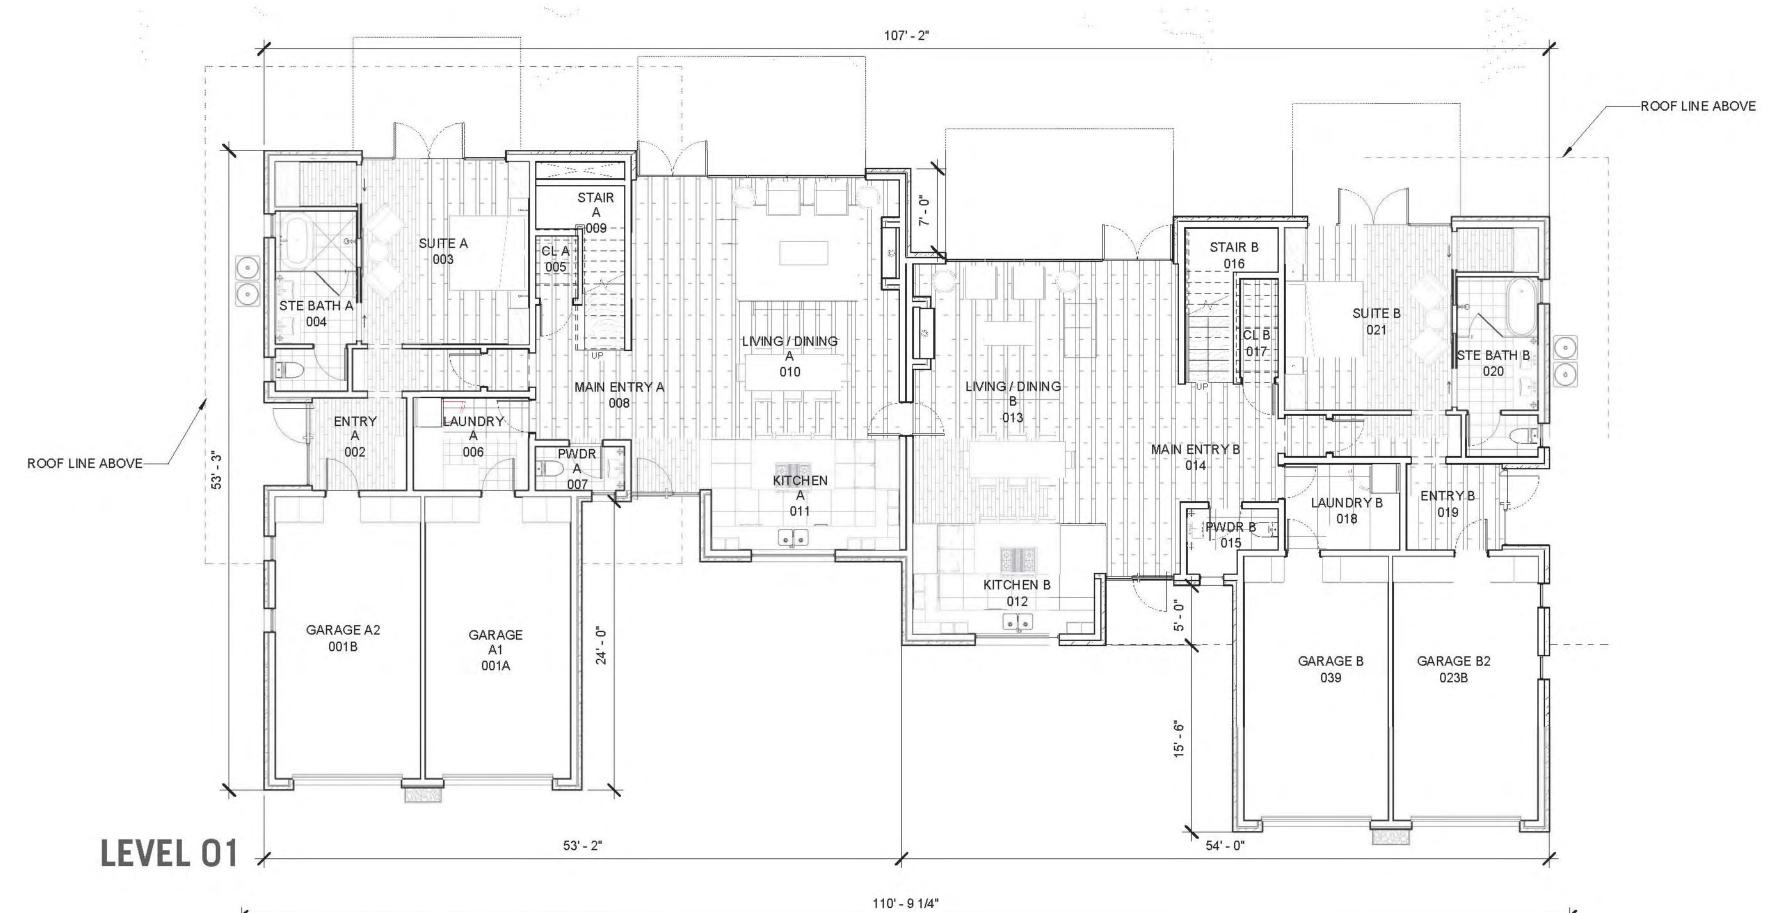




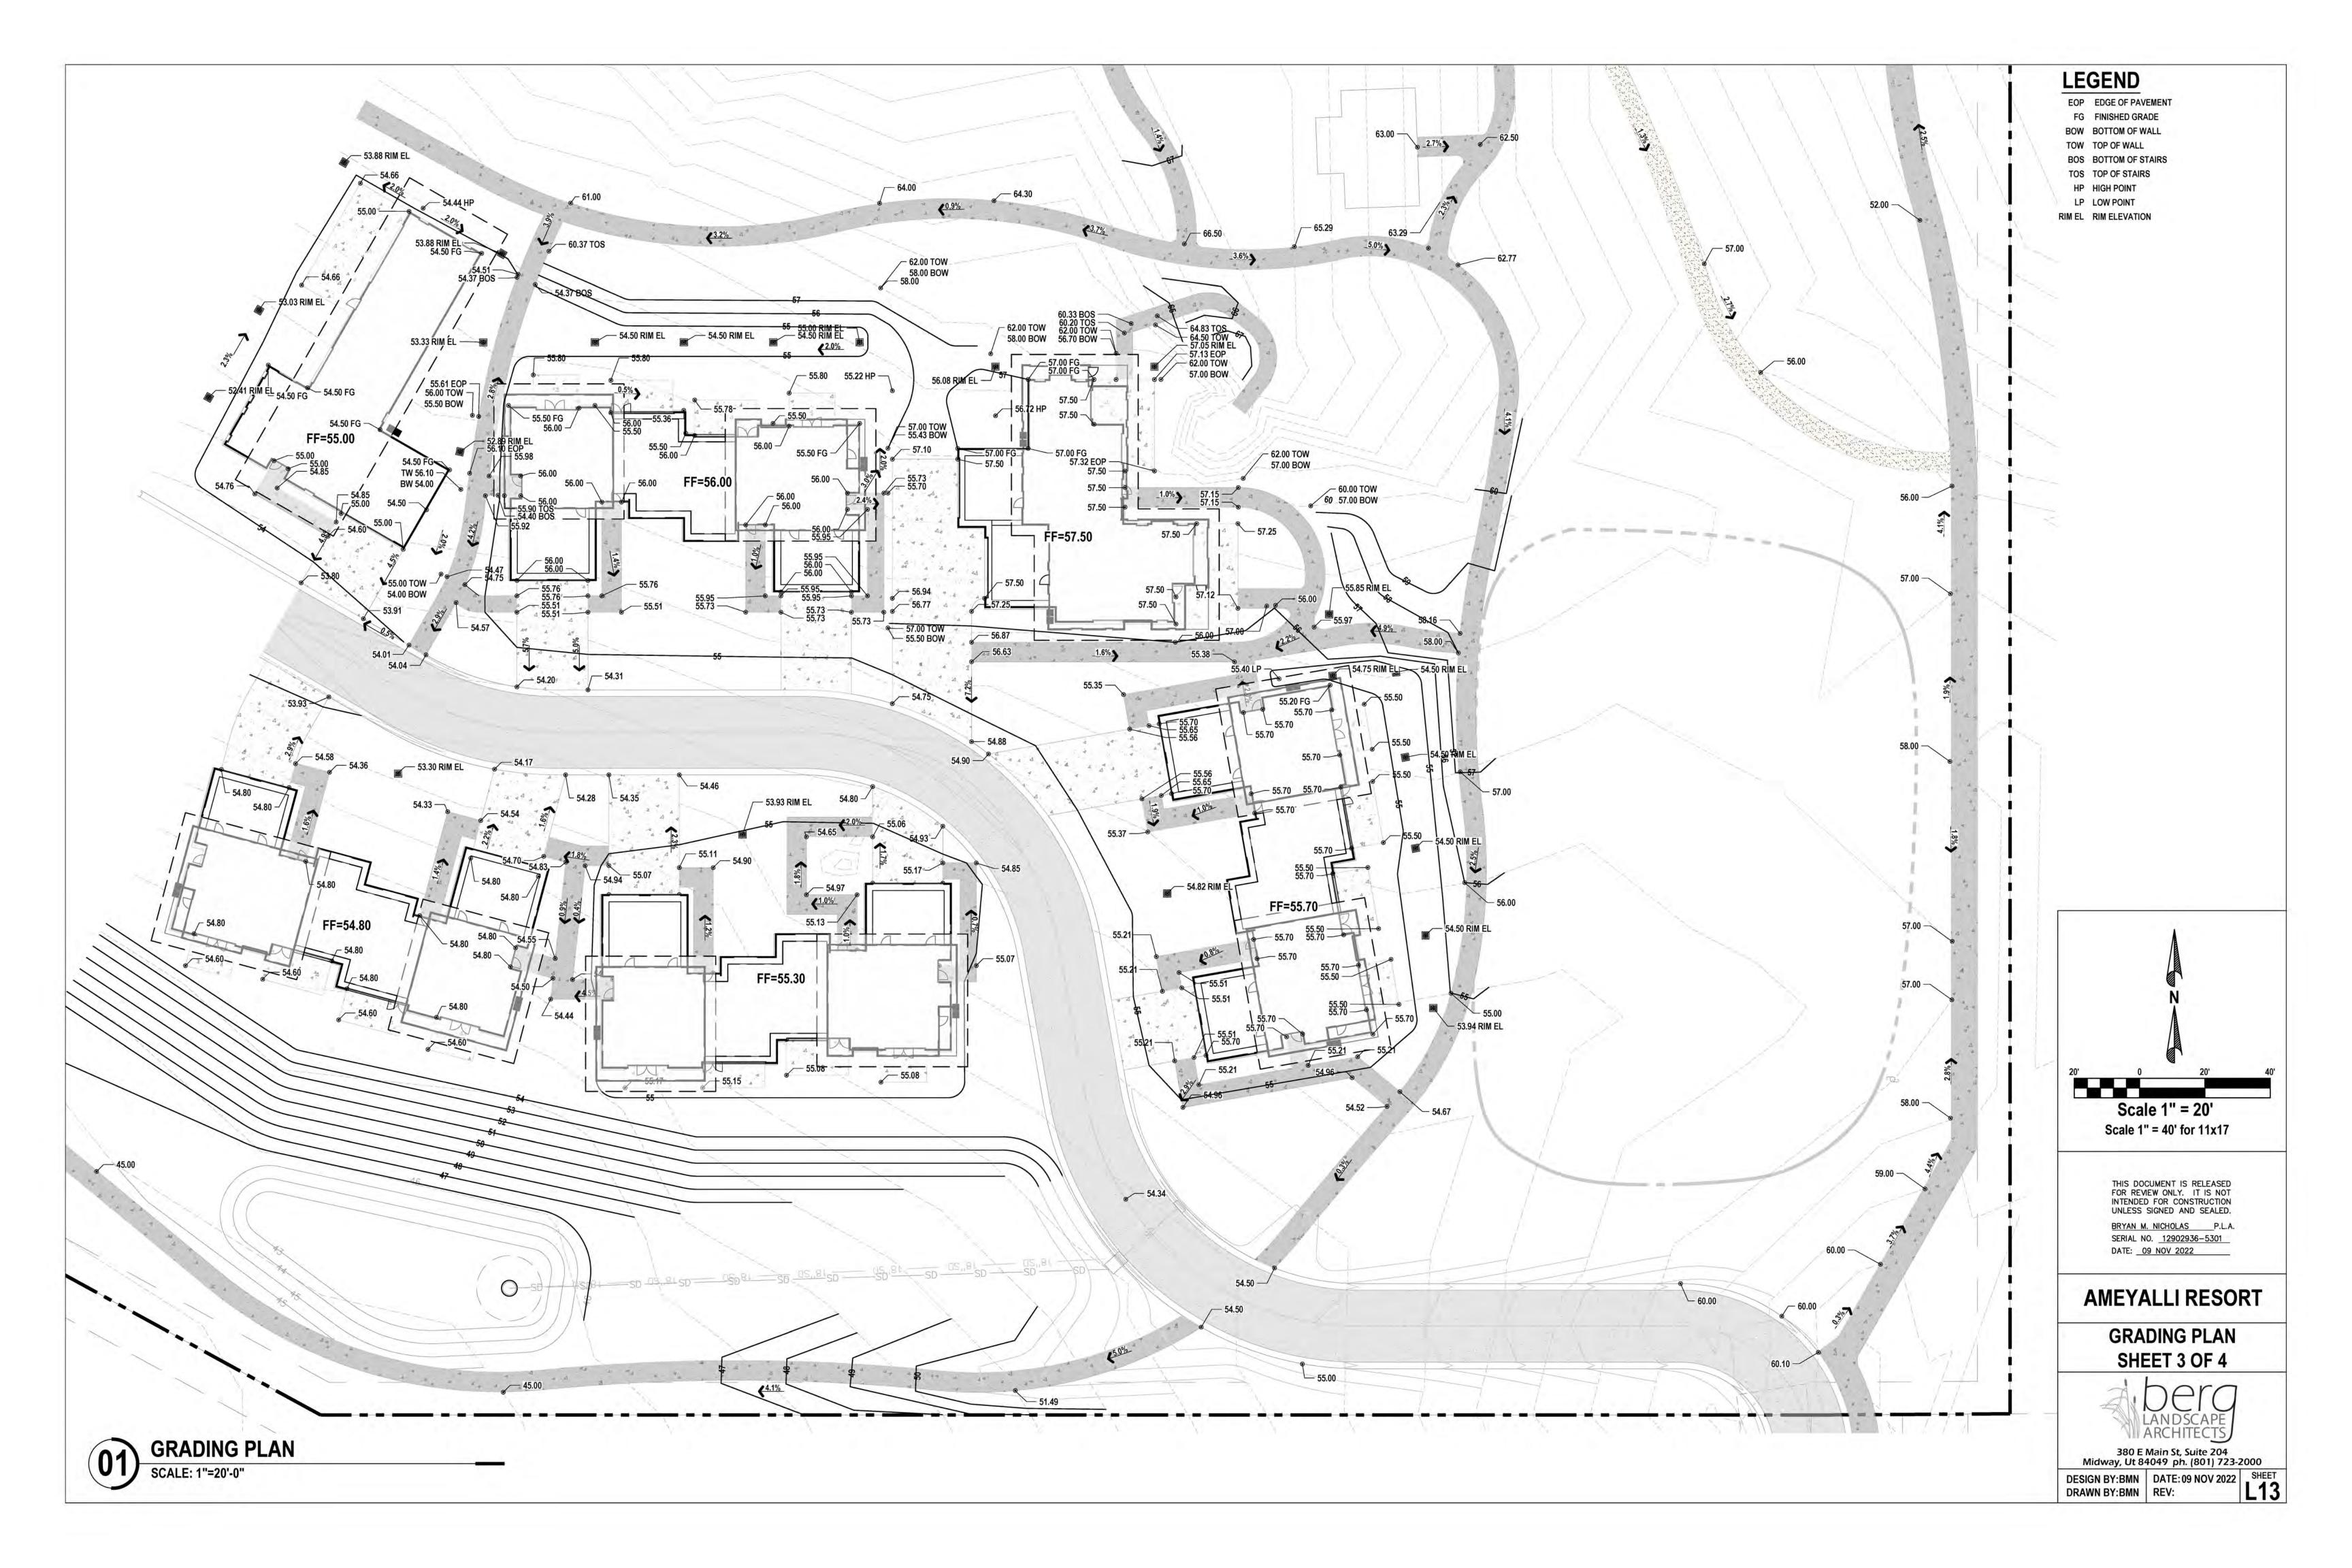


BUILDING AREA PLAN AND DESIGN ELEMENTS |

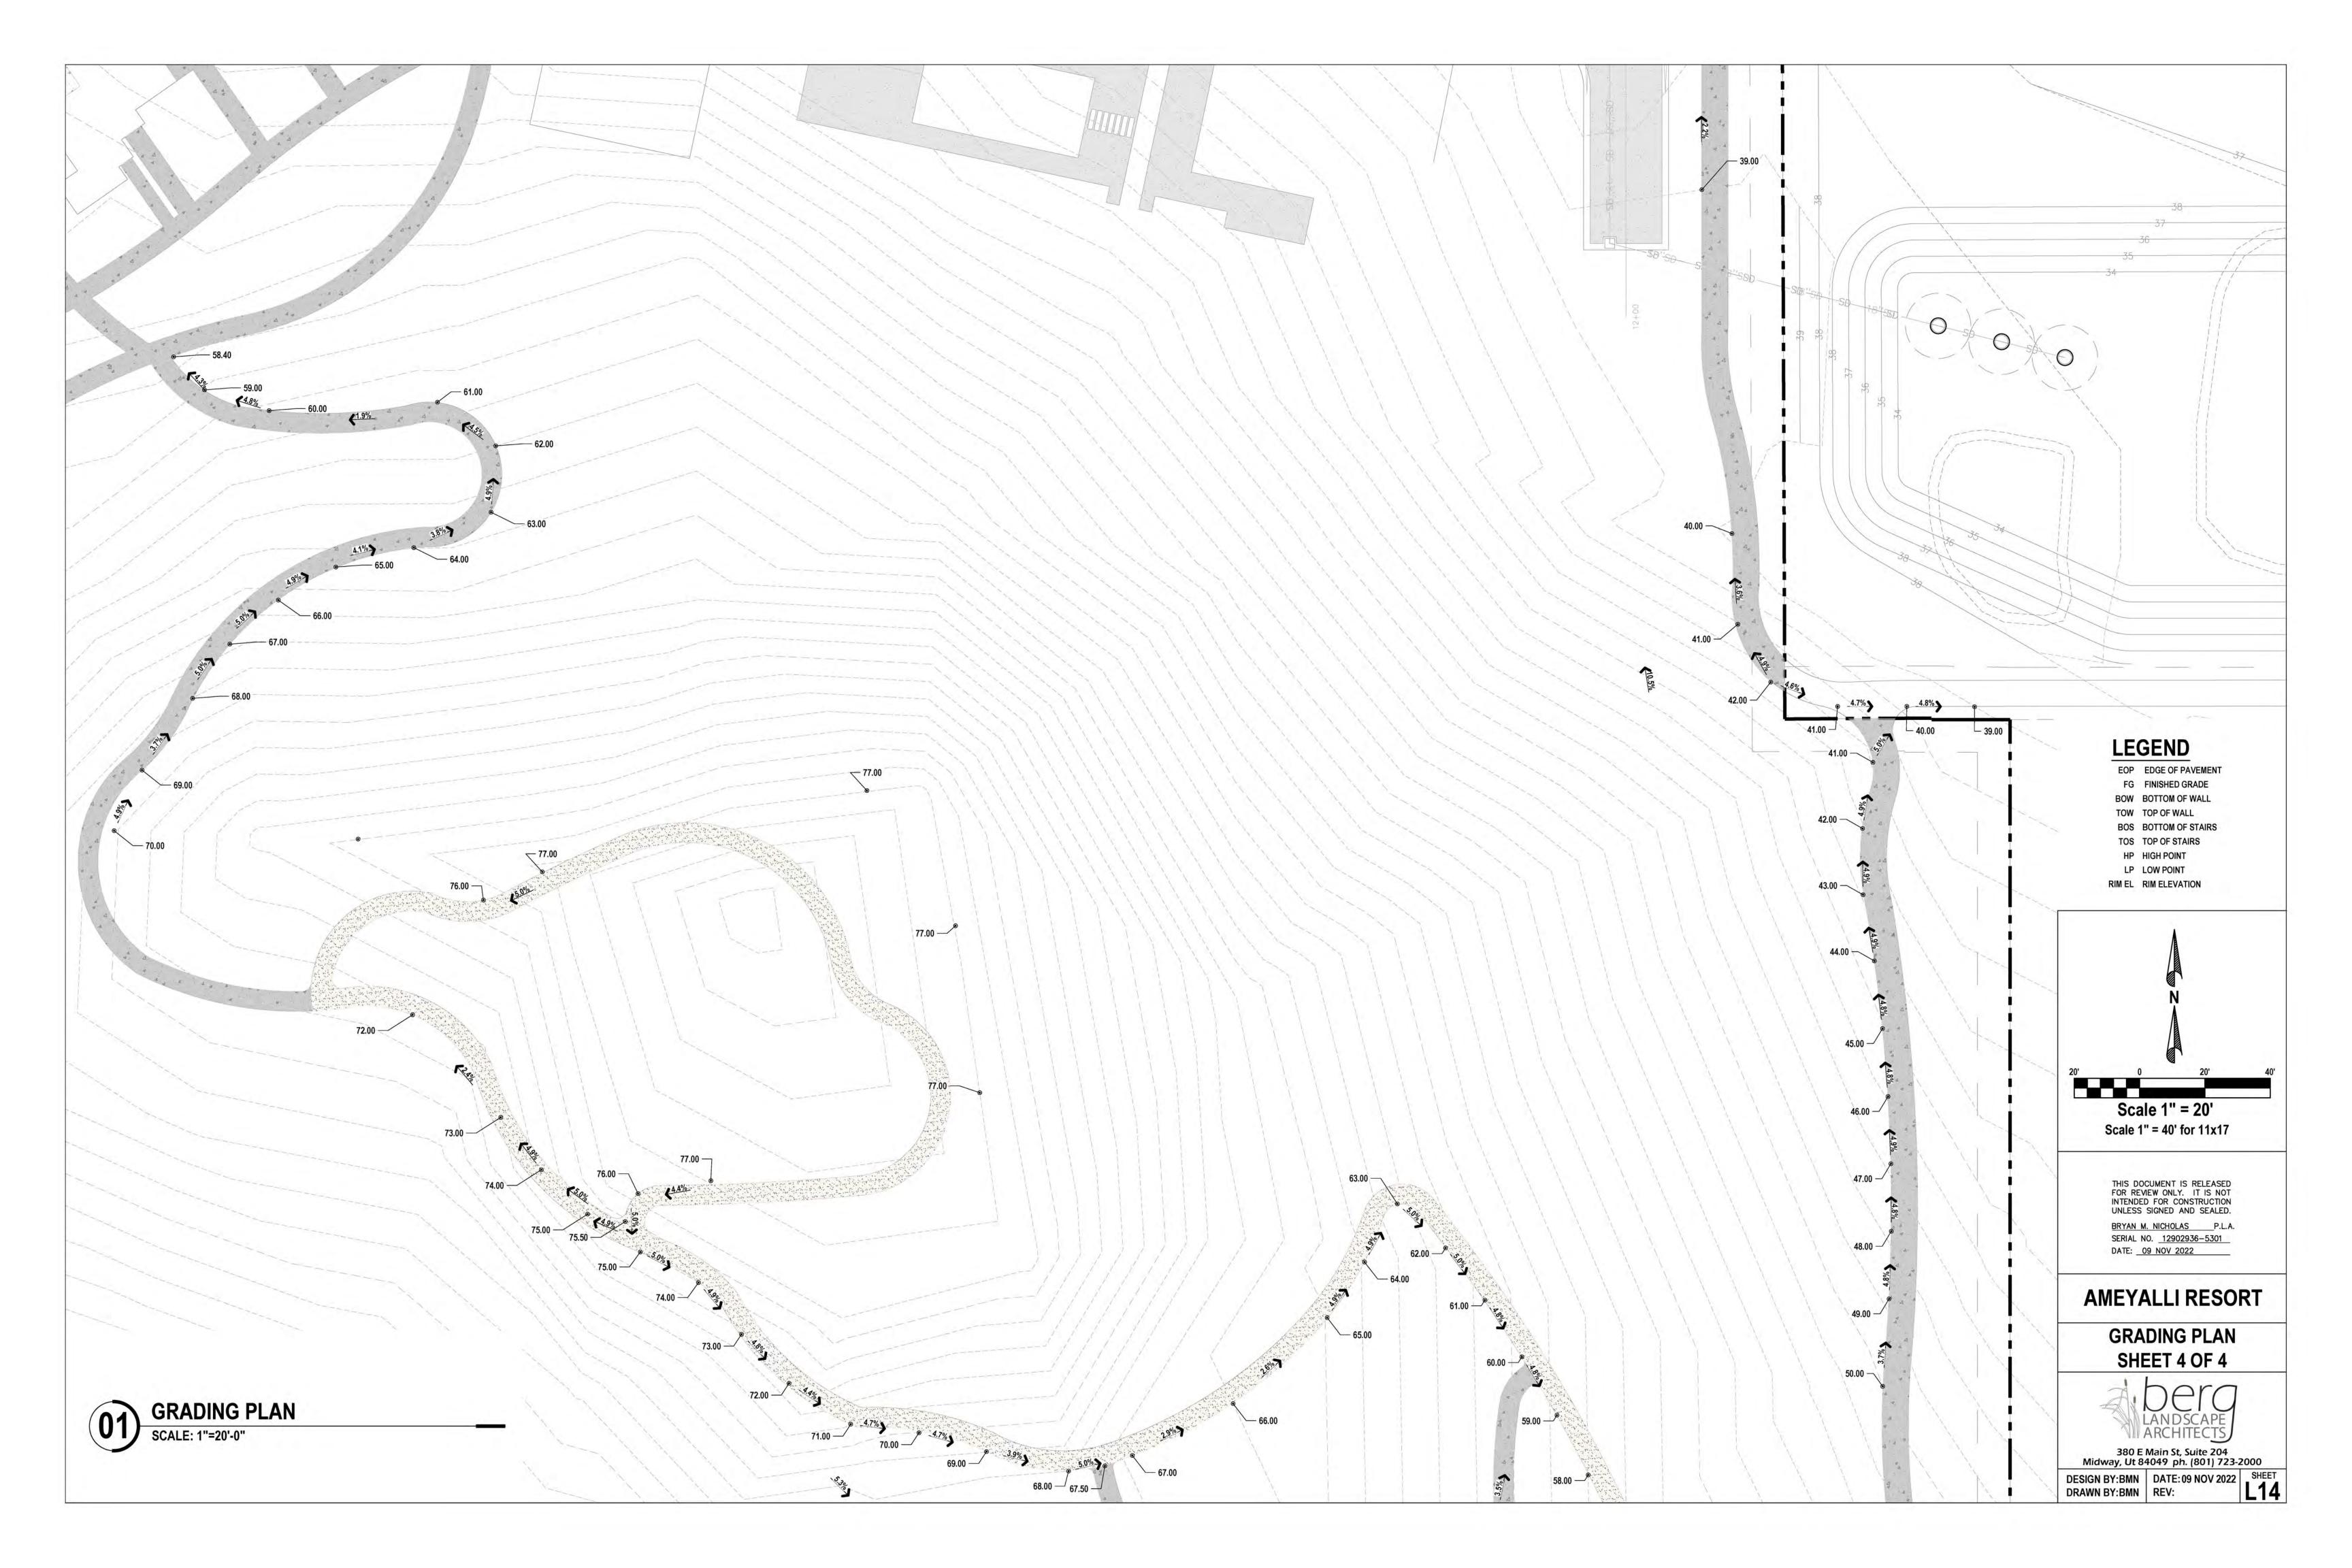PHASE 1 : DUPLEX A






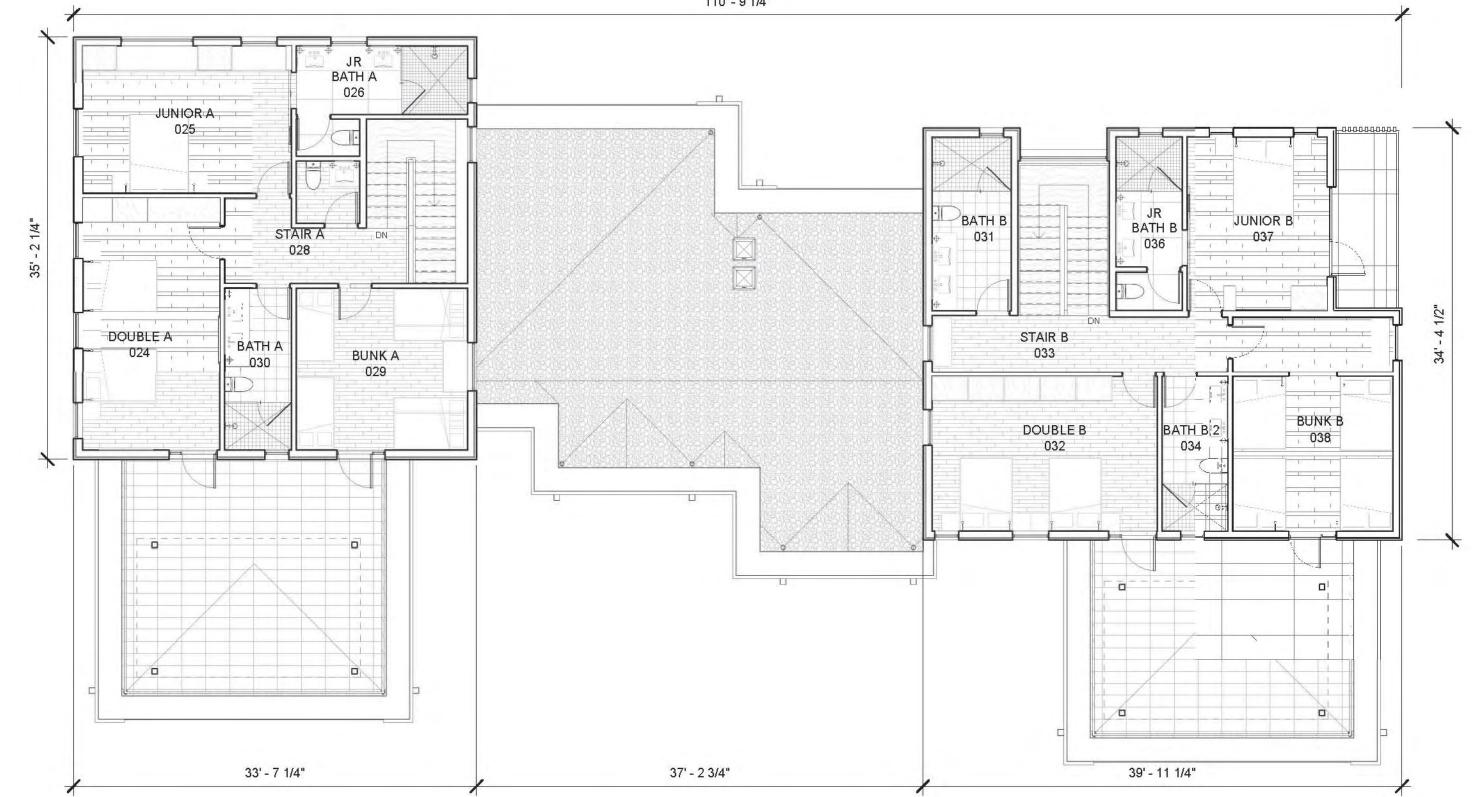



LEVEL 02

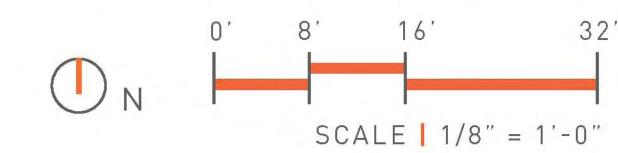

BUILDING AREA PLAN AND DESIGN ELEMENTS I



BUILDING AREA PLAN AND DESIGN ELEMENTS

PHASE 1: FAMILY LODGE

